REQUEST FOR COMMITTEE ACTION

HENDERSON COUNTY

TECHNICAL REVIEW COMMITEE

MEETING: TRC 12-19-23

SUBJECT: Major Site Plan - Fire Department Addition

PRESENTER: Matt Champion

ATTACHMENTS: Staff Report & Site Plan

SUMMARY OF REQUEST: Major Site Plan review for SR 5.10 Fire and Rescue Station

SUGGESTED MOTION:

I move to approve/deny the major site plan for EHSFD Station 4 addition.



Henderson County, North Carolina Code Enforcement Services

1. Committee Request

1.1. **Applicant:** Etowah Horse-Shoe Volunteer Fire Department

1.2. **Request:** Major Site Plan Review


1.3. **PIN:** 9529-20-07311.4. **Size:** 4.16 Acres

1.5. Location: 744 Brickyard Rd across from W Fairway Dr

1.6. Supplemental Requirements:

SR 5.10. Fire and Rescue Station

- (1) Site Plan. Major Site Plan required in accordance with §42-330 (Major Site Plan Review).
- (2) Lighting. *Adequate lighting* shall be placed in areas used for vehicular/pedestrian access including, but not limited to: stairs, sidewalks, crosswalks, intersections, or changes in grade. *Lighting mitigation* required.
- (3) Accessibility. Roads shall be maintained for motor/emergency vehicle access.
- (4) Operations. No drills are to be held before 8:00 a.m. or after 10:00 p.m. on an existing *residential zoning district*. No fire trucks or other emergency *vehicles* are to be permanently stored outdoors.

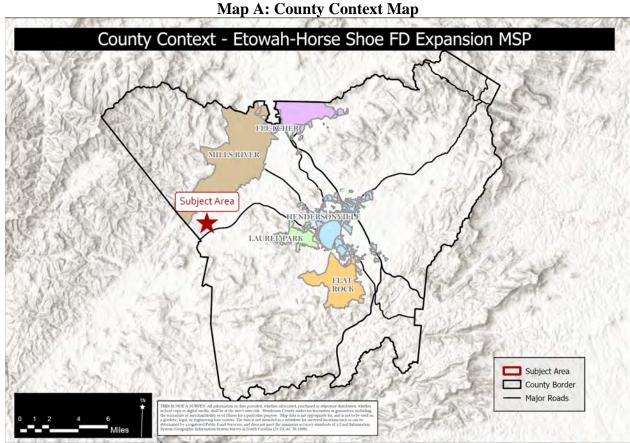

Property Owner/Applicant: Etowah-Horse Shoe Volunteer Fire Department Assessed Acreage: 4.16 Acres PIN: 9529-20-0731




2. History & Characteristics:

2.1. <u>Current Property Owners:</u> Etowah Horse-Shoe Volunteer Fire Department property was purchased, and current building completed in 2009.

2.2. Natural Resources:

- **2.2.1. Streams:** The subject property has an unknown tributary on the southern portion of the parcel.
- **2.2.2. Slopes:** The subject area contains slopes between 0% to 16% with small area of slopes between 16% and 25% on its southern portion. There is a small area where slopes are greater than 25%.

Map B: Aerial Map

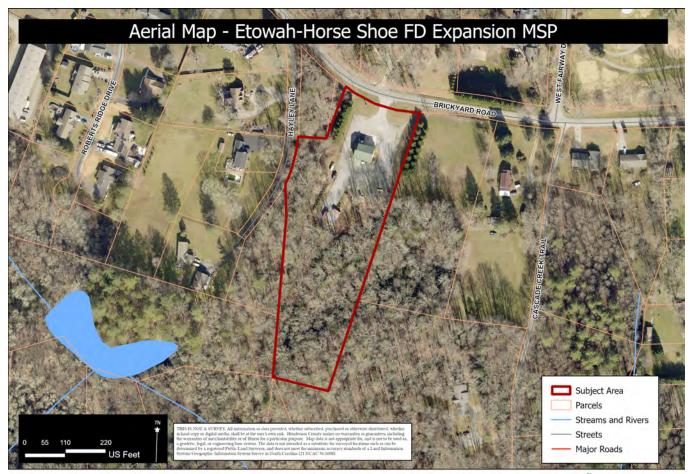

Property Owner/Applicant: Etowah-Horse Shoe Volunteer Fire Department Assessed Acreage: 4.16 Acres PIN: 9529-20-0731



- 3.1. **Current Use:** The subject area is currently a Fire and Rescue substation.
- 3.2. Adjacent Area Uses: The surrounding properties contain residential uses.

Map C: Zoning Map


Property Owner/Applicant: Etowah-Horse Shoe Volunteer Fire Department

Assessed Acreage: 4.16 Acres PIN: 9529-20-0731



- **3. Zoning** The subject area is located within the Residential Two (R1) zoning district.
 - 3.1 **Residential Purpose**. The purpose of Residential District One (R1) is to foster orderly growth where the *principal use* of land is residential. The intent of this district is to allow for medium to high-density *residential development* consistent with the recommendations of the *Comprehensive Plan*. This general *use district* is typically meant to be utilized in areas designated as Urban (USA) in the *Comprehensive Plan*.
 - 3.2 **Adjacent Zoning:** Residential Two (R1) surrounds the subject area.

Map D: Public Utilities Map

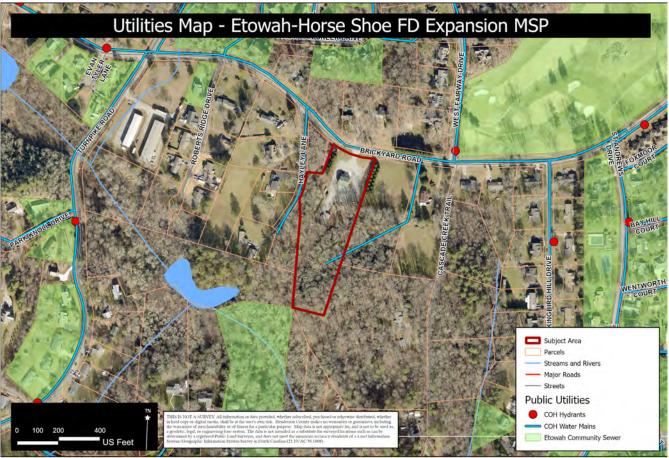

Property Owner/Applicant: Etowah-Horse Shoe Volunteer Fire Department

Assessed Acreage: 4.16 Acres PIN: 9529-20-0731

Current Zoning: Residential One (R1)



- **4.** <u>Floodplain /Watershed Protection</u> The subject area is not in the 100-year Special Flood Hazard Area. The property is not in a Water Supply Watershed district. There is an unknown tributary on the southern portion of the property.
- 5. <u>Water and Sewer</u> This property will be served by Hendersonville Water and Etowah Sewer.

Public Water: City of Hendersonville **Public Sewer:** Etowah Sewer Company

Map E: CCP Future Land Use Map



Property Owner/Applicant: Etowah-Horse Shoe Volunteer Fire Department

Assessed Acreage: 4.16 Acres PIN: 9529-20-0731

Current Zoning: Residential One (R1)



Map F: Growth Management Strategy



Property Owner/Applicant: Etowah-Horse Shoe Volunteer Fire Department

Assessed Acreage: 4.16 Acres PIN: 9529-20-0731



6. The Henderson County Comprehensive Plan (CCP) The CCP Future Land Use Map identifies the subject area as being in Rural/Urban Transition Community (See Map E).

Rural Transition Area: The CCP states that, "The Urban Services Area is that area within which most urban services and urban- scale development is currently concentrated, and within which such development should generally be concentrated through the year 2020." (CCP, Pg. 132).

The Growth Management Strategy map places the subject area in the Rural/Open Space/Agriculture Area..

Proposal The applicant is proposing to expand the existing EHSFD Station #4 substation. The addition will include sleeping quarters and apparatus parking. The existing building square footage is ?? and total new square footage will be ??. The site will have ?? parking spaces and ? van accessible spaces.

8. Photos





Google Street View



OWNER

ROGER FREEMAN, PRESIDENT AND CHAIRMAN ETOWAH HORSESHOE FIRE & RESCUE 3712 BREVARD ROAD ETOWAH HORSESHOE, NC 28791 PHONE: (828) 691-1683 EMAIL: CHIEF@ETOWAHHORSESHOEFIRE.COM

ARCHITECT

THE TAMARA PEACOCK COMPANY ARCHITECTS 104 FIRST AVENUE EAST, SUITE A HENDERSONVILLE, NC 28792 828.696.4000

TAMARA@TAMARAPEACOCK.COM

TAMARA PEACOCK - ARCHITECT

GENERAL CONTRACTOR

CIVIL

STRUCTURAL

PLUMBING

MECHANICAL

ELECTRICAL

FIRE PROTECTION

ETOWAH FIREHOUSE #4

HENDERSONVILLE, NC



279.5 SF

BUILDING DATA

LEVEL OF ALTERATION: LEVEL #1 **BUILDING CONSTRUCTION TYPE:** TYPE #IIB - NON-SPRINKLERED

BUILDING OCCUPANCY TYPE: BUSINESS GOVERMENTAL FIRE DEP. S-2 STORAGE 2364 SF R-2 RESIDENTIAL 711.5 SF

BUILDING SQUARE FOOTAGE NEW WORK SF: TOTAL PROPOSED SF: SITE ACREAGE **TOTAL STORIES**

ADDRESS:

3712 BREVARD RD ETOWAH- HORSESHOE, NC 28791

3084 SF

4.16 acres

9529-20-0731 PROPERTY DESCRIPTION SR1323 ON BRICKYARD RD

PROPERTY OWNER VOLUNTEER FIRE DEPARTMENT

SCOPE OF WORK

LEVEL OF ALTERATION: LEVEL #1


THIS IS A RENOVATION OF EXISTING FIRE STATION BUILDING.

THE NEW WORK INCLUDES CONSTRUCTION OF A NEW ONE STORY BUILDING ADJACENT AND CONNECTED TO EXISTING BUILDING


APPLICABLE CODES

2018 NORTH CAROLINA BUILDING CODE 6TH EDITION 2018 NORTH CAROLINA MECHANICAL CODE 6TH EDITION 2020 NFPA 70 NATIONAL ELECTRIC CIDE 2018 NORTH CAROLINA STATE ENERGY CODE 2018 NORTH CAROLINA PLUMBING CODE 6TH EDITION

SITE MAP

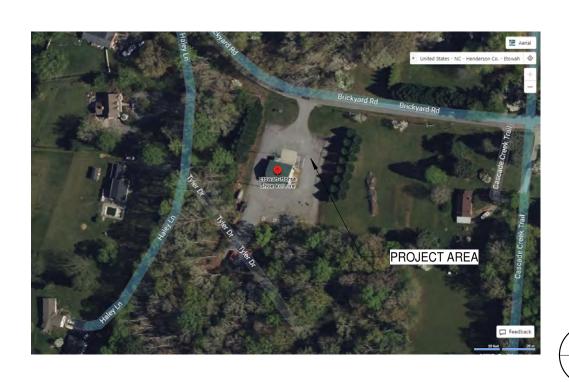

VICINITY MAP

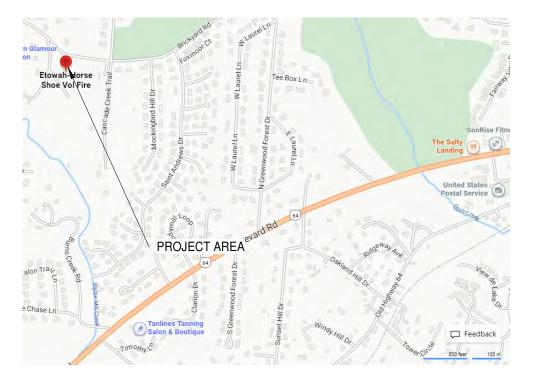



MICHAEL HUGGINS, FIRE CHIEF ETOWAH HORSESHOE FIRE & RESCUE

THE TAMARA

architects (0)

104 FIRST AVENUE EAST, SUITE A HENDERSONVILLE, NC 28792

THE TAMARA PEACOCK CO. ARCHITECTS

PEACOCK


COMPANY

PHONE: 828.696.4000

PROJECT DESIGN TEAM:

104 FIRST AVENUE EAST, SUITE A HENDERSONVILLE, NC 28792 PH: 828-696-4000

ETOWAH FIREHOUSE #4 23-021 744 Brickyard Rd, **Etowah, NC 28729**

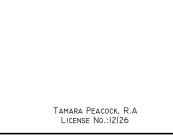

ISSUED FOR:
SCHEMATIC DESIGN

5/23/2023

SHEET NAME: COVER SHEET & SHEET INDEX

EVISIONS:	
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REVISED BY:	CAPT.:
20-022	TP

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EDGE OF CURB

EDGE GRAIN

ELEVATION

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EMERGENCY

EMER SHR EMERGENCY SHOWER

ENCLOSURE

EDGE OF SLAB

ENTRANCE

ELASTOMERIC

ELEMENTARY

EXPANSION JOINT

EXTERIOR FINISH SYSTEM

EXTERIOR GYPSUM BOARD

EXTERIOR INSULATION AND FINISH SYSTEM

EXPANDED POLYSTYRENE BOARD (INSULATION)

DISPOSAL

EACH

MFR REC MANUFACTURER'S RECOMMENDATION

MIDDLE

MIL STD MILITARY STANDARD

MINIMUM

MILLWORK

MOP RACK

MICROWAVE

NCOMBL NONCOMBUSTIBLE

NUMBER

NOMINAL

NOT APPLICABLE

NONLOADBEARING

NOTICE TO PROCEED

MOD BIT MODIFIED BITUMEN

MISCELLANEOUS

MOLDING (MOULDING)

MOISTURE RESISTANT

MEMBRANE WATERPROOFING

NOT IN CONTRACT

MIRROR

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WITHOUT

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WAREHOUSE

WAINSCOT

WALK OFF MAT

WASH FOUNTAIN

VERIFY IN FIELD

VINYL WALL COVERING

WATER CLOSET

WATER HEATER

WELDED WIRE FABRIC

EXTRUDED POLYSTYRENE BOARD (INSULATION)

WELDED WIRE MESH

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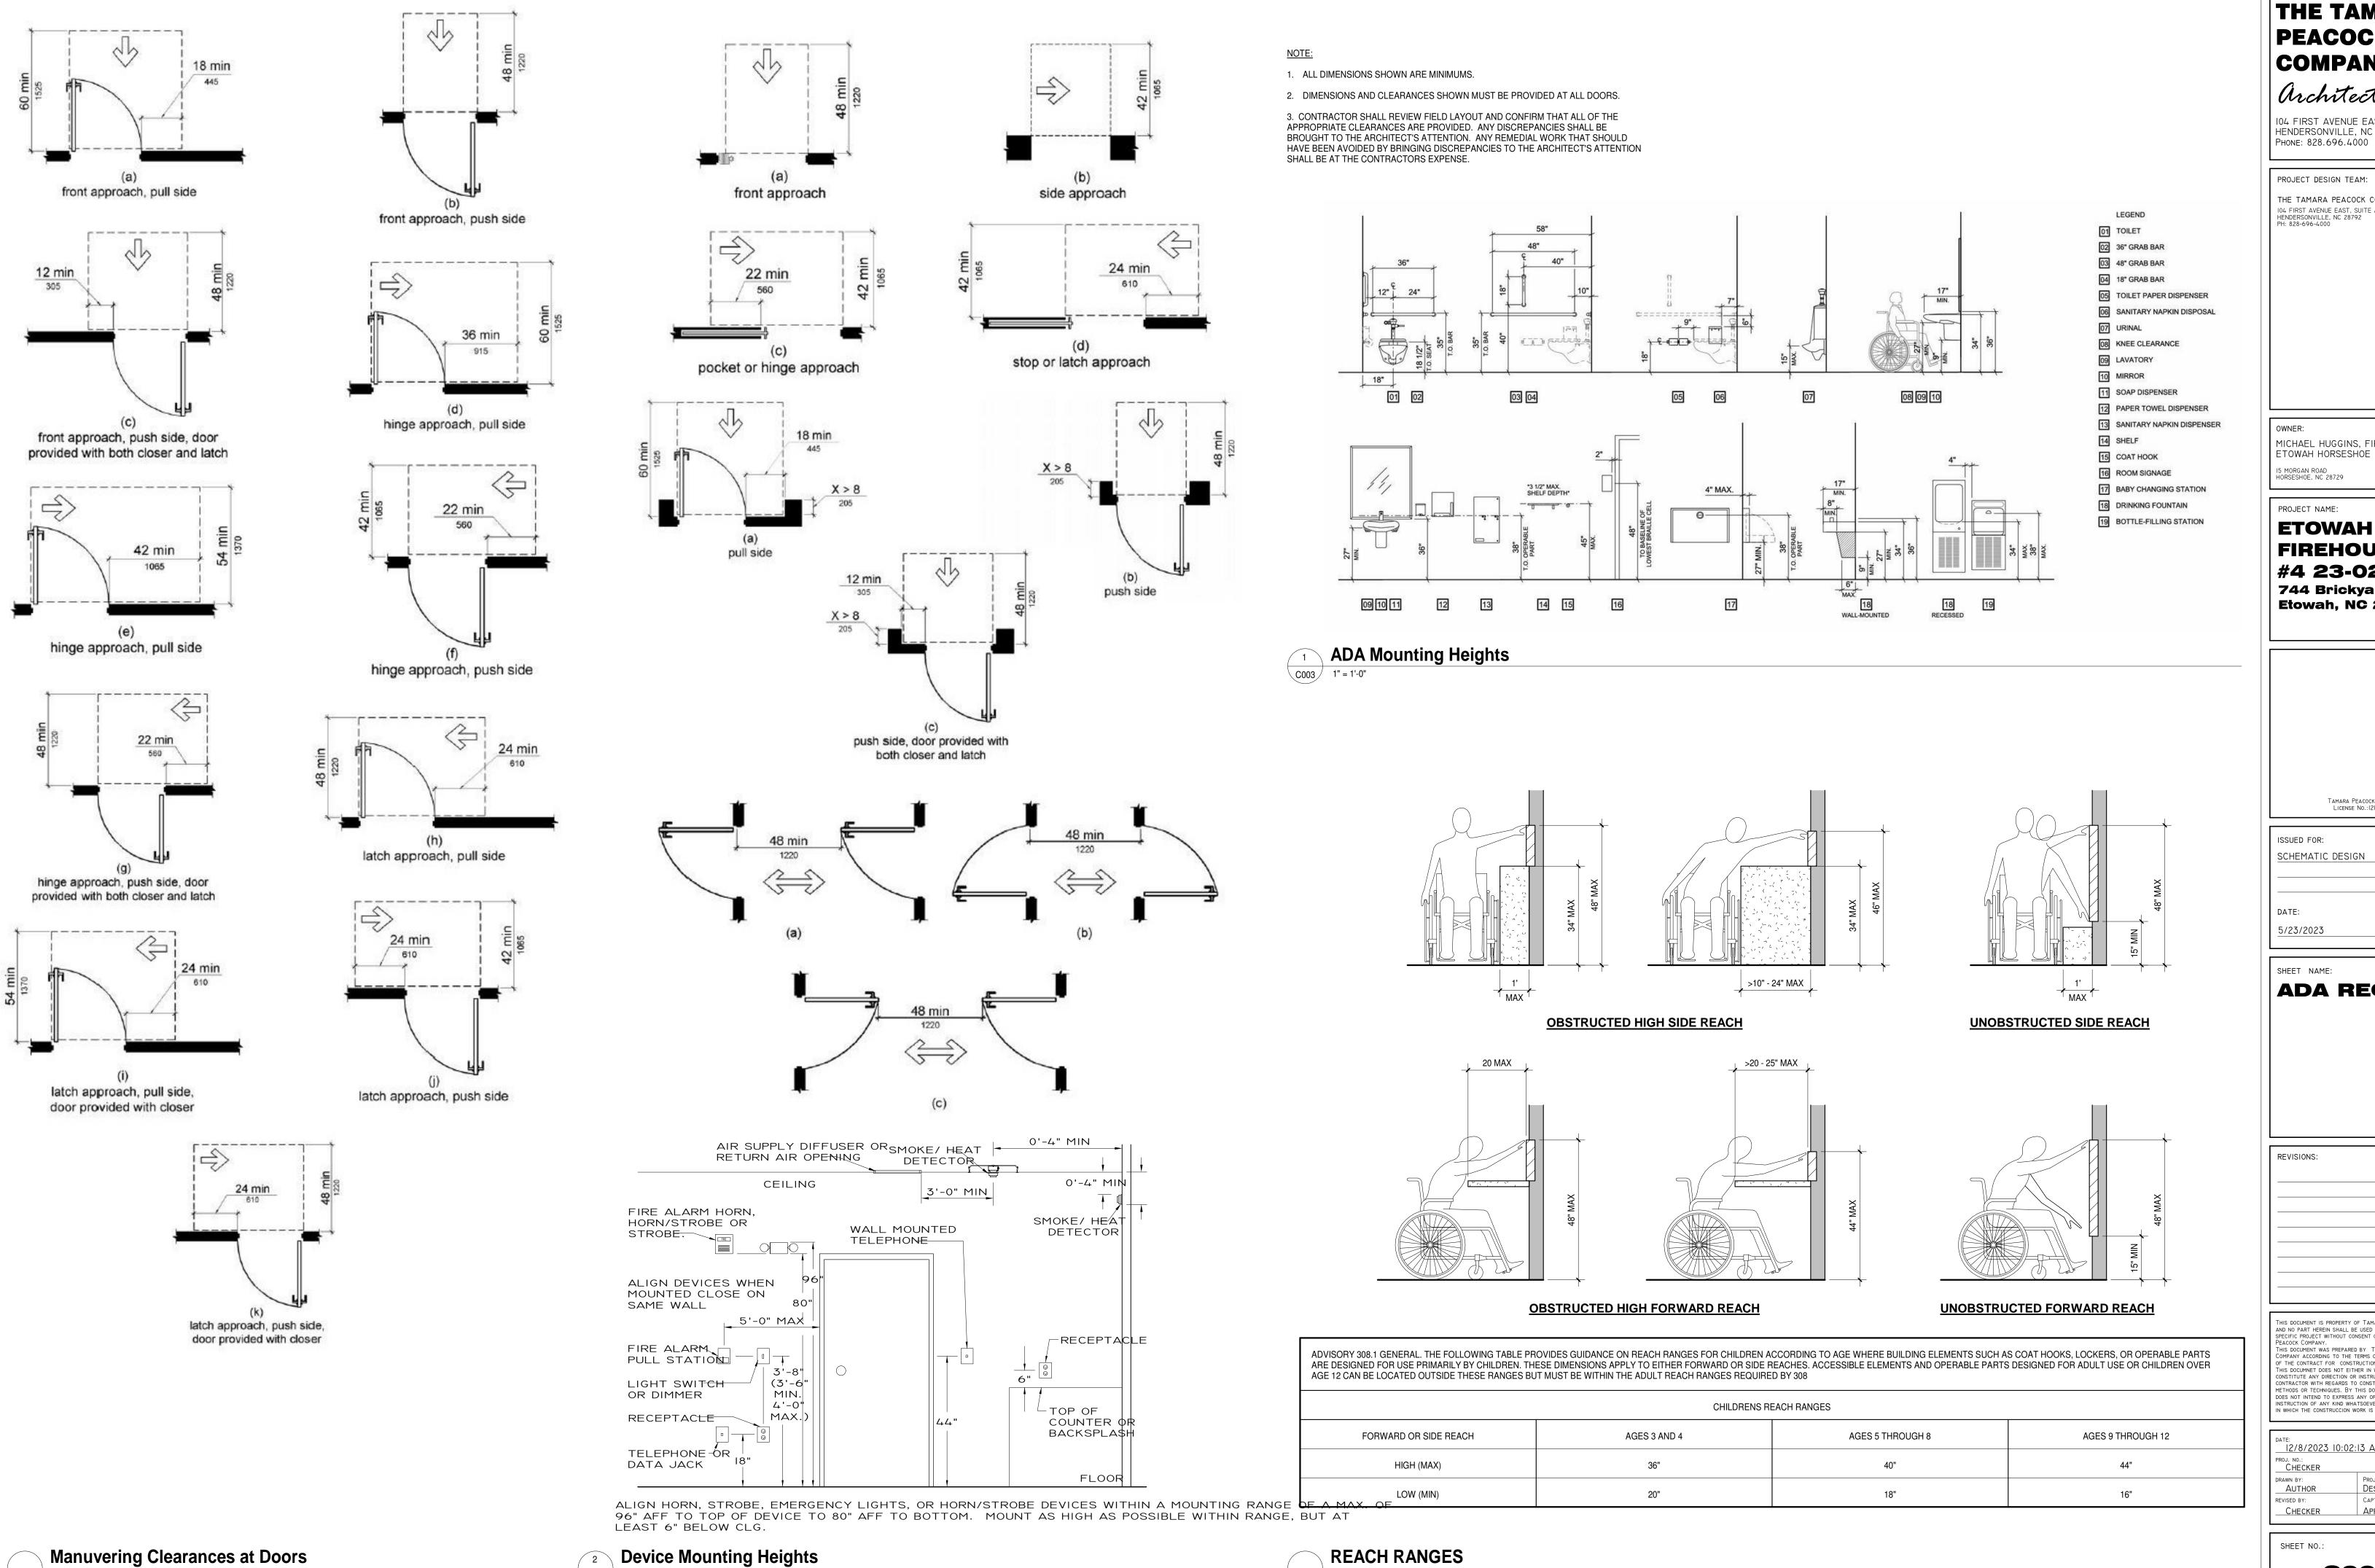
TAMAKA PEACO

THE TAM

ETOWAH
FIREHOUSE #4
744 Brickyard Rd, Etowa

SHEET NO.:

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12/8/2023
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No.:
GOO2



C003 1/4" = 1'-0"

12" = 1'-0"

THE TAMARA PEACOCK COMPANY

Architects (0) 104 FIRST AVENUE EAST, SUITE A HENDERSONVILLE, NC 28792

PROJECT DESIGN TEAM:

THE TAMARA PEACOCK CO. ARCHITECTS 104 FIRST AVENUE EAST, SUITE A HENDERSONVILLE, NC 28792 PH: 828-696-4000

MICHAEL HUGGINS, FIRE CHIEF ETOWAH HORSESHOE FIRE & RESCUE

PROJECT NAME:

ETOWAH FIREHOUSE #4 23-021 744 Brickyard Rd, **Etowah, NC 28729**

TAMARA PEACOCK, R.A

ISSUED FOR: SCHEMATIC DESIGN

SHEET NAME:

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12/8/2023 10:02:13 AM DESIGNER APPROVER

COO3

PROJECT BUILDING CODE SUMMARY

 PROJECT SUMMARY:
 Feasibility and Schematic Design for Etowah-Horseshoe Fire station at 15 Morgan Street

 Project Name:
 ETOWAH FIREHOUSE RE-DESIGN

 Address:
 744 Brickyard Rd, Etowah, NC 28729

 Proposed Use:
 FIRE STATION (BUSINESS, RSIDENTIAL, STORAGE)

 Owner or Authorized Agent:
 Michael Huggins, Fire Chief Etowah Horseshoe Fire & Rescue

 Owned By:
 □ Private
 □ City/ County
 □ State

 Code Jurisdiction:
 ■ HENDERSON COUNTY, NC
 ■ HENDERSON COUNTY, NC

2018 NORTH CAROLINA BUILDING CODE 6TH EDITION
2018 NORTH CAROLINA MECHANICAL CODE 6TH EDITION
2020 NFPA 70 NATIONAL ELECTRIC CIDE
2018 NORTH CAROLINA STATE ENERGY CODE
2018 NORTH CAROLINA PLUMBING CODE 6TH EDITION

NOTE: Refer to other discipline drawings for code summary by those trades

APPLICABLE CODES:

APPLICABLE CODES:

Relocation

OCCUPANCY: SEE LIFE SAFETY PLAN(S) FROM OVERALL OCCUPANT LOADS

cupancy Types:			
Assembly	Factory/ Industrial	Institutional	Residential
— A-1	—☐ F-1	I-1	—_ R-1
— A-2	└── F-2		— ■ R-2
— A-3	☐ High Hazard	I-3 - 3	— □ R-3
—	—☐ H-1	☐ I-4 ☐ 4 ☐ 5	└── R- 4
	—☐ H-2		Storage
Business	—☐ H-3	☐ Utility and	— S-1
☐ Educational	⊢ H- Δ ⊢ H-	Miscellaneous	— ■ S-2
	5		

BUILDING DATA:						
Construction Types:	☐ I-A	☐ II-A	☐ III-A	□ IV	☐ V-A	
	☐ I-B	☐ II-B	☐ III-B		■ V-	
Sprinklers:	■ NO	☐ YES			В	
Standpipes:	☐ NO	☐ YES				
Buildin Height:	aprox	. 39'-0"	2 stories		Jnlimited	
Code Jurisdiction:	■ HEND	DERSON CO	UNTY, NC			

	Type of Construction (Type VB)	
Fire Seperation Distanct in Feet	Occupancy B,S2,U	Notes
X < 5'	1	
5 < X < 10	1	
10 < X < 30	0	
> 30	0	

	Al	llowable	<i> </i>	Actual
Type of Construction	Туре	VB	Туре	VB
Building Height in Feet	Feet	40'-0"	Feet	23'-6"
Building Height in Stories	Stories	2	Stories	1

TABLE 601 - FIRE-RESISTANCE RATING REQUIREMENT FOR BUILDING ELEMENTS (HOURS)						
	Rating	(Type IIIA)				
Building Element	Req'd*	Design # for Rated Assembly	Notes			
Primary Structural Frame	0	-				
Bearing Walls Exterior	0	-				
Bearing Walls Interior	0	-				
Nonbearing Walls Exterior	see 602	-				
Nonbearing Walls Interior	0	-				
Floor Construction, and associated secondary members	0	-				
Roof construction, and associated secondary members	0	-				

TABLE 803.9 INTERIOR WALL AND CEILING FINISH REQUIREMENTS (SPRINKLERED)						
Use and Description Int Exit Stairs, Ramps & Corridors & Enclosures for Rooms & Exit Access Stairways & Enclosed Space Ramps						
		B - Business	В	С	С	
MAIN	LEVEL / SECOND FLOOR	S2 - Enclosed Parking	С	С	С	
		B - Business	В	С	NA	

FIRE EXTINGUISHERS FOR CLASS A FIRE HAZARDS				
Minimum Rated Single Extingusher	2A			
Maximum Floor Area Per Unit of A	3,000 sqft			
Maximum Floor Area for Extinguisher	11,250 sqft			
Maximum Travel Distance to Extinguisher	75 feet			

	(a)	(b)	(a/b)
Use Group or Space Description	Area ¹ SQ. FT.	Area Per Occupant (Table 1004.1.2) 1	Number of Occupants
First Floor (total)	2,623 sf		
BUSINESS (DAY ROOM)	163 sf	100 GROSS	1
BUSINESS (KITCHENETTE)	162 sf	100 GROSS	1
STORAGE (TRUCK BAY)	1508 sf	200 GROSS	7
STORAGE (TRUCK BAY)	487 sf	200 GROSS	2
RESIDENTIAL (BEDROOM)	124 sf	120 GROSS	1
RESIDENTIAL (BEDROOM)	124 sf	120 GROSS	1
Second Floor or Mezzanine? (total)	243 sf		
BUISNESS (TV ROOM)	243 sf	100 GROSS	2
	Building Occ	upancy	15

		d Width per floor stion 1005.1) (a/b) x c		
Stair	Level	Stair Level		
0.3	0.2	0.6" 1.4"		
Greatest required width per floor			Section 1011.2 minimums apply	
		_	m width of stair sh um clear door wid	

See definition "Area, Gross" and "Area, Net"
 Minimum stairway width (Section 1009.1); min. corridor width (Section 1017.2); min. door width (Section 1008.1.1)
 Minimum width of exit passageway (Section 1021.2)
 Assembly occupancies (Section 1028)

MINIMUM NUMBER OF REQUIRED PLUMBING FIXTURES -

PLUMBING FIXTURE COUNTS ARE BASED ON THE TOTAL OCCUPANT LOAD AS PER IBC SECTION 1004 - OCCUPANT LOAD, IBC TABLE 2902.1 & IBC 2902.1.1 - FIXTURE CALCULATIONS TOTAL OCCUPANCY: 15

(B) BUSINESS: 4 OCC. (R) RESIDENTIAL: 2 OCC. (S) STORAGE: 9 OCC.

CODE REQUIRED	wc	LV	TUB/ SHOWER	DRINKING FOUNTAIN	SERVICE SINK
BUSINESS	1 PER 25 FOR 1ST 50 1 PER 50 FOR 50+	1 PER 40 FOR 1ST 80 1 PER 80 FOR 80+	-	1 PER 100	1
RESIDENTIAL	1 PER 10	1 PER 10	1 PER 8	1 PER 100	1
STORAGE	1 PER 100	1 PER 100	-	1 PER 1,000	1

REQUIRED FIXTURES	wc	LV	TUB/ SHOWER	DRINKING FOUNTAIN	SERVICE SINK
BUSINESS	1	1	-	1	1
RESIDENTIAL	1	1	1	1	1
STORAGE	1	1	-	1	1
TOTAL REQUIRED	1	1	1	1	1
TOTAL PROVIDED	1	1	1	1	1

EXIT REQUIREMENTS

Floor		DF EGRESS TRAVEL Distance
	Allowable Travel Distance (Table 1017.2)	Actual Travel Distance
BUSINESS	300 FT	
RESIDENTIAL	250 FT	
STORAGE	400 FT	

LIFE SAFETY SYSTEM REQUIREMENTS

Emergency Lighting:

Exit Sign:

Fire Alarm:

Emergency Voice/Alarm

Communication System:

Smoke Detection Systems:

Smoke Control System:

Panic Hardware:

No

Yes

Yes

No

Yes

Yes

BUILDING ENVELOPE REQUIREMENTS
INFORMATION BASED ON IECC 2009 (CLIMATE ZONE 3A), TABLE 301.1, TABLE 502.2(1), TABLE 502.3

INSULATION VALUES - ALL GROUP 'A' OCCUPANCIES

ROOF (ATTIC AND OTHER):

R-38

U-FACTOR:

WALLS. ABOVE GRADE:
(WOOD FRAMED)

WALLS, BELOW GRADE:

WOOD FLOOR TRUSS FLOORS:

SOG FLOORS:

OPAQUE DOORS

SWINGING:

WALLS. ABOVE GRADE:

R-13

METAL FRAMING WITH OR WITHOUT THERMAL BREAK
CURTAIN WALL / STOREFRONT U-FACTOR:
ENTRANCE DOOR U-FACTOR:
ALL OTHER U-FACTOR:
SHGC (SEE IECC, TABLE 502.3)
PF < .25

PF < .25 .25 < PF < .5 PF > .5 0.65

0.60

0.90

0.65

0.25

0.33

_0.40__

THE TAMARA
PEACOCK
COMPANY

104 FIRST AVENUE EAST, SUITE A HENDERSONVILLE, NC 28792

PHONE: 828.696.4000

PROJECT DESIGN TEAM:

THE TAMARA PEACOCK CO. ARCHITECTS
104 FIRST AVENUE EAST, SUITE A
HENDERSONVILLE, NC 28792
PH: 828-696-4000

OWNER:
MICHAEL HUGGINS, FIRE CHIEF
FTOWAH HORSESHOE FIRE & RES

MICHAEL HUGGINS, FIRE CHIEF ETOWAH HORSESHOE FIRE & RESCUE 15 MORGAN ROAD HORSESHOE, NC 28729

FROJECT NAME:

ETOWAH
FIREHOUSE
#4 23-021
744 Brickyard Rd,
Etowah, NC 28729

TAMARA PEACOCK, R.A LICENSE NO.:12126

DATE:

SCHEMATIC DESIGN

DATE: 5/23/2023

ISSUED FOR:

SHEET NAME:

CODE
SUMMARY

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SHEET NO.:

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THE TAMARA PEACOCK COMPANY

Orchitects

104 FIRST AVENUE EAST, SUITE A
HENDERSONVILLE, NC 28792
PHONE: 828.696.4000

PROJECT DESIGN TEAM:

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HENDERSONVILLE, NC 28792
PH: 828-696-4000

OWNER:
MICHAEL HUGGINS, FIRE CHIEF
ETOWAH HORSESHOE FIRE & RESCUE

PROJECT NAME:

ETOWAH
FIREHOUSE

#4 23-021
744 Brickyard Rd,
Etowah, NC 28729

TAMARA PEACOCK, R.A LICENSE NO.:12126

ISSUED FOR:

SCHEMATIC DESIGN

5/23/2023

SHEET NAME:
SITE PLAN
DEMO
WORK

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SHEET NO.:

SP100




NEW WORK SITE PLAN

SP101 3/64" = 1'-0"

S 85° 34'02" E 99.80'

TRUE NORTH

NEW WORK OVERALL SITE PLAN

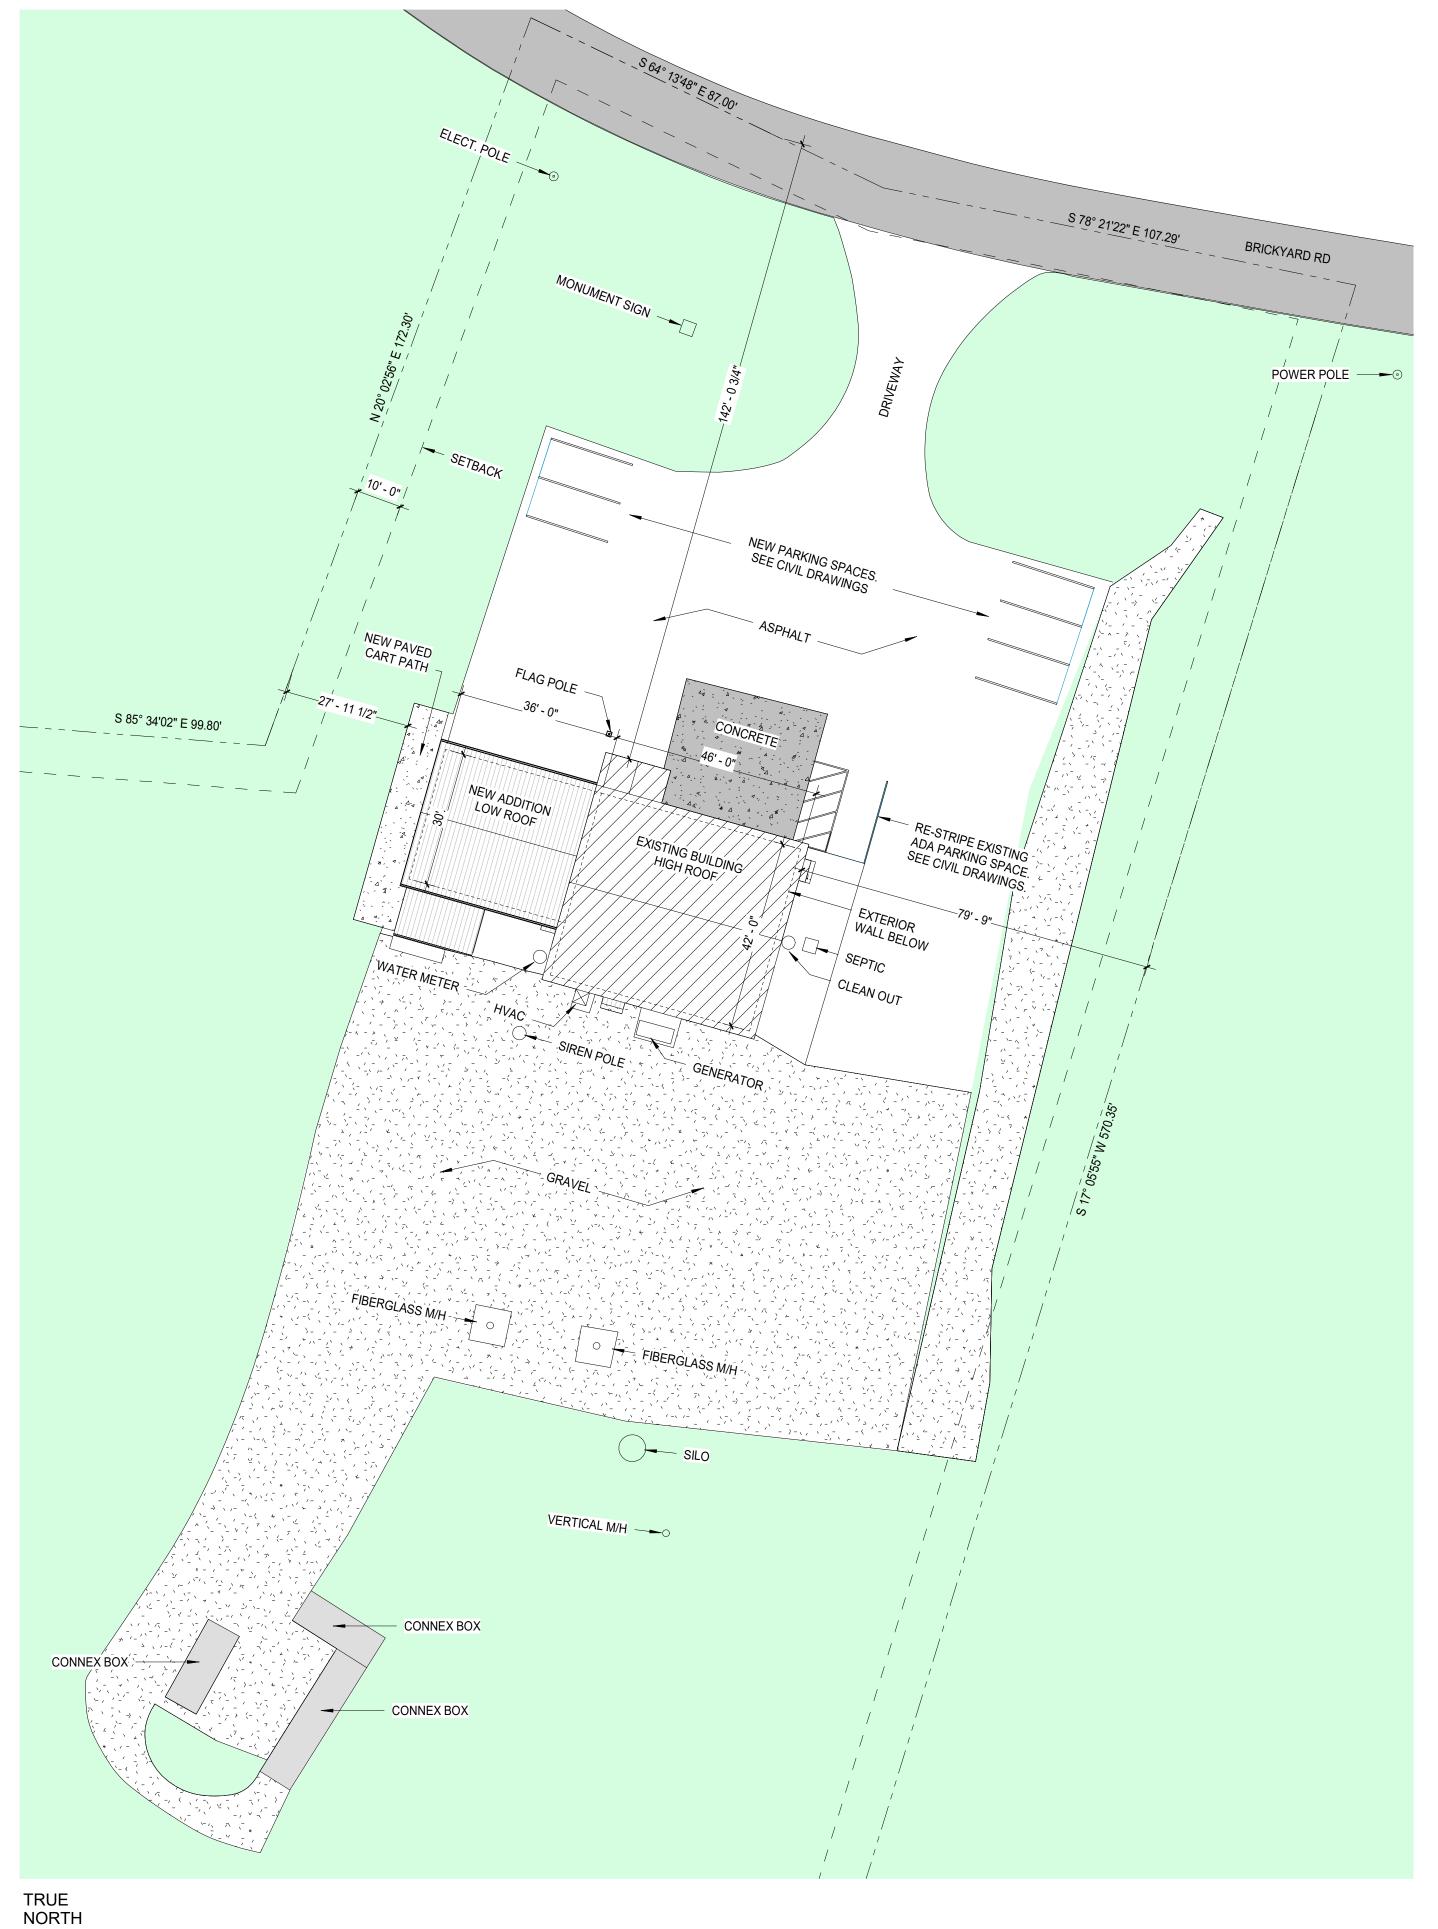

ZONING LEGEND		
A - SITE DATA		
ZONING DISTRICT	R2 RESIDENTIAL	
OUTE ADEA	20,000,05	
SITE AREA	69,696 SF	
B - SITE COMPOSITION (LC)	REQUIRED	PROVIDED
SITE AREA	N/A	69,696 SF
BUILDING AREAS (LOT COERAGE)	80,000	18,212 SF
TOTAL PAVED AREAS	MAX 80%	77.7%
TOTAL OPEN LANDSCAPED AREA	N/A	22.3%
C - SETBACKS (LC)	REQUIRED	PROVIDED
FRONT SETBACK BREVARD RD	50' - 0"	50' - 9"
SIDE SETBACK	10' - 0"	80' - 0"
REAR SETBACK	10' - 0"	N/A
D - BLDG. HEIGHT (LC)		
MAXIMUM HEIGHT ALLOWED	40' - 0"	40' - 6"

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Etowah, NC 28729

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SCHEMATIC DESIGN

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SHEET NAME:
SITE PLAN
NEW WORK

REVISIONS:

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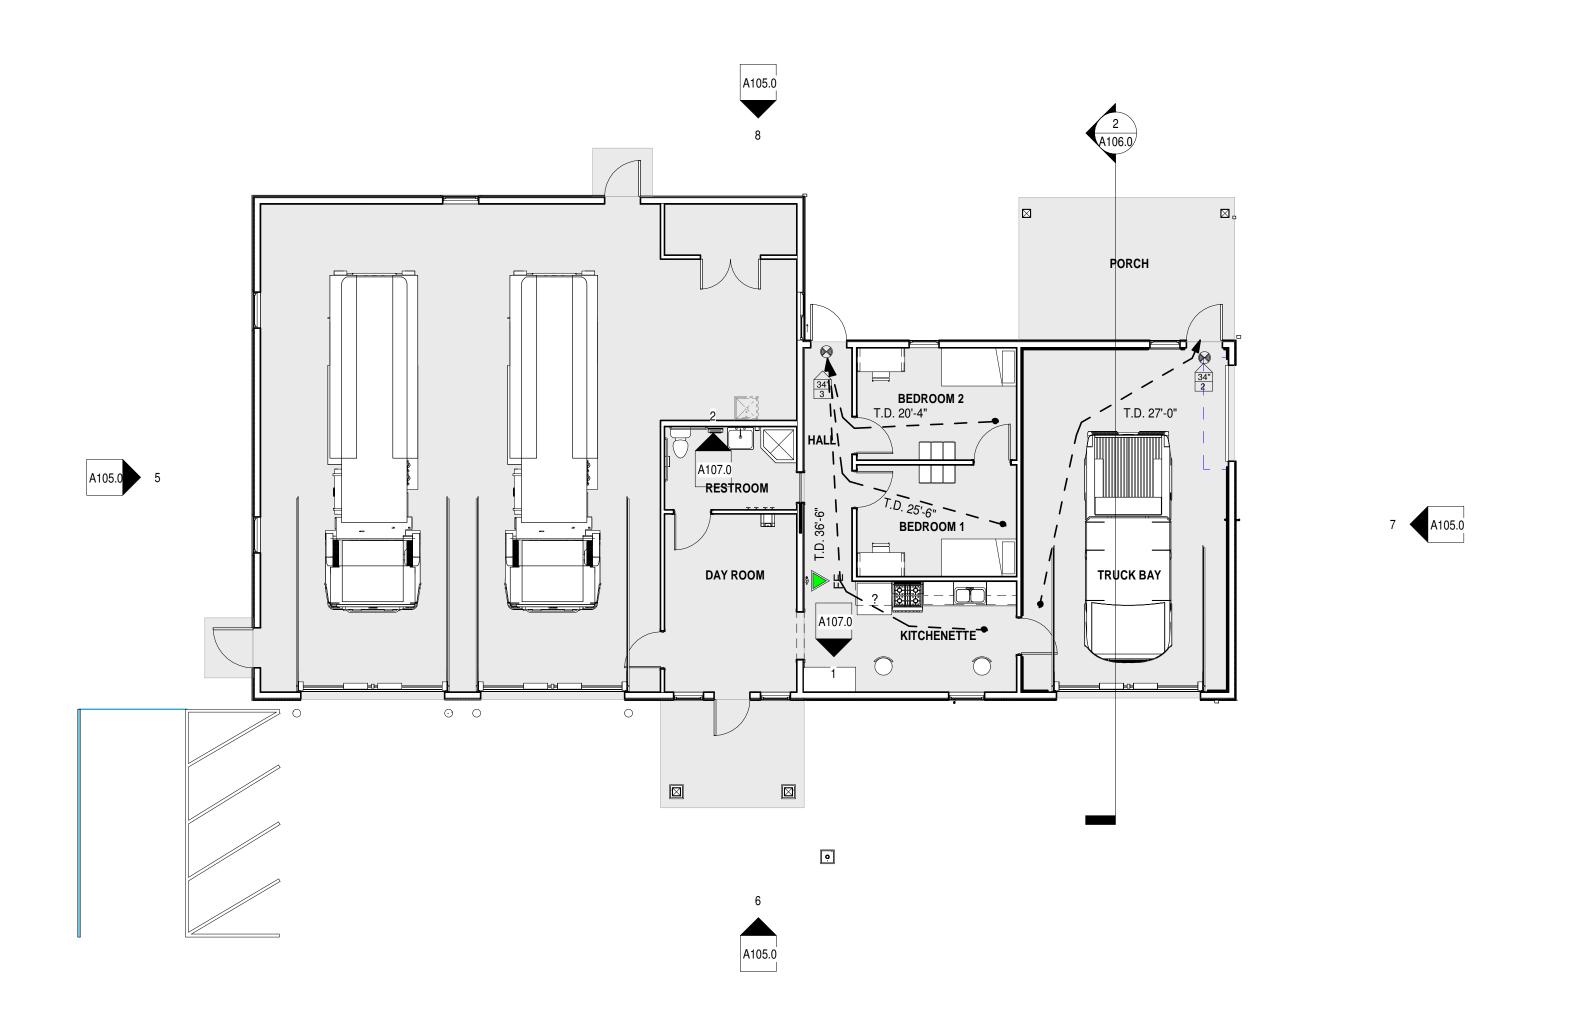
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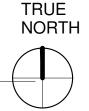
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	REVISED BY:	CAPT.: TP

SHEET NO.:

SP101







FIRE RATING AND FIRE PROOFING NOTES: 1. SEE FLOOR PLAN(S) AND WALL TYPE SCHEDULE FOR WALL ASSEMBLY TYPES AND CONSTRUCTION

2. FIRE CAULK AROUND ALL ELECTRICAL CONDUIT PASSING THROUGH WALLS.

3. SEE MECHANICAL AND PLUMBING DRAWINGS FOR SPECIAL DETAILS WHERE DUCTWORK AND PIPING PASS THROUGH WALLS.

4. REFER TO SHEET GXX.XX FOR GENERAL FLOOR, ROOF, AND STRUCTURAL RATING REQUIREMENTS AND RELEVANT PROPOSED PROTECTION SYSTEMS.

LIFE	SAFETY LEGEND
\$	WALL MOUNTED STROBE LIGHT
FE ©	BRACKET MOUNTED FIRE EXTINGUISHER
FEC	RECESSED OR SEMI-RECESSED FIRE EXTINGUISHER CABINET
┌>	EGRESS PATH OF TRAVEL
⊢ S Ç	WALL MOUNTED EXIT LIGHT PHOTOLUMINESCENT. IN ACCORDANCE WITH UL924 AND NCBC 1013.5
$\overset{\rightarrow}{\bigotimes}$	CEILING MOUNTED EXIT SIGN (ARROWS WHEN INDICATED)
$\uparrow \bigcirc \!$	WALL MOUNTED EXIT SIGN (ARROWS WHEN INDICATED)
	1/2-HOUR FIRE RATED WALL
	DOOR EXIT OCCUPANT LOAD
(200 36 240)	■ DOOR EXIT OCCUPANT CAPACITY
	DOOR CLEAR EXIT WIDTH (IN INCHES)

OCCUPANCY CALCULATION:

AREA	FUNCTION OF SPACE	SQ FT	OCCUPANT LOAD FACTOR TABLE 1004.1.2	OCC. PER AREA	TOTAL OCC.
GARAGE 1	APPARATUS BAYS	3142 SQ FT	500 gross	7	9
	LOCKER ROOM	85 SQ FT	50 gross	2	
OFFICE AREA	ACC. STORAGE	596 SQ FT	300 gross	2	4
	BUSINESS AREA	216 SQ FT	100 gross	2	
M BAY	REPAIR GARAGE	797 SQ FT	500 gross	2	6
	STORAGE + MEZZANINE	961 SQ FT	300 gross	4	
2ND FLOOR	SLEEPING AREAS	1272 SQ FT	120 gross	11	20
	RESIDENTIAL	1438 SQ FT	200 gross	8	
	ACC. STORAGE	154 SQ FT	300 gross	1	

OCCUPANCY NOTES:

TOTAL NEW BUILDING OCCUPANCY

1. INTERIOR ROOMS WITH ONE ENTRANCE/EXIT MEET OCCUPANCY REQUIREMENTS FROM TABLE 1006.2.1 OF SPRINKLERED BUILDING. 2. BUILDING IS SPRINKLERED

3. OCCUPANCY RATES METHOD OF CALCULATION: TOTAL SQ. FT. FOR FUNCTION OF SPACE / OCCUPANT LOAD FACTOR 4. COMMON PATH OF TRAVEL LIMIT = 100' (NFPA 101: TABLE 5.5.1.8)

5. ALL EGRESS DOORS ARE MIN 32" CLEAR

FIRE EXTINGUISHER COUNT							
AREA	SF	REQUIRED PER AREA	PROVIDED PER AR				
GARAGE 1	3296 S.F.	1:3000 S.F.	2				
OFFICE AREA	1334 S.F.	1:3000 S.F.	1				

· · · · · ·			
GARAGE 1	3296 S.F.	1:3000 S.F.	2
OFFICE AREA	1334 S.F.	1:3000 S.F.	1
M BAY	1308 S.F.	1:3000 S.F.	1
2ND FLOOR	3258 S.F.	1:3000 S.F.	2
MEZZANINE	457 S.F.	1:3000 S.F.	1

NOTE: AS PER NCBC TABLE 906.3 (1), THE MAXIMUM DISTANCE OF TRAVEL TO EXTINGUISHER IS 75 FT.

EGRESS DATA

ROOM / BAY	MAX TRAVEL DISTANCE
GARAGE 1	86' - 2"
И ВАҮ	68' - 2"
ND FLOOR RESIDENTIAL	83' - 6"
ROOF PATIO	85' - 2"

<u>BUI</u>	<u>LDINC</u>	3 ST/	<u> ATIS</u>	<u>TICS</u>	

744 BRICKYARD RD ADDRESS: ETOWAH, NC 28729 GOVERNMENTAL FIRE DEPT. **BUILDING USE:** TYPE II-B, SPRINKLERED **BUILDING TYPE:** OCCUPANCY USE: BUSINESS S-2 STORAGE 5422 SF R-2 RESIDENTIAL 2966 SF R2 RESIDENTIAL R2 RESIDENTIAL

ADJACENT ZONING: **BUILDING SQUARE FOOTAGE** TOTAL PROPOSED SF: SITE ACEAGE

> TOTAL STORIES # 9549-37-1688 PROPERTY DESCRIPTION ETOWAH HORSE SHOE FIRE DEPARTMENT LO1.95AC PL2009-7736

ETOWAH-HORSE SHOE PROPERTY OWNER **VOLUNTEER FIRE DEPARTMENT**

13,204 SF

1.6

TOTAL UNIT S.F. TAKEN FROM CENTER LINE OF ADJACENT, EXTERIOR FACE OF OUTER. OCC. S.F. IS USEABLE FINISH FACE TO FINISH FACE DIMENSIONS.

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MICHAEL HUGGINS, FIRE CHIEF ETOWAH HORSESHOE FIRE & RESCUE

PROJECT NAME: **ETOWAH FIREHOUSE** #4 23-021

744 Brickyard Rd, Etowah, NC 28729

TAMARA PEACOCK, R.A LICENSE NO.:12126

ISSUED FOR: SCHEMATIC DESIGN

DATE: 5/23/2023

> SHEET NAME: LIFE SAFETY PLAN

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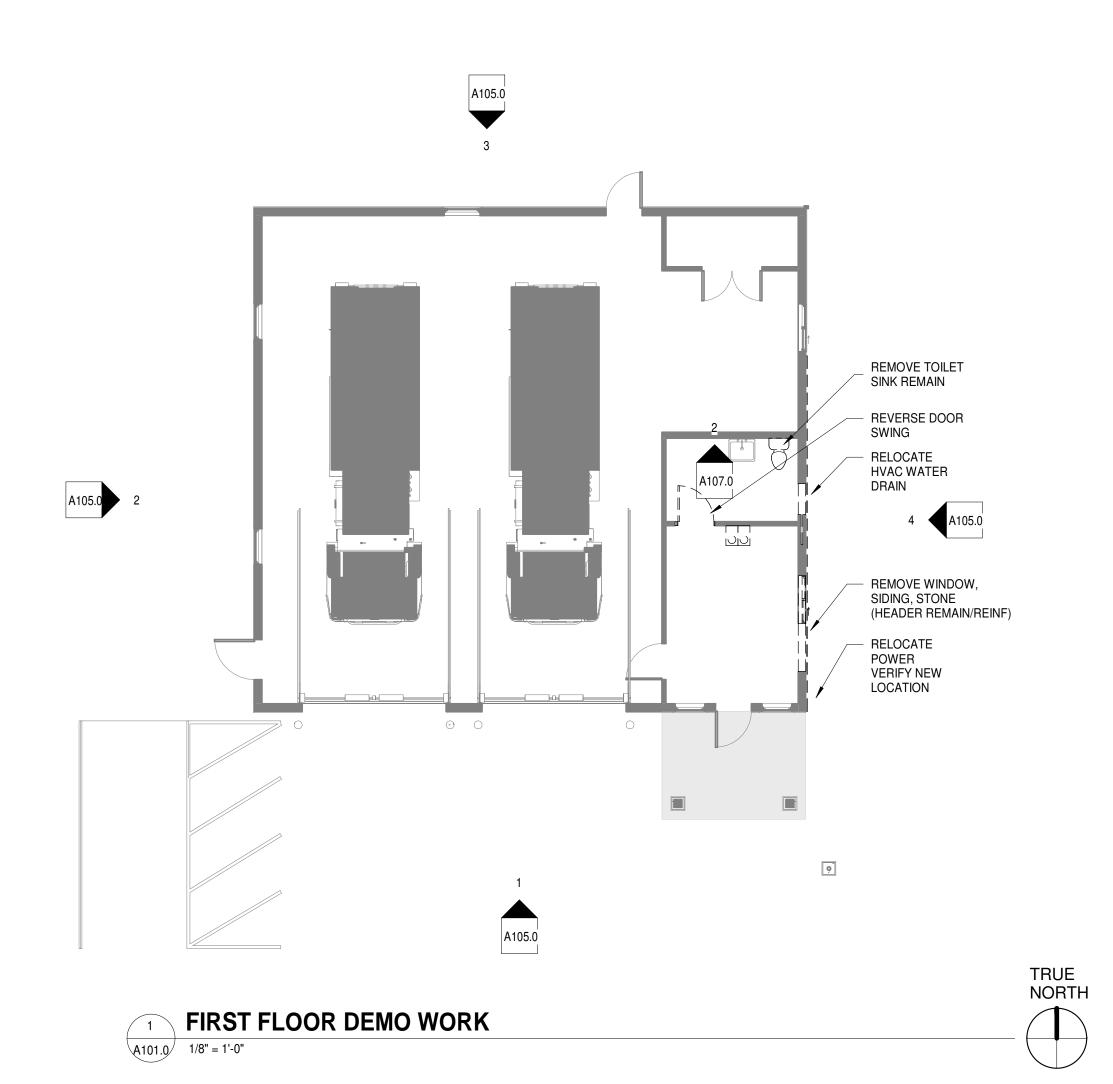
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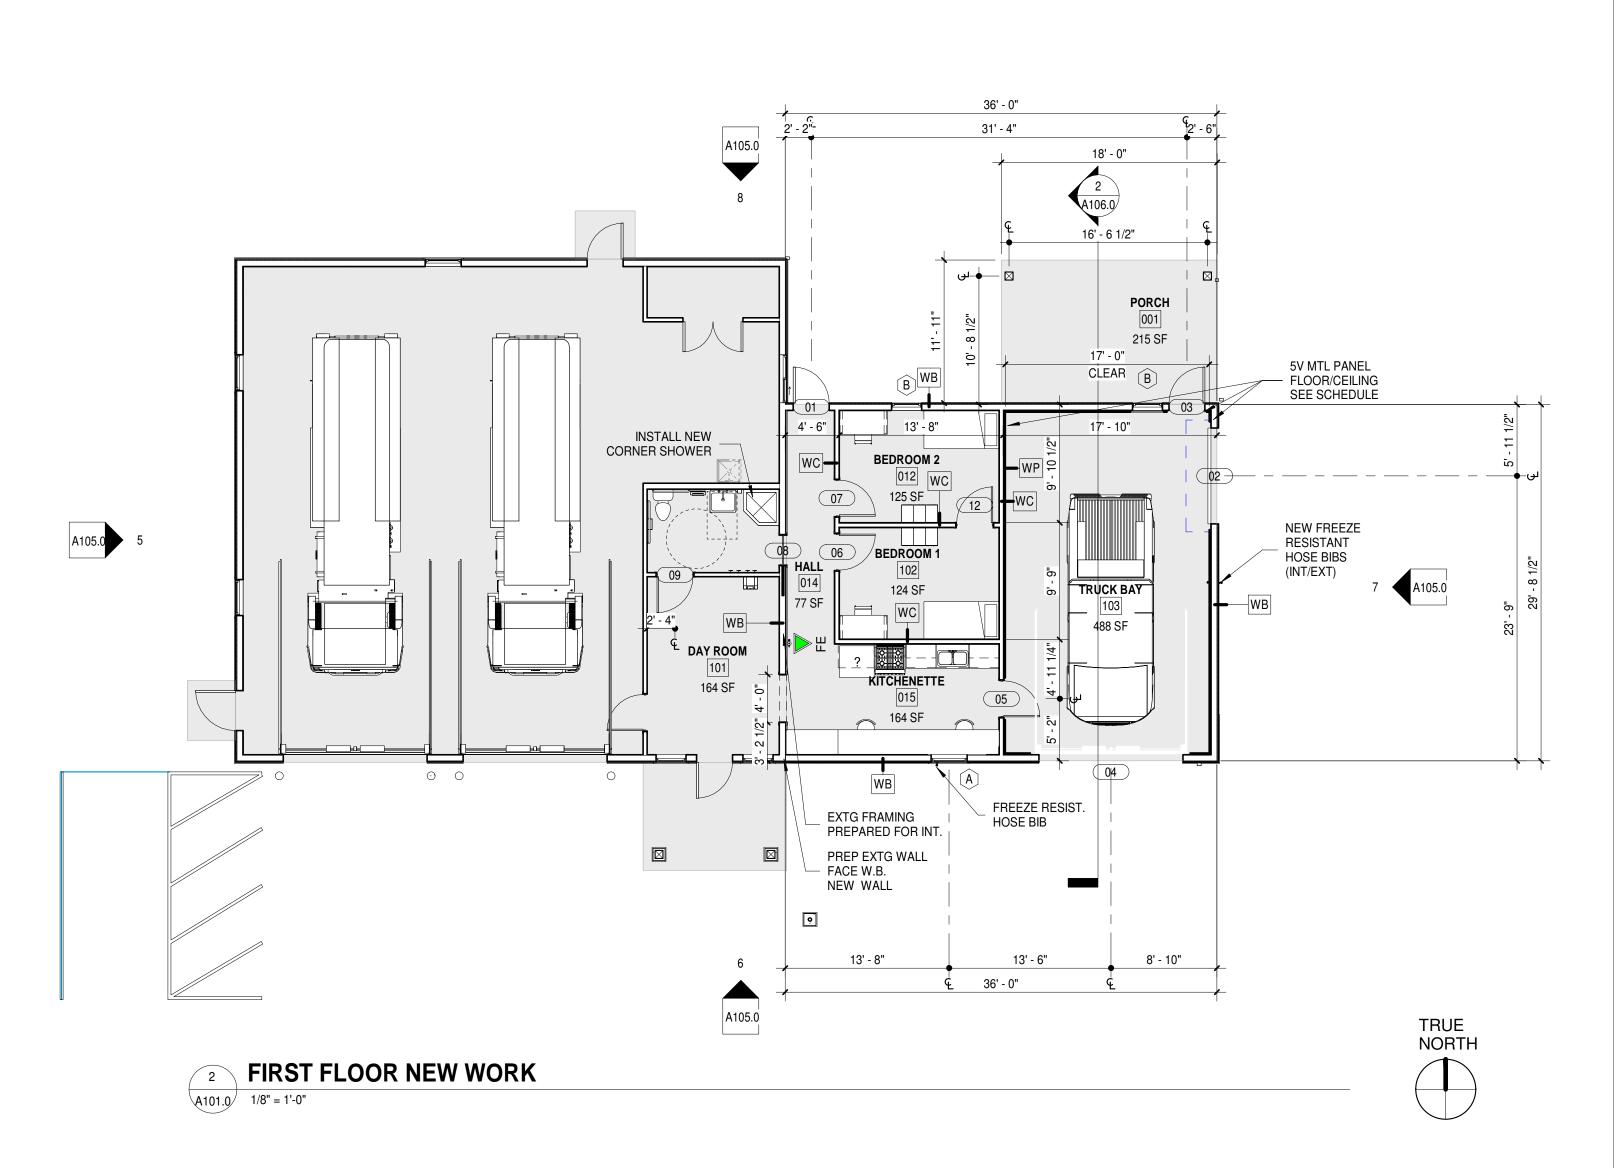
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OWNER:
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ETOWAH HORSESHOE FIRE & RESCUE

I5 MORGAN ROAD
HORSESHOE, NC 28729

PROJECT NAME:

FIREHOUSE #4 23-021 744 Brickyard Rd, Etowah, NC 28729

TAMARA PEACOCK, R.A
LICENSE NO.:12126

ISSUED FOR:
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DATE:

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FIRST
FLOOR
PLAN
DEMO +
NEW WORK

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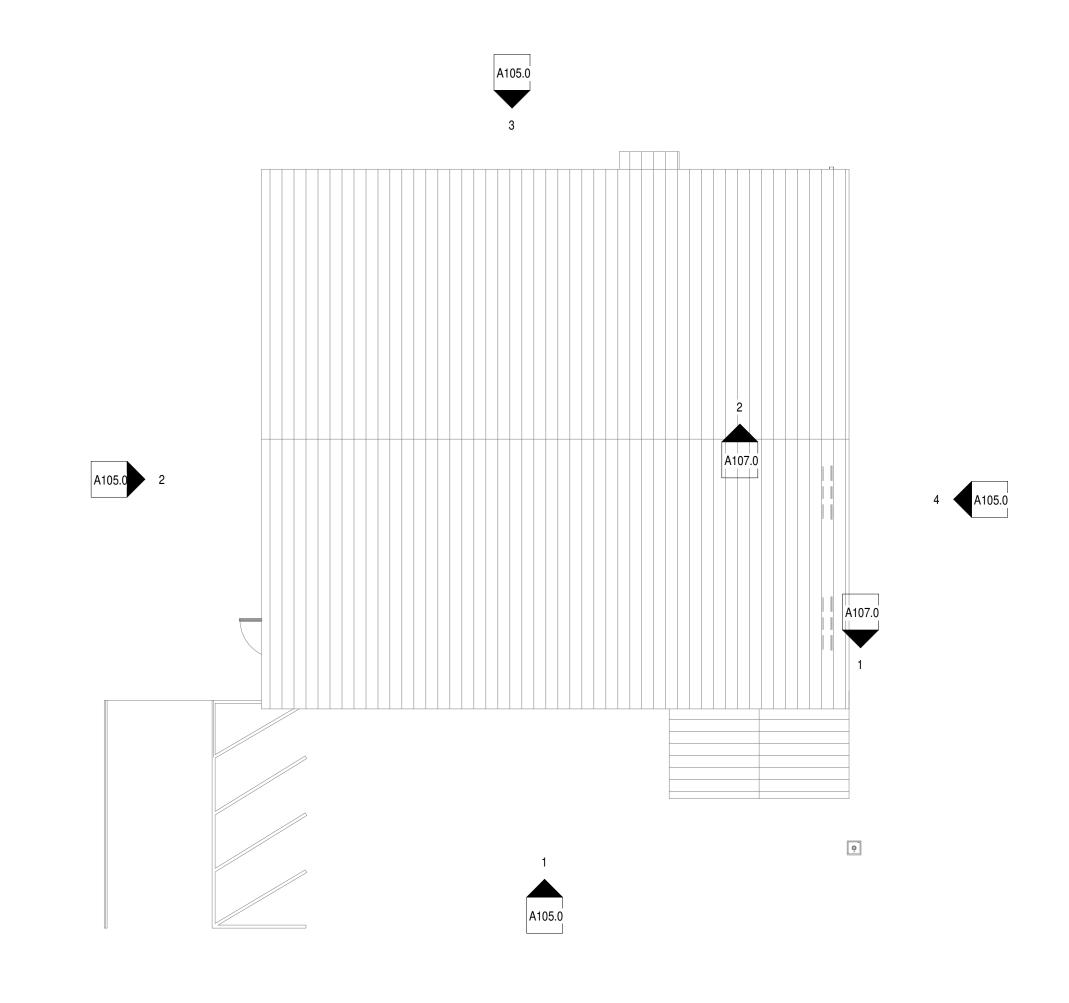
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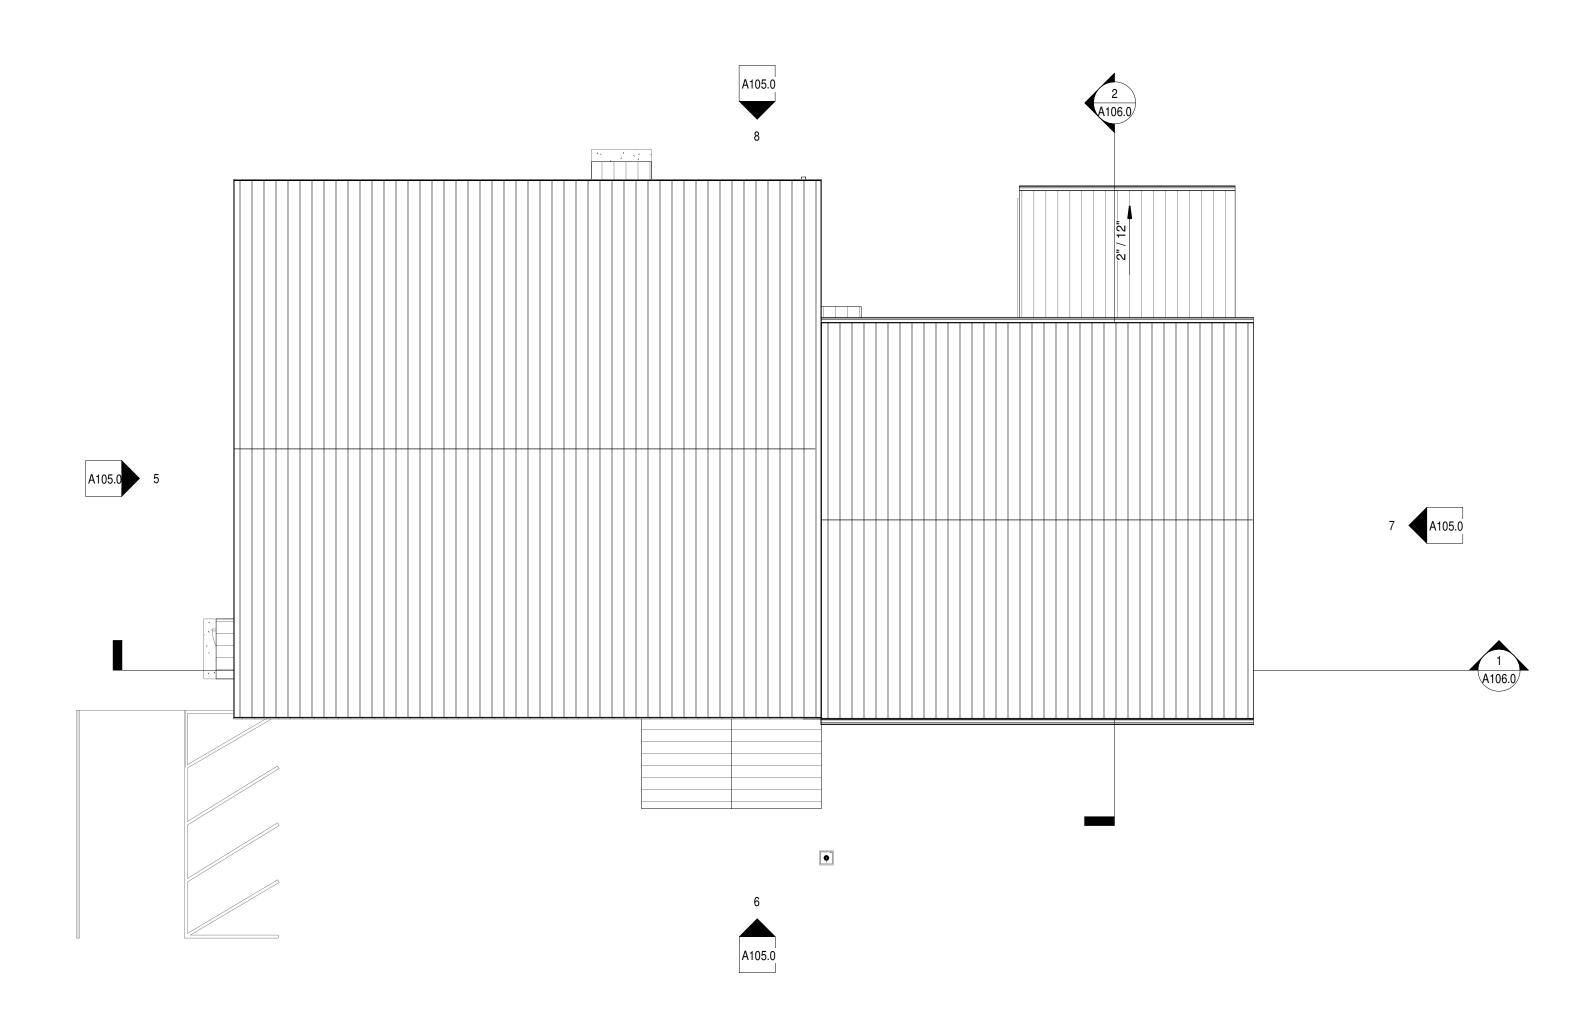
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_ FD	TP	
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SHEET NO.:

A101.0







	TRUE NORTH
ROOF PLAN NEW WORK	
A103.1 1/8" = 1'-0"	

CALCULATION OF ROOF DRAINAGE

	DRAINAGE LOAD SIZE	HORIZONTALLY PROJECTED ROOF AREA SERVED	# OF ROOF DRAINS REQUIRED	# OF ROOF DRAINS PROVIDED	ROOF DRAIN SIZE	LEADER SIZE	GUTTER SIZE
ROOF 1	3,446 SF	2,200 SF	2	4	3" ROOF DRAIN	N/A	N/A
ROOF PATIO	1,334 SF	2,200 SF	1	2	3" ROOF DRAIN	N/A	N/A
ROOF 2	1,608 SF	LEADERS GUTTER 1380 SF 960 SF	N/A	N/A	N/A	NEEDED: (2) 2X3 PROVIDED: (2) 2X3	6" 0.5% SLOPE
ROOF 3	422 SF	850 SF 360 SF	N/A	N/A	N/A	NEEDED: (1) 1 3/4"X 2 1/2" PROVIDED: (1) 1 3/4"X 2 1/2"	4" 0.5% SLOPE

- 100 YEAR RAINFALL INCHES PER HOUR: 4.0" IN PER HOUR FOR PRIMARY DRAIN AND 7.2" PER HOUR FOR SECONDARY DRAINS VERTICAL STORM DRAIN I.E.: 98.40 DEG
- 3" ROOF DRAIN AT 4" PER HOUR SERVES ROOF AREA OF 2,200 SF
- CALCULATIONS VERIFIED WITH NCBC CHAPTER 11 AND PROPOSED CONDITIONS MEET THE MINIMUM REQUIREMENTS FOR DRAINAGE.
- -IN SIZING ROOF DRAINS, ONE-HALF OF THE AREA OF THE PARAPETS EXTENDING ABOVE THE ROOF WAS ADDED TO THE ROOF AREA.
 PRIMARY GUTTERS FOR ROOF 2 SIZED PER NCBC TABLE 1106.6, AND LEADERS SIZED PER NCBC TABLE 1106.2(2)

PEACOCK COMPANY


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ISSUED FOR: SCHEMATIC DESIGN

ROOF PLAN DEMO + **NEW WORK**

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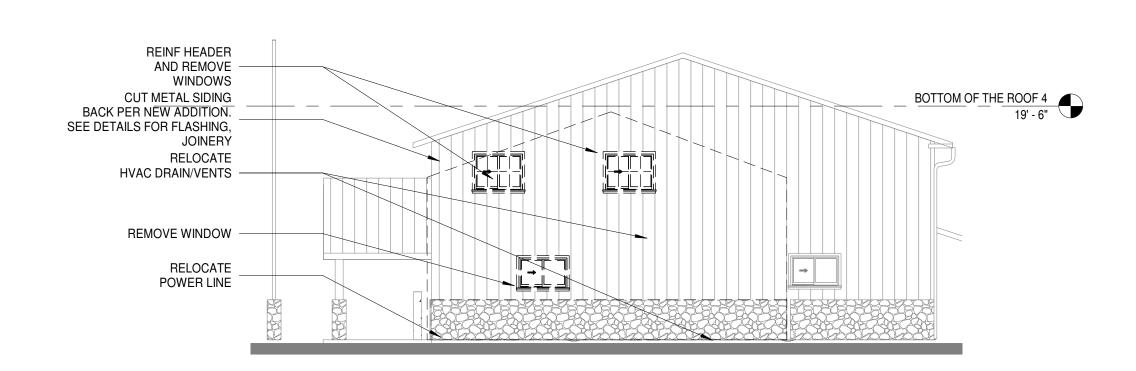
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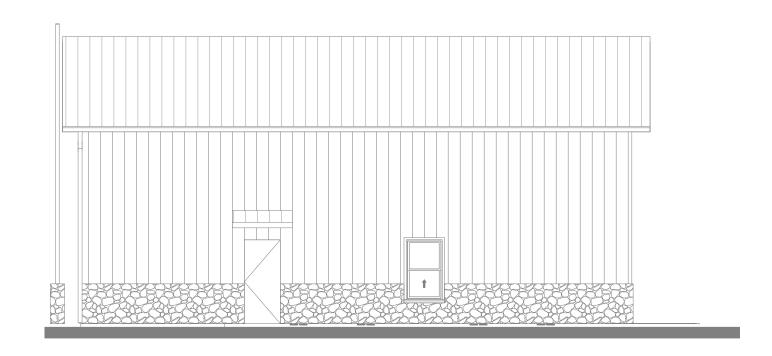
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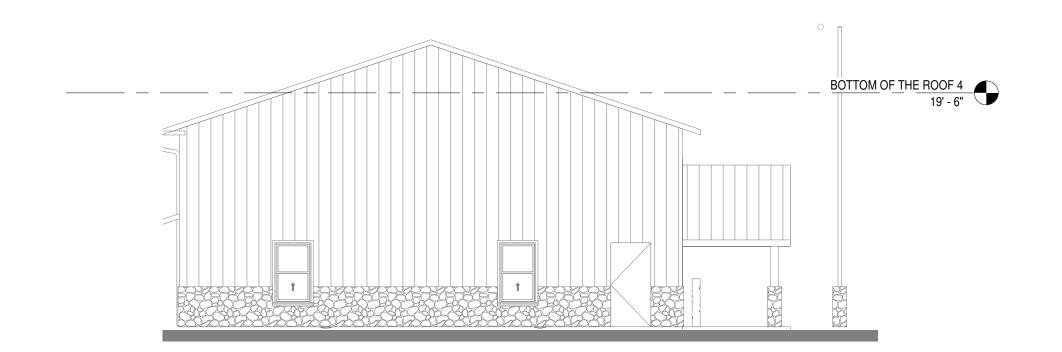
1 NORTH DEMO ELEVATION A105.0 1/8" = 1'-0"




4 **WEST DEMO ELEVATION**A105.0 1/8" = 1'-0"

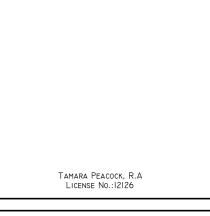


3 SOUTH DEMO ELEVATION A105.0 1/8" = 1'-0"




2 EAST DEMO ELEVATION A105.0 1/8" = 1'-0"

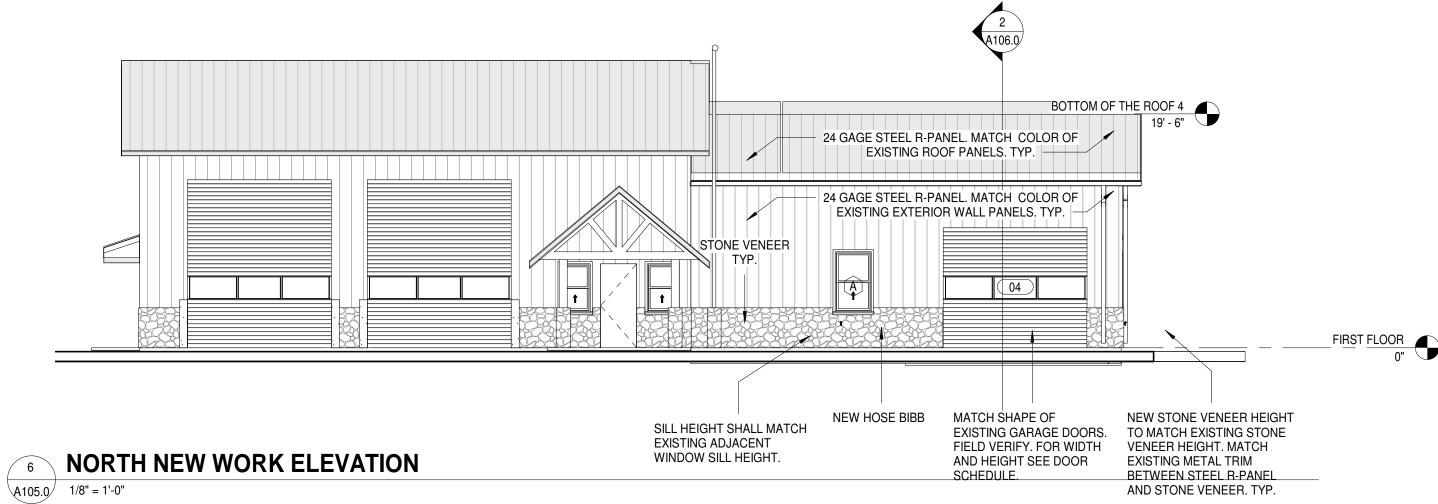

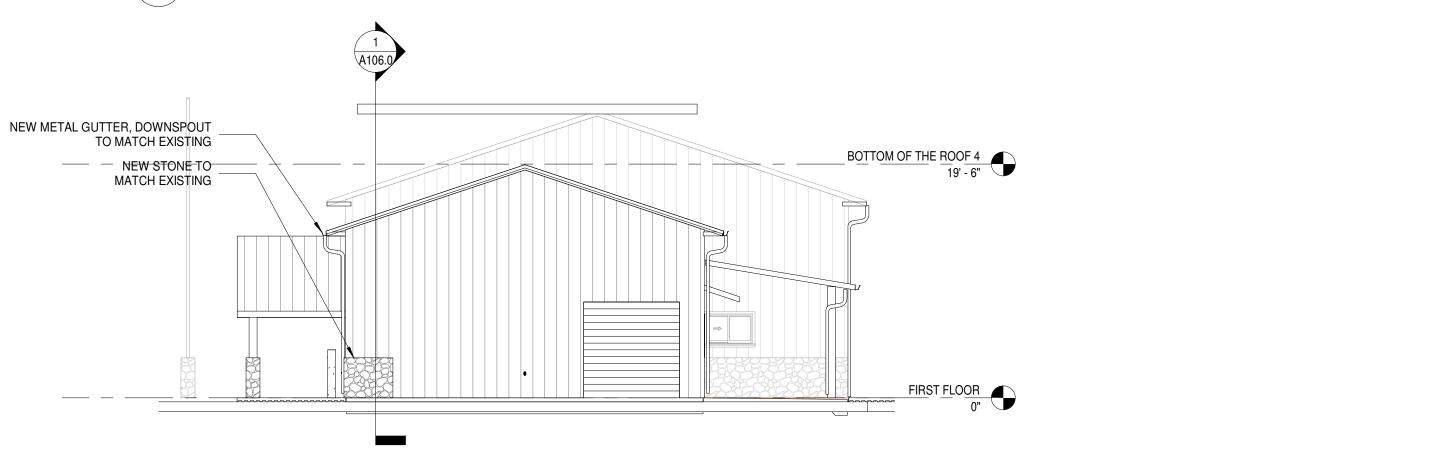

7 WEST NEW WORK ELEVATION A105.0 1/8" = 1'-0"

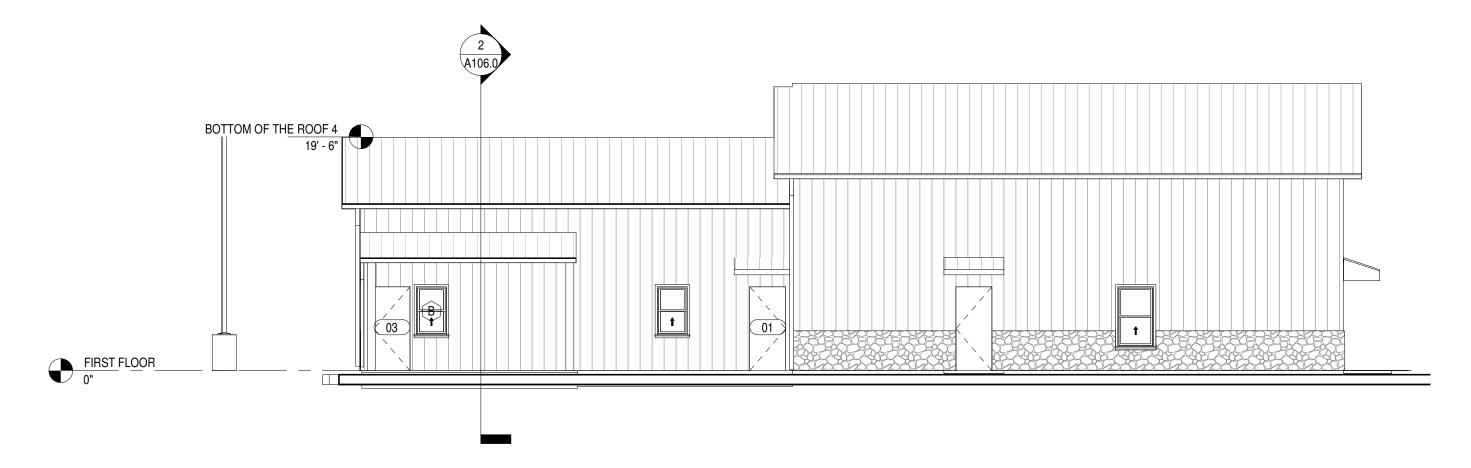

8 SOUTH NEW WORK ELEVATION

A105.0 1/8" = 1'-0"

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FROJECT NAME:

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TAMARA PEACOCK, R.A
LICENSE NO.:12126

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ISSUED FOR:
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EXTERIOR
ELEVATIONS
DEMO +
NEW WORK


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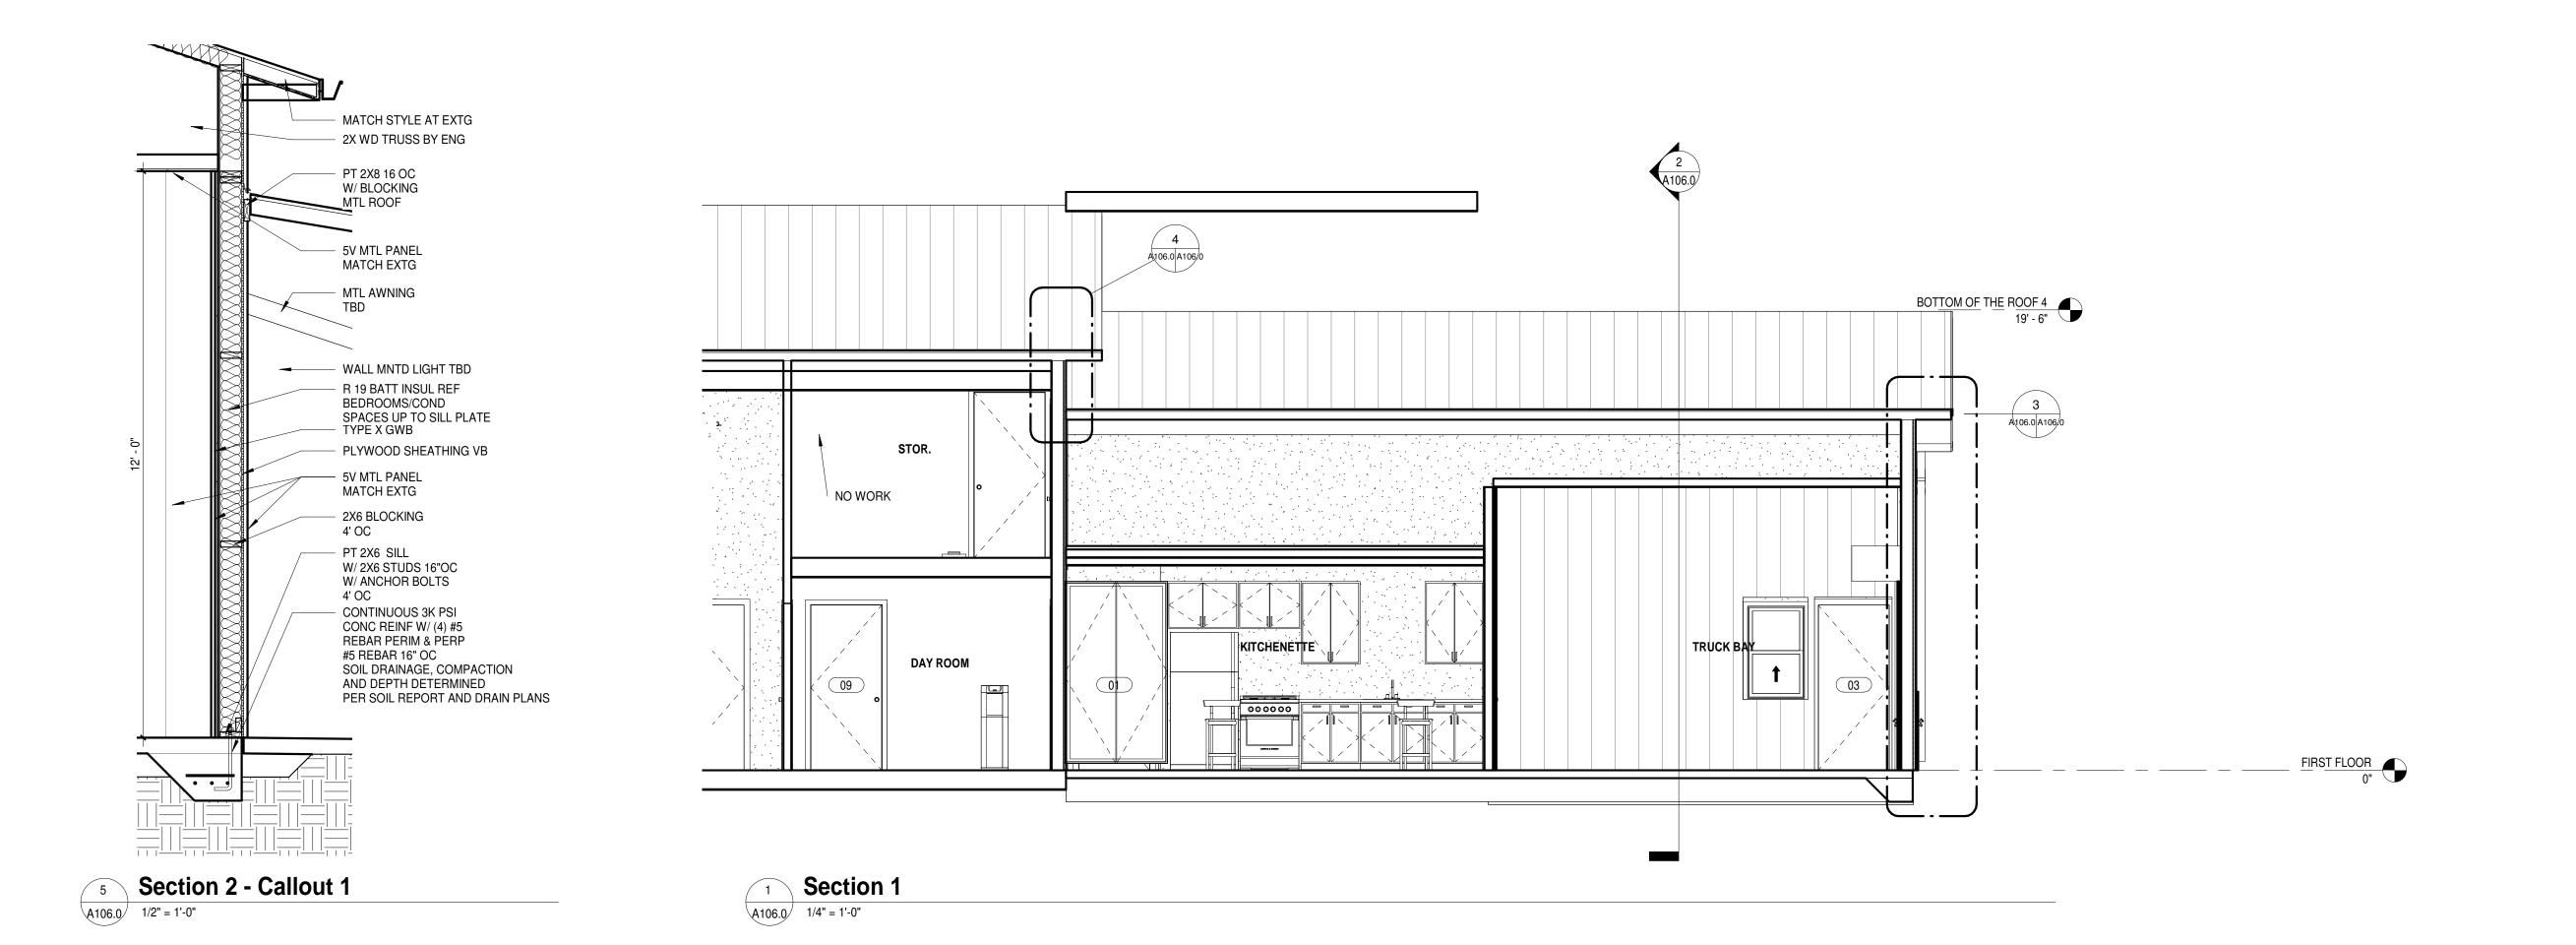
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ETOWAH HORSESHOE FIRE & RESCUE

PROJECT NAME:

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ISSUED FOR:
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DATE: 5/23/2023

SHEET NAME:
BUILDING
SECTIONS
NEW WORK

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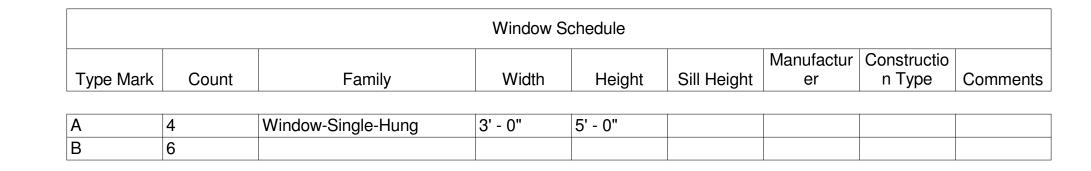
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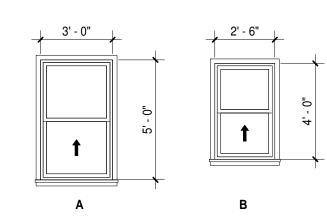
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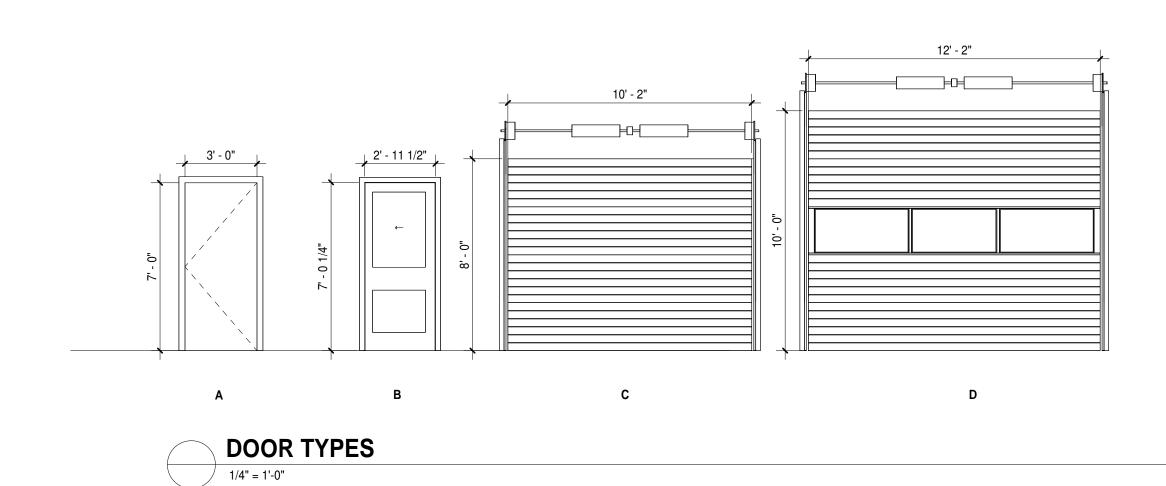
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DOOR SCHEDULE			
	DOOR SIZE		
DOOR NO.	WIDTH	HEIGHT	REMARKS
01	3' - 0"	7' - 0"	A
02	8' - 0"	8' - 0"	С
03	3' - 0"	7' - 0"	A
04	12' - 0"	10' - 0"	D
05	3' - 0"	7' - 0"	A
06	3' - 0"	7' - 0"	A
07	3' - 0"	7' - 0"	A
08	2' - 6"	7' - 0"	B POCKET
09	3' - 0"	7' - 0"	A
12	3' - 0"	7' - 0"	
13	3' - 0"	7' - 0"	

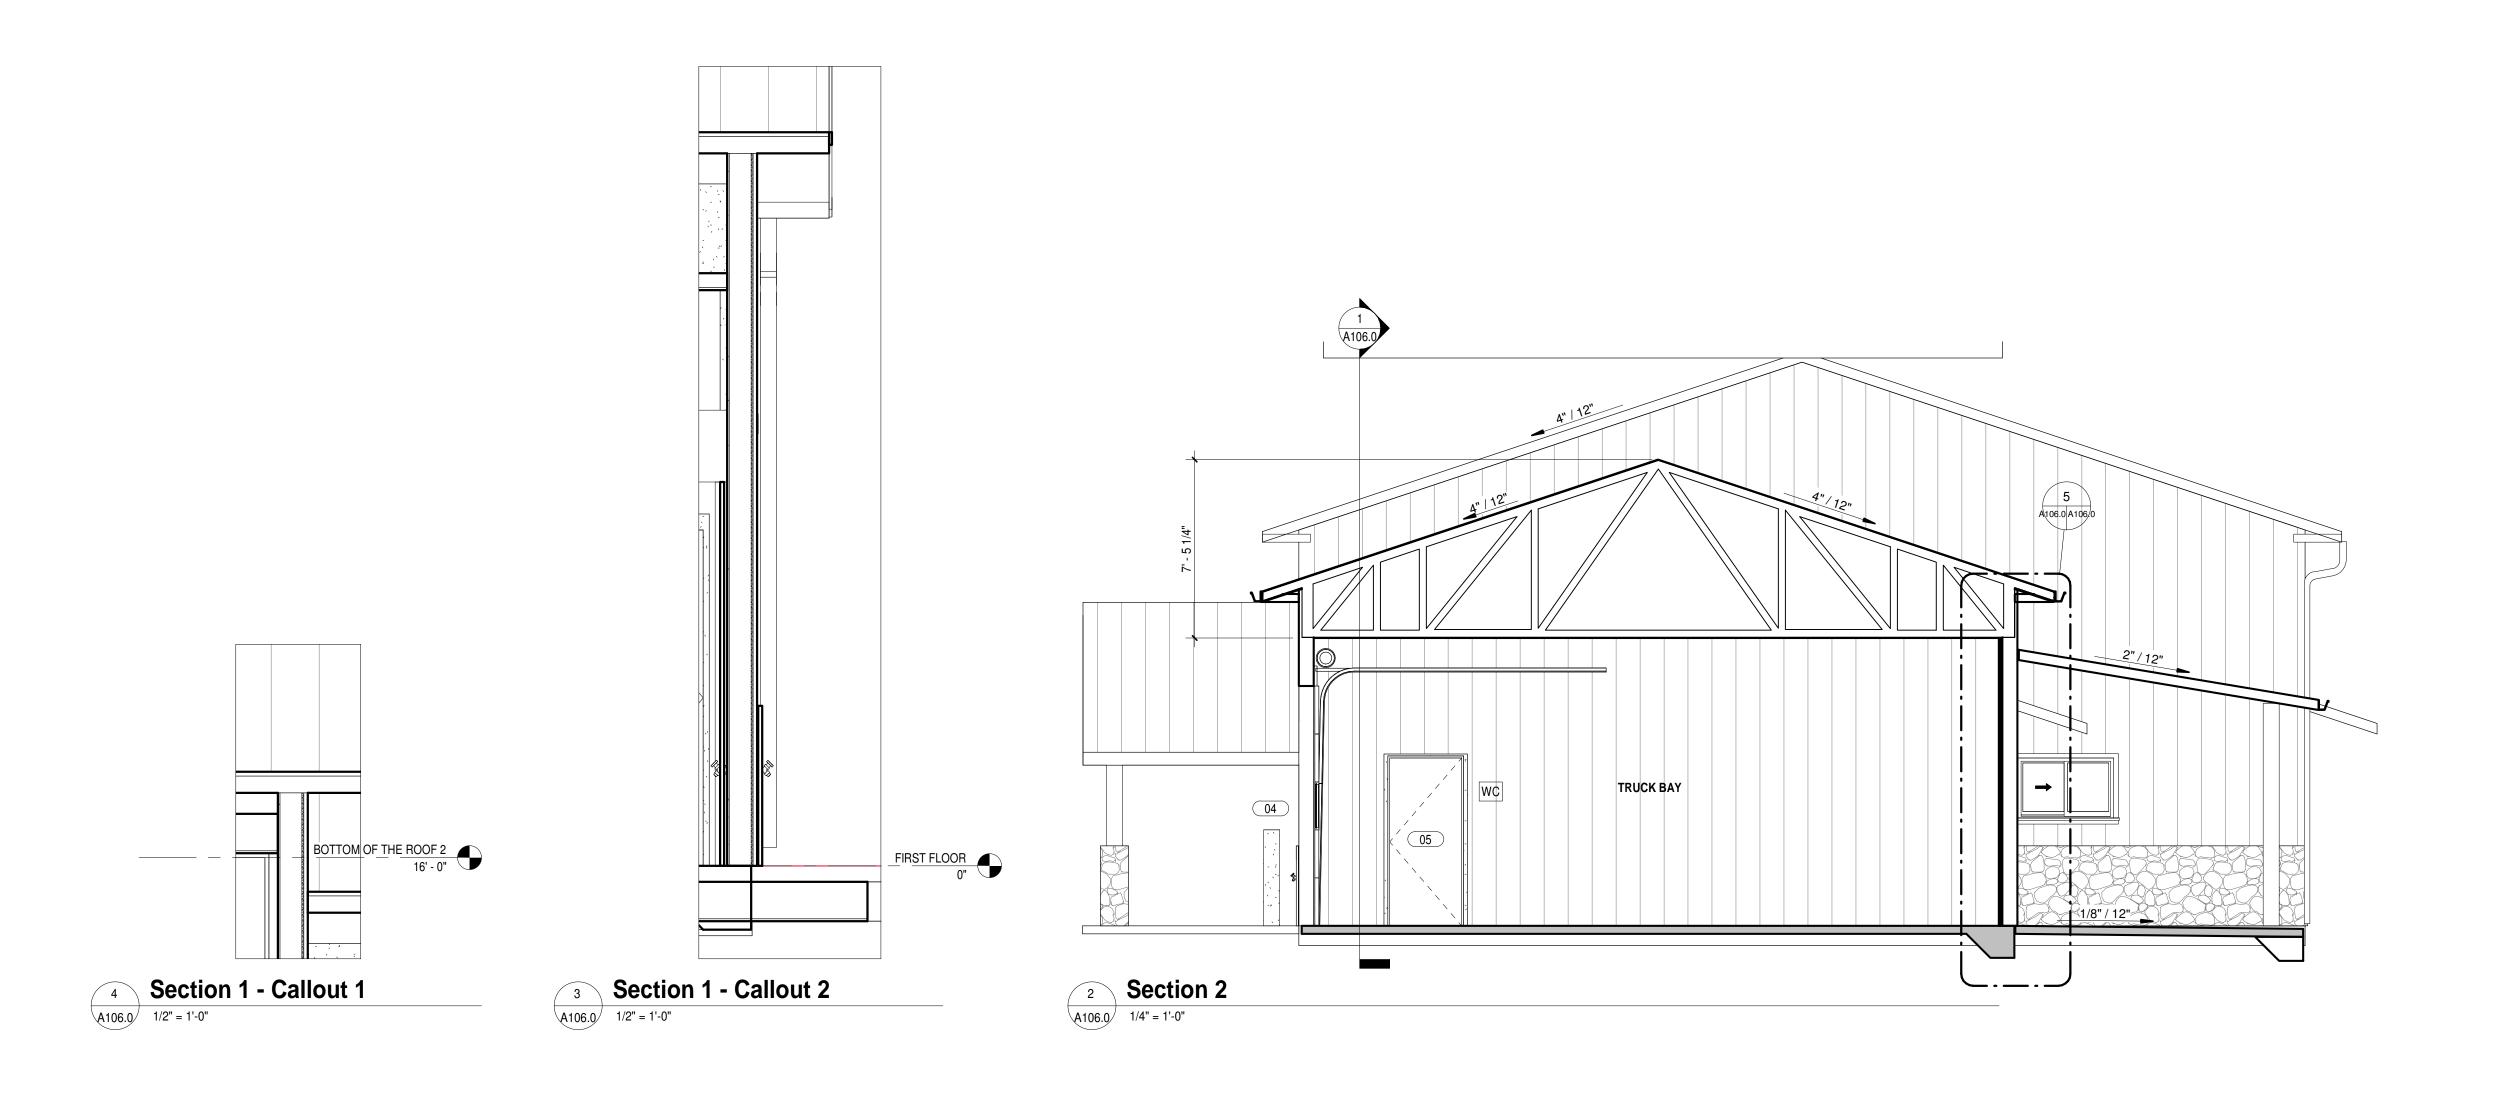

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ETOWAH HORSESHOE FIRE & RESCUE

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PROJECT NAME:

ETOWAH
FIREHOUSE
#4 23-021

744 Brickyard Rd, Etowah, NC 28729

TAMARA PEACOCK, R.A
LICENSE NO.:12126

ISSUED FOR:
SCHEMATIC DESIGN

DATE:

5/23/2023

DOOR & WINDOW SCHEDULES

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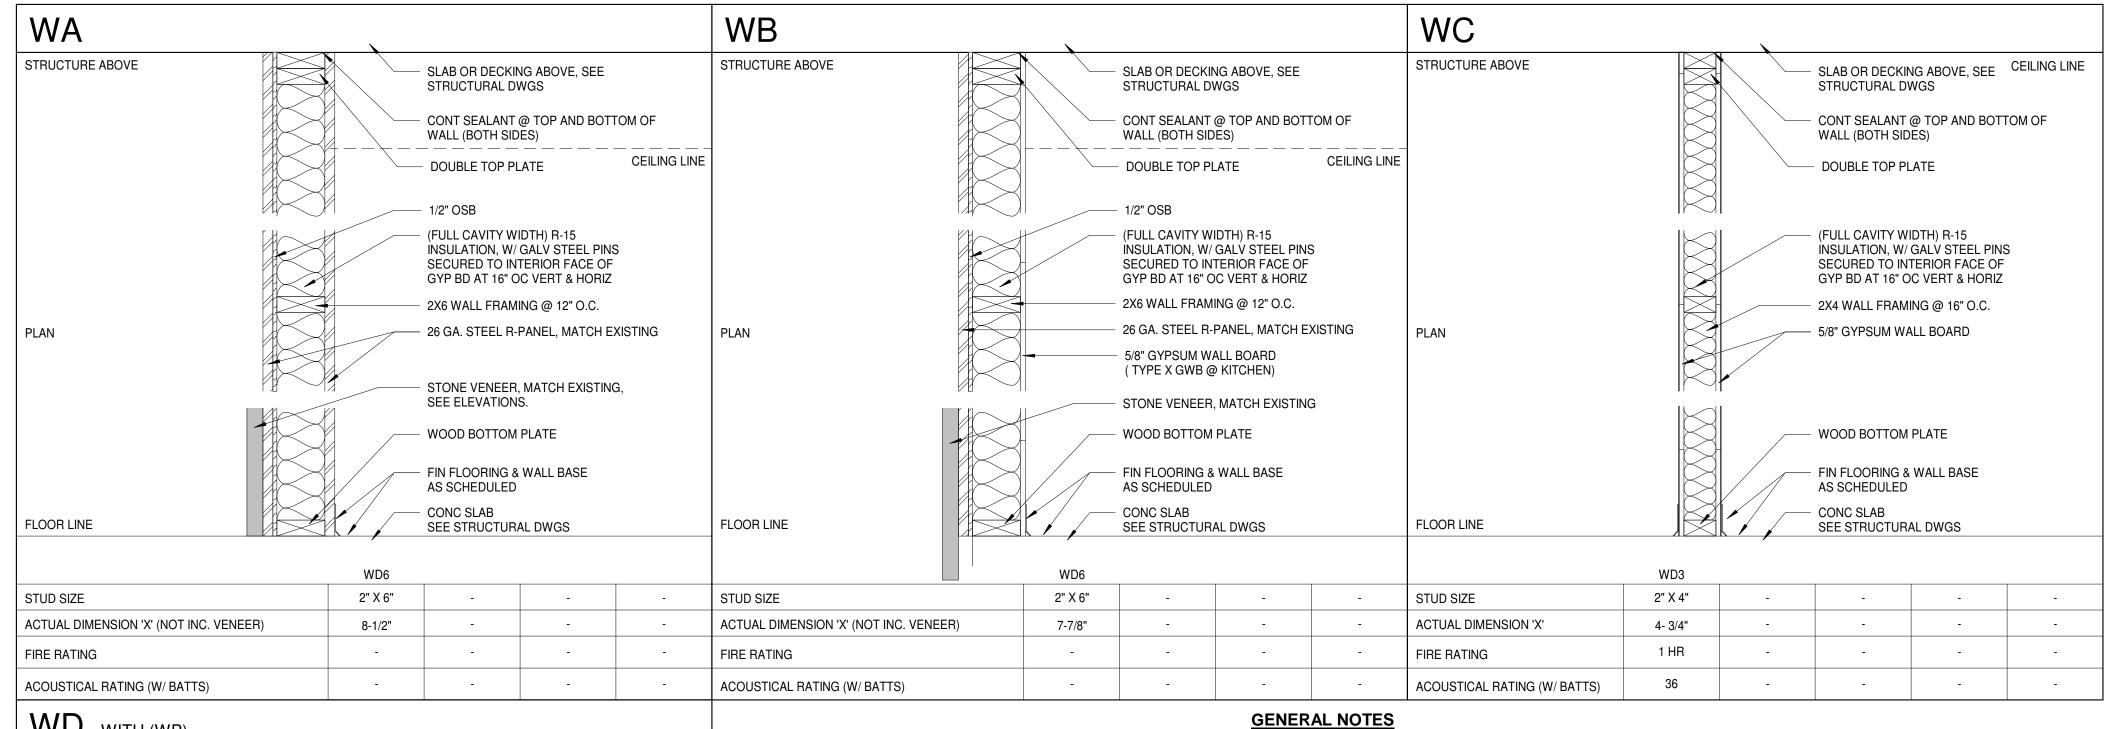
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WD with (WP) STRUCTURE ABOVE SLAB OR DECKING ABOVE, SEE STRUCTURAL DWGS CONT SEALANT @ TOP AND BOTTOM OF WALL (BOTH SIDES) CEILING LINE DOUBLE TOP PLATE (FULL CAVITY WIDTH) R-15 INSULATION, W/ GALV STEEL PINS SECURED TO INTERIOR FACE OF GYP BD AT 16" OC VERT & HORIZ 2X4 WALL FRAMING @ 16" O.C. - 5/8" GYPSUM WALL BOARD PLAN WOOD BOTTOM PLATE - FIN FLOORING & WALL BASE AS SCHEDULED CONC SLAB FLOOR LINE SEE STRUCTURAL DWGS WD3 2" X 4" STUD SIZE -**ACTUAL DIMENSION 'X'** 5-3/8" -_ -1 HR FIRE RATING -ACOUSTICAL RATING (W/ BATTS)

1. THE CONTRACTOR SHALL MAINTAIN ALL EXISTING EMERGENCY LIGHTING, EXITING, SECURITY. AND ALARMS FOR THE ENTIRE SITE. ANY VARIATIONS OF EXISTING SYSTEMS SHALL BE COORDINATED WITH THE OWNER. THE CONTRACTOR SHALL TAKE ALL NECESSARY PRECAUTIONS PRESCRIBED BY ALL LAWS, ORDINANCES, CODES, REGULATIONS AND ALL AUTHORITIES HAVING JURISDICTION TO PREVENT INJURY TO ANY PERSONS ON, ABOUT, OR ADJACENT TO THE CONSTRUCTION SITE.

2. THE GENERAL CONTRACTOR SHALL BE RESPONSIBLE FOR THE REGULAR REMOVAL OF ALL WASTE MATERIAL FROM THE PROJECT SITE. ALL ITEMS AND MATERIALS REMOVED FROM THE SITE SHALL BE DISPOSED OF AS SPCIFIED. ON SITE BURNING IS PROHIBITED. ALL AREAS ADJACENT TO THE DEMOLITION ARE SHALL BE KEPT CLEAN. ALL DEMOLITION AREAS SHALL BE CLEANED AND READY FOR NEW CONSTRUCTION AT THE END OF THE DEMOLITION.

- 3. IF THE CONTRACTOR IDENTIFIES ANY CONFLICTS OR OMISSIONS ON THE DRAWINGS, THE ARCHITECT SHALL BE NOTIFIED IMMEDIATELY.
- 4. ALL EXPOSED INTERIOR AND EXTERIOR MISC. METALS, JOISTS, DECKS, COLUMNS, BEAMS, LINTELS, ANGLES, BRACKETS, ETC. SHALL BE PAINTED. COLOR SELECTION TO BE DETERMINED
- 5. CONRACTOR SHALL NOT SCALE THE DRAWINGS. IF DIMENSIONS ARE UNCLEAR NOTIFY THE ARCHITECT IMMEDIATELY FOR CLARIFICATION.

6. THE GENERAL CONTRACTOR SHALL VERIFY THAT ALL REQUIRED CLEARANCES FOR INSTALLATION AND MAINTENANCE OF ALL MECHANICAL, ELECTRICAL, PLUMBING AND SPRINKLER EQUIPMENT INCLUDING ALL PIPING, DUCTWORK AND CONDUIT ARE PROVIDED. SHOULD ANY CONFLICT EXIST, THE GENERAL CONTRACTOR SHALL ADVISE THE ARCHITECT BEFORE PROCEEDING WITH CONSTRUCTION.

7. THE GENERAL CONTRACTOR SHALL BE RESPONSIBLE FOR COMPLETING ALL WORK IN ACCORDANCE WITH ALL APPLICABLE CODES IN EFFECT AT THE TIME OF CONSTRUCTION.

8. THE BUILDING IS DESIGNED TO BE STRUCTURALLY SELF-SUPPORTING & STABLE AFTER THE BUILDING IS FULLY COMPLETED. IT IS THE CONTRACTOR'S SOLE RESPONSIBILITY TO DETERMINE ALL ERECTION MEANS, METHODS, PROCEDURES & SEQUENCING TO DETERMINE THE ADEQUACY & STRENGTH OF ANY PARTS OF THE STRUCTURE BEING USED AS TEMPORARY SUPPORTS; TO DETERMINE THE STRUCTURE OF ELEMENTS BEING USED AS TEMPORARY SUPPORTS THROUGHOUT THE CONSTRUCTION PERIOD & TO ENSURE THE SAFETY OF THE BUILDING AND ITS COMPONENT PARTS DURING CONSTRUCTION. THE SUB-CONTRACTORS SHALL CAREFULLY COORDINATE THEIR ACTIVITIES THROUGH THE GENERAL CONTRACTOR TO ACHIEVE THESE REQUIREMENTS.


9. THE CONTRACTOR SHALL BE RESPONSIBLE FOR PROVIDING TEMPORARY BRACING, GUYS. SHORING OR TIE-DOWNS AS REQUIRED TO EXECUTE CONSTRUCTION SEQUENCE. SUCH TEMPORARY MATERIALS SHALL BE REMOVED BY THE CONTRACTOR AFTER COMPLETION OF THE PROJECT.

- 10. THE GENERAL CONTRACTOR AND THEIR SUBCONTRACTORS SHALL REVIEW THE LAYOUT AND EXACT LOCATION OF ALL PARTITIONS, DOORS, ELECTRICAL/TELEPHONE OUTLETS, LIGHT SWITCHES AND THERMOSTATS AND ADVISE THE ARCHITECT OF ANY CONFLICT BEFORE PROCEEDING WITH CONSTRUCTION.
- 11. "TYPICAL" MEANS IDENTICAL FOR ALL SIMILAR CONDITIONS UNLESS OTHERWISE NOTED.
- 12. "SIMILAR" MEANS COMPARABLE CHARACTERISTICS FOR THE CONDITION.
- 13. PROVIDE UTILITY SHELF W/ MOP HOLDER IN EACH JANITOR CLOSET.
- 14. PROVIDE INTERIOR SIGNS W/ BRAILLE FOR ALL SPACES REQUIRED BY CODE. ALL SIGNS SHALL MEET AND BE INSTALLED PER IBC 2012 AND ANSI 117 2009 REQUIREMENTS.

15. PORTABLE FIRE EXTINGUISHERS HAVING A GROSS WEIGHT NOT EXCEEDING 40 POUNDS SHALL BE INSTALLED SO THAT THE TOP IS NOT MORE THAN 5'-0" FROM FINISHED FLOOR. THE MINIMUM HEIGHT BETWEEN THE FINISH FLOOR AND THE BOTTOM OF THE EXTINGUISHERS SHALL NOT BE LESS THAN 4 INCHES.

16. CONTRACTOR SHALL PROVIDE SHOP DRAWINGS FOR ARTCHITECT'S REVIEW FOR ALL PRE-MANUFACTURED COMPONENTS PRIOR TO PURCHASE.

17. CONTRACTOR SHALL PROVIDE CUT SHEETS FOR ARCHITECT'S REVIEW FOR ALL MATERIALS, FIXTURES & EQUIPMENT PRIOR TO PURCHASE.

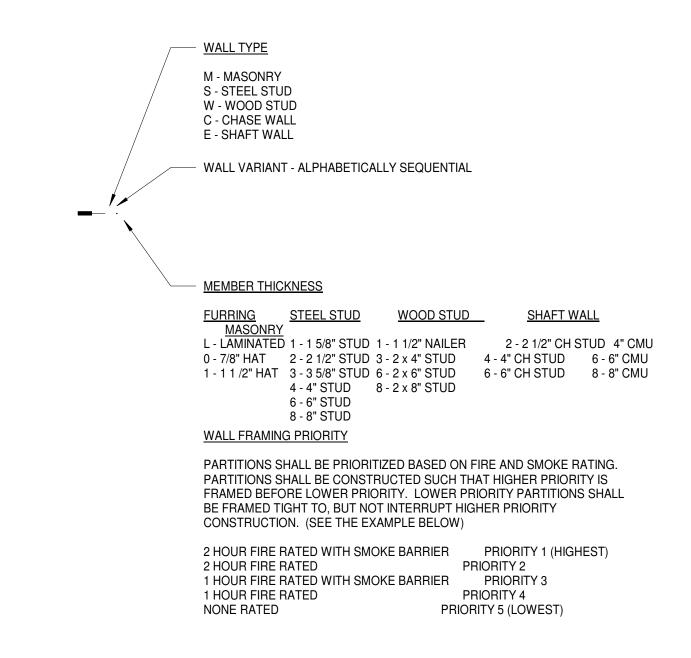

GENERAL PARTITION NOTES:

- 1. PLAN DIMENSIONS ARE FACE OF STUD, CMU OR FINISH FACE OF EXISTING WALL CONSTRUCTION UNLESS SPECIFICALLY NOTED
- 2. GYPSUM WALL BOARD LAYERS ON RATED WALLS SHALL BE CONTINUOUS THROUGH ALL INTERSECTIONS WITH NON-RATED WALLS. REFER TO FIRE WALL PRIORITY DIAGRAM.
- 3. REFERENCE ALL FLOOR PLANS AND LIFE SAFETY PLANS FOR RATED WALL LOCATIONS & RATINGS. 4. PROVIDE TYPE X, MOLD AND MOISTURE RESISTANT GYPSUM BOARD IN ALL TOILET AND JANITOR ROOMS. **Architect's note: verify with specs
- & edit as required for specific project** 5. PROVIDE CEMENT BOARD IN ALL WET SHOWER AREA WALLS WITH TILE FINISH. **Architect's note: verify with specs & edit as required for specific
- 6. PROVIDE IMPACT RESISTANT GYPSUM BOARD UP TO 4'-0" IN ALL LOBBIES, CORRIDORS, & STAIRWELLS. **Architect's note: verify with specs & edit as required for specific project** 7. AT ALL UL RATED WALLS THAT EXTEND TO THE STRUCTURE ABOVE. FILL VOIDS SOLID WITH MINERAL WOOL INSULATION WHERE WALL IS
- FRAMED AROUND BEAMS, BAR JOISTS, SLABS, AND ROOF DECK. MAINTAIN SCHEDULED SOUND RATING. AT ALL SOUND RATED WALLS PROVIDE FLEXIBLE SEALANT OR AN ACOUSTICAL GASKET BETWEEN THE STC RATED SYSTEM AND ALL DISSIMILAR SURFACES (IE PENETRATIONS) AND ALSO BETWEEN THE SYSTEM AND SIMILAR SURFACES WHERE PERIMETER RELIEF IS REQUIRED. ALL OPENINGS THROUGH THE SYSTEM, AND ITS ENTIRE PERIMETER, SHALL BE SEALED AIRTIGHT. TAPING GYPSUM BOARD WALL AND WALL-CEILING INTERSECTIONS PROVIDES AN ADEQUATE AIR SEAL AT THESE LOCATIONS.
- 3. AT ALL JOINTS AT TOP OF ALL FIRE RATED PARTITIONS: PROVIDE COMPLETE UL LISTED FIRE RESISTIVE JOINT SYSTEM TO MATCH FIRE RESISTANCE OF WALL ASSEMBLY AND THAT IS ALSO COMPATIBLE WITH JOINT SUBSTRATES. SUBMIT COMPLETE JOINT SYSTEM PRODUCT
- INFORMATION FOR ALL CONDITIONS. 9. PROVIDE CONTINUOUS ICE & WATER SHIELD BETWEEN METAL STUD TRACK & CONCRETE OR DECK AT TOP (AND BOTTOM) OF WALL WHERE UNCONDITIONED SPACES EXIST ABOVE (OR BELOW).
- 10. PROVIDE DEFLECTION TRACK AT TOP OF WALL AT ALL CONNECTIONS TO THE STRUCTURE ABOVE. **Architect's note: verify with specs & edit as required for specific project*
- 11. ANY PORTION OF GYPSUM BOARD THAT BECOMES WET OR SHOWS SIGNS OF MOISTURE DAMAGE, EITHER BEFORE OR AFTER INSTALLATION, IS TO BE REMOVED IMMEDIATELY AND REPLACED WITH NEW DRY GYPSUM BOARD. 12. MANY INTERIOR PARTITIONS HAVE ADDITIONAL FINISHES, SUCH AS WALL TILES OR WOOD PANELING. SEE FINISH SCHEDULE AND DETAIL
- SHEETS FOR ADDITIONAL INFORMATION. 13. ALL CONCRETE BLOCK (IN FIRE RATED WALLS) MUST BEAR THE UL CLASSIFICATION MARK OR SUBMIT EQUIVALENT TESTING DATA. 14. GENERAL CONTRACTOR SHALL VERIFY SPACING AND GAUGE OF INTERIOR STUDS, LIMITING HEIGHTS AND ALLOWABLE DEFLECTION FOR SPECIFIC APPLICATIONS BASED ON MANUFACTURERS REQUIREMENTS. AT A MINIMUM STUDS SHALL BE 20 GAUGE OR GREATER.
- 15. GENERAL CONTRACTOR SHALL COORDINATE ROOF DRAIN LINE LOCATIONS WITHIN WALLS. 16. SOUND ATTENUATION BLANKET IS REQUIRED AT ALL INTERIOR PARTITIONS AND SHALL RUN FULL HEIGHT OF PARTITION UNLESS NOTED
- OTHERWISE. SOUND ATTENUATION BATT SHALL BE MADE OF MINERAL WOOL OR OTHER UL APPROVED MATERIAL. 17. IT IS NOT THE INTENT OF THE DOCUMENTS TO IDENTIFY EACH INDIVIDUAL WALL WITH A WALL TAG. MINOR WALLS OR OTHER WALLS NOT TAGGED WILL BE OF THE SAME WALL TYPE AS ADJACENT WALLS.
- 18. GENERAL CONTRACTOR IS TO COORDINATE AND PROVIDE ALL REQUIRED BLOCKING WITHIN THE WALLS. THIS INCLUDES BUT IS NOT LIMITED TO, ALL MILLWORK, CASEWORK, GRAB BARS, LCD MONITORS, AND TOILET PARTITIONS.
- 19. GYPSUM BOARD ON WALLS SHALL BE APPLIED WITH A MINIMUM 1/4" GAP BETWEEN THE GYPSUM BOARD AND THE FLOOR AND SHALL NOT BE APPLIED OVER OTHER BUILDING MATERIALS WHERE CONDITIONS EXIST THAT ARE FAVORABLE TO MOLD GROWTH.

THE TAMARA **PEACOCK** COMPANY

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ISSUED FOR: SCHEMATIC DESIGN

DATE: 5/23/2023

SHEET NAME: **PARTITION TYPES**

REVISIONS:		

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