

REQUEST FOR COMMITTEE ACTION

HENDERSON COUNTY

TECHNICAL REVIEW COMMITTEE

MEETING: August 15, 2023

SUBJECT: Revised Major Site Plan Review Ingles #140

PRESENTER: Matt Champion, Zoning Administrator

ATTACHMENTS: Staff Report

SUMMARY OF REQUEST: Retail Sales & Service SR 7.16, Convenience Store SR 7.4, Fuel Pumps SR 2.5, Car Wash SR 6.5

Suggested Motion: I move that the TRC approve/deny the revised major site plan for Ingles #140



Henderson County, North Carolina Code Enforcement Services

1. Committee Request

- 1.1. **Applicant:** Preston Kendall with Ingles Markets, Inc.
- 1.2. **Request:** Revised Major Site Plan Approval
- 1.3. **PINs:** 9652-31-4347, 9652-31-6641, & 9652-31-6277
- 1.4. **Size:** 11.2 acres +/-
- 1.5. **Location:** The subject area is located off Hendersonville Road (US 25) across from the Butler Bridge/Hendersonville Rd intersection.
- 1.6. **Supplemental Requirements:**

SR 7.16. Retail Sales and Services Greater than 100,000 Square Feet but Less than or Equal to 150,000 Square Feet (of Gross Floor Area)

- (1) Site Plan. *Major Site Plan* required in accordance with §42-331 (Major Site Plan Review).
- (2) Lighting. *Adequate lighting* shall be placed in areas used for vehicular/pedestrian access including, but not limited to: stairs, sidewalks, crosswalks, intersections, or changes in grade. *Lighting mitigation* required.
- (3) Separation. *Structures* shall not be placed within 75 feet of an existing *dwelling unit* (located in a *residential zoning district* and not located on the same property as the *use*).
- (4) Road Frontage. One hundred (100) or more feet.
- (5) Sign Areas. A minimum of 100 square feet of planted area (minimum five (5) foot width) shall be provided around the base of any freestanding *sign*.
- (6) Pedestrian Facilities. Sidewalks shall be a minimum of five (5) feet wide, excluding curb width.

SR 7.4. Convenience Store

- (1) Site Plan. *Major Site Plan* required in accordance with §42-330 (Major Site Plan Review).
- (2) Lighting. *Adequate lighting* shall be placed in areas used for vehicular/pedestrian access including, but not limited to: stairs, sidewalks, crosswalks, intersections, or changes in grade. *Lighting mitigation* required.

SR 2.5. Fuel Pumps


- (1) Structure Requirements. Fuel pumps may be covered by a canopy which shall not exceed 25 feet in height.
- (2) Separation Requirements. Fuel pumps shall not be placed within 100 feet of an existing *dwelling unit* (located in a *residential zoning district* and not located on the same property as the *use*), *school*, *library*, day care facility, healthcare facility, *park*, and/or *religious institution*.
- (3) Location of Drives. *Driveways* shall not be located closer than 50 feet to one another and no more than two (2) on a single *road*.

SR 6.5. Car Wash (Automatic and Self Service)

- (1) Site Plan. *Major Site Plan* required in accordance with §42-330 (Major Site Plan Review).

- (2) Lighting. *Adequate lighting* shall be placed in areas used for vehicular/pedestrian access including, but not limited to: stairs, sidewalks, crosswalks, intersections, or changes in grade. *Lighting mitigation* required.
- (3) Structure. All associated lanes and *driveways* shall be covered with an all-weather surface.
- (4) Parking/Drive. Parking areas/stacking facilities shall be designed to ensure parked/waiting *vehicles* do not block sidewalks, *driveways* or *roads*.
- (5) On-Site Drainage System. Provisions shall be made for an on-site drainage system to capture water used to wash *vehicles*. The drainage plan shall be evaluated by the *Zoning Administrator* to determine that the water from the facility will not have a detrimental effect on adjacent property, *roads* and/or surface waters.
- (6) Operations. Storage or repair of *vehicles* shall not be permitted within the car washing facility.
- (7) Screening. Screen Class Two (2) shall be provided consistent with the requirements of §42-181 (Screen Classification).

Map A: County Context

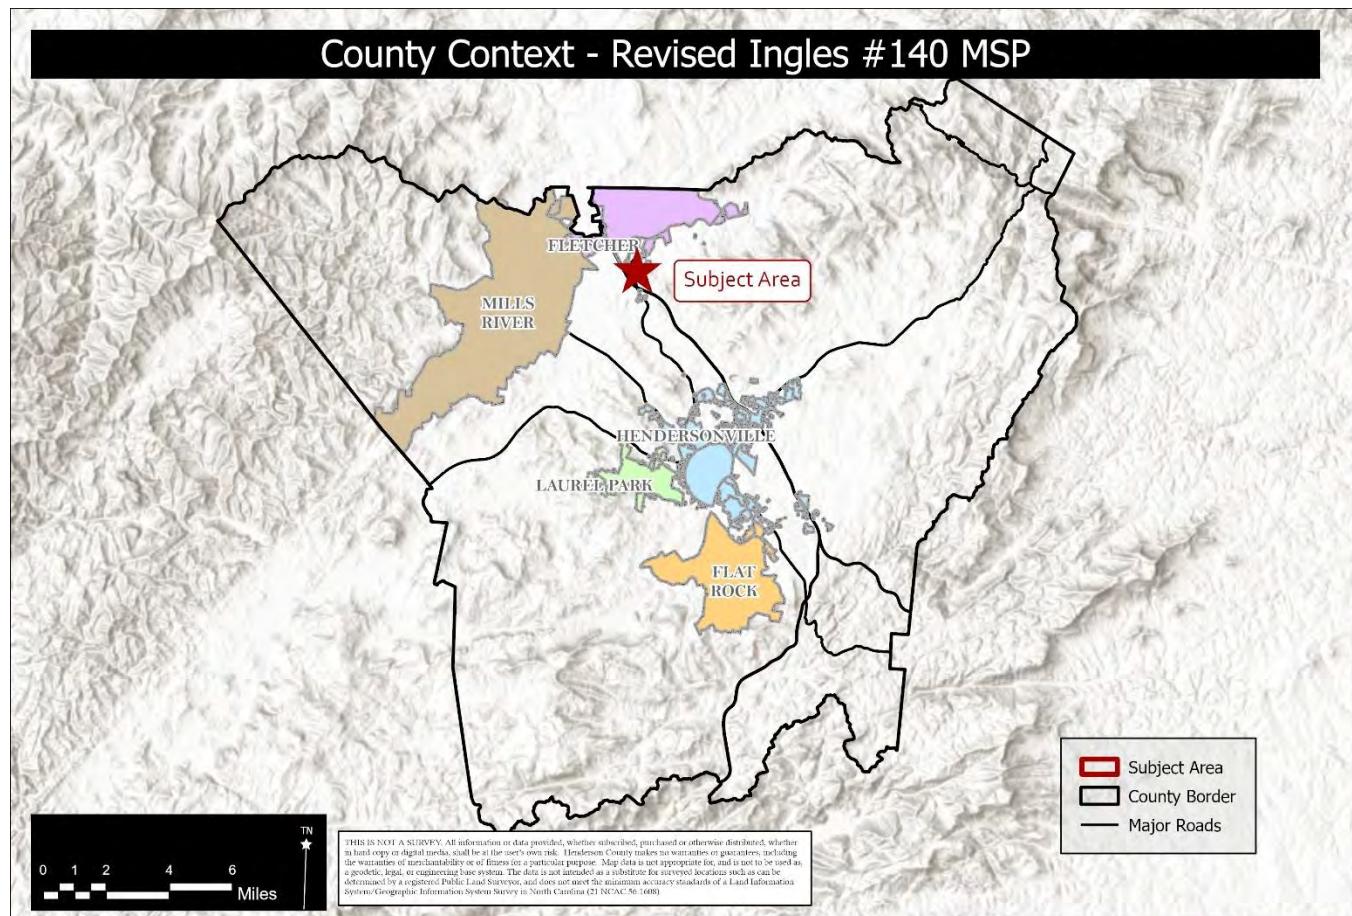

Property Owner: Ingles Markets, Inc. Applicant: Preston Kendall
Assessed Acreage: 11.2 Acres PINs: 9652-31-6641, 9652-31-4347, & 9652-31-6277
Current Zoning: Regional Commercial (RC)



Map B: Aerial Map



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2. Current Conditions

2.1 Current Use: One of the subject area's parcels contains an approximately 9,000SQFT warehouse structure. The rest of the subject is vacant with minimal improvements such as concrete.

2.2 Adjacent Area Uses: The surrounding properties consist of commercial and industrial uses. Smiley's Market is located to the north of the subject area.

3. Current Zoning


3.1. **Subject Area Zoning:** The subject area is currently zoned Regional Commercial (RC) by Henderson County.

3.2. **Adjacent Area Zoning:** The surrounding properties are zoned Regional Commercial (RC) to the north, east, south, and west. The Town of Fletcher's C-1 and C-2 zoning district is found to the northwest of the subject area. Industrial (I) zoning is found to the east of the subject area across the railroad tracts.

3.2.1. Regional Commercial (RC): "The purpose of the Regional Commercial (RC) zoning district is to foster orderly growth where the principal use of land is commercial. The intent of this district is to allow for commercial development consistent with the

recommendations of the Comprehensive Plan. In accordance with the Comprehensive Plan, the district will allow for and provide commercial development that: (1) includes a variety of retail sales and services, public and private administrations, offices and all other uses done primarily for sale or profit on the local, community, and regional level; (2) is directed largely to Community Service Centers as defined in the Comprehensive Plan; (3) is compatible with adjacent development and the surrounding community; and (4) will minimize congestion and sprawl. This general use district is meant to be utilized in areas designated as Urban (USA) in the Comprehensive Plan.” Residential density in Regional Commercial is sixteen (16) units per acre with a maximum impervious surface allowance of 80% (LDC §42-28).

Map C: Current Zoning

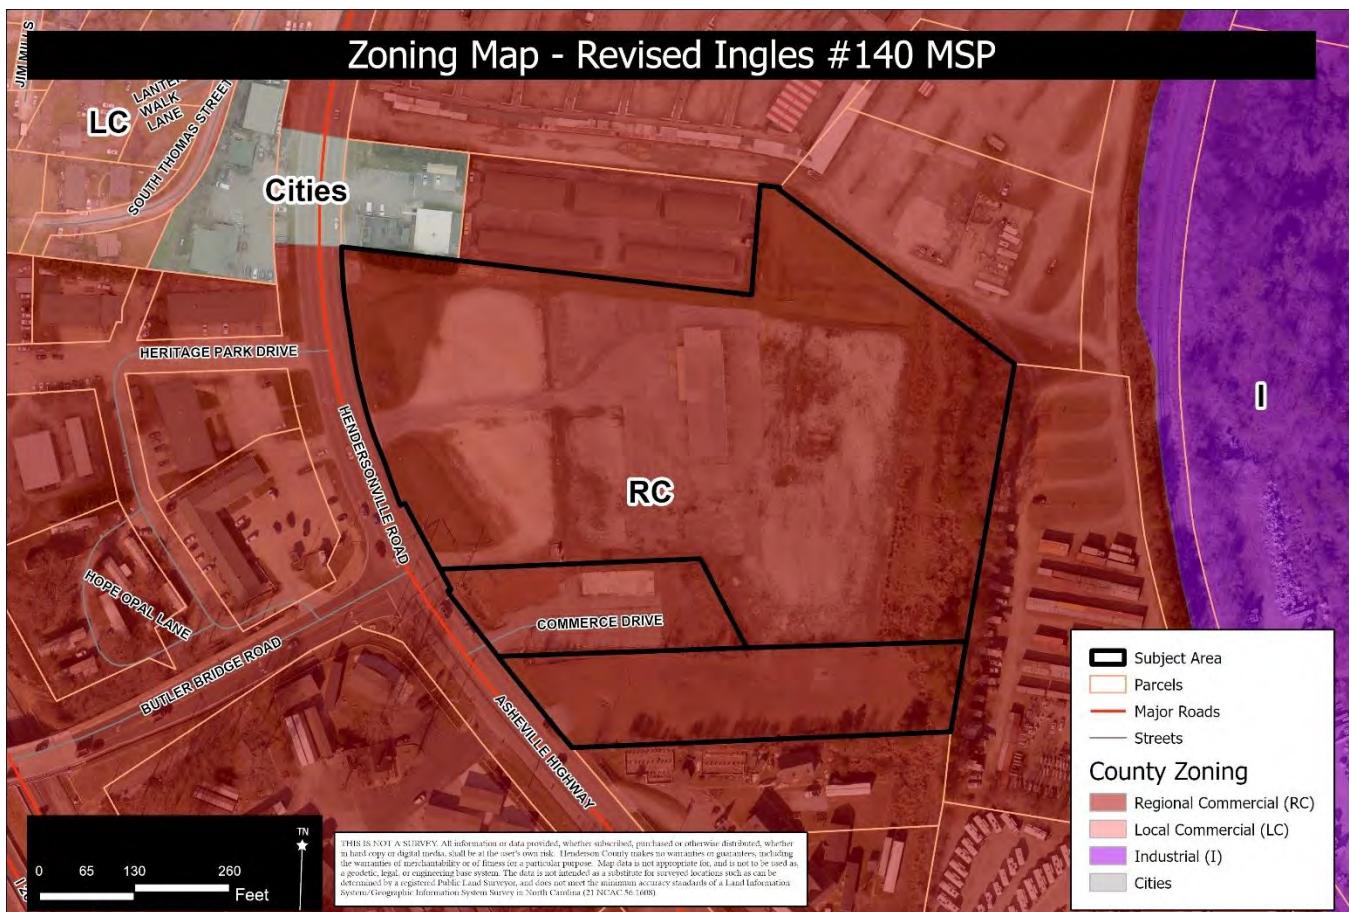


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4. **Floodplain /Watershed Protection** The property is not located in a Special Flood Hazard Area. The property is not in a Water Supply Watershed district.

Map D: Utilities Map



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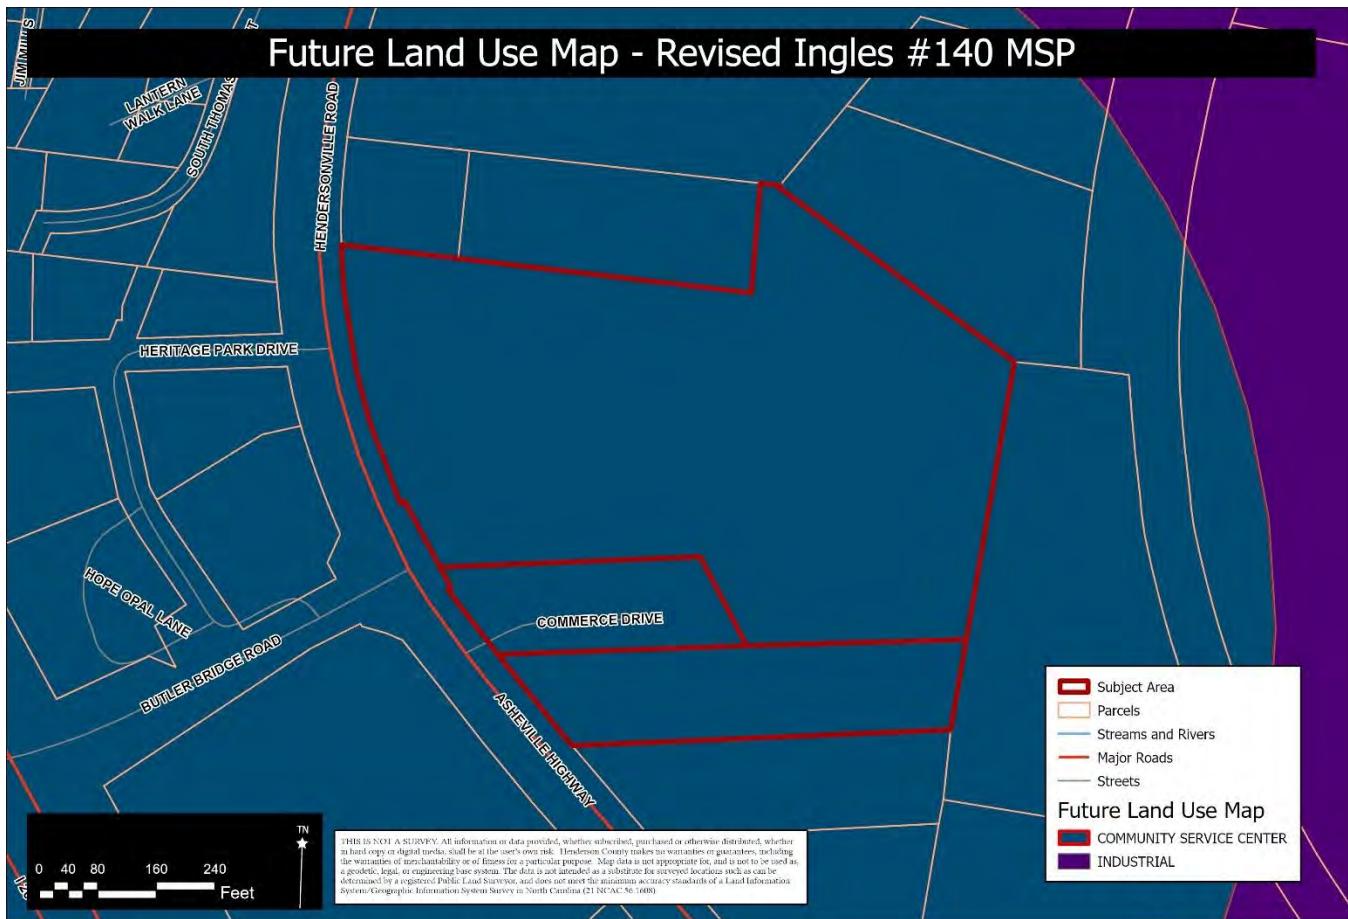


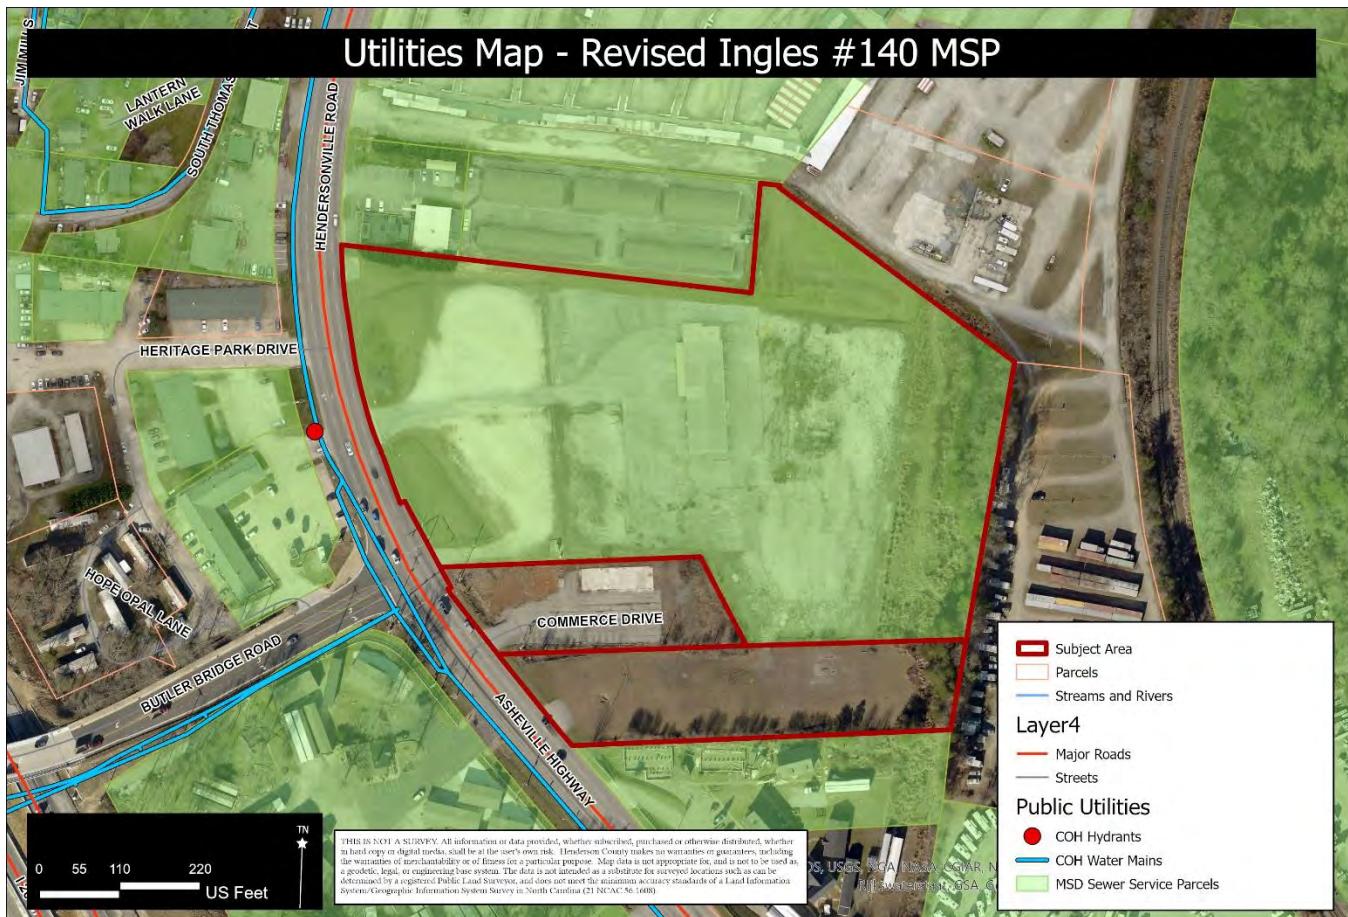5. **Water and Sewer** The applicant is proposing connection to the City of Hendersonville public water and MSD public sewer to serve this property. The applicant has submitted a water availability request to the City of Hendersonville.

Public Water: Yes

Public Sewer: Yes

Map E: CCP Future Land Use Map



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6. Staff Comments

Henderson County Comprehensive Plan (CCP): The CCP Future Land Use Map places the Subject Area in the Urban Services Area classification and within a Community Service Center.

- a. **Urban Services Area:** “The USA will contain virtually all existing and future industrial development and will be the focus of future economic development activities. Industrial development will exist within predefined zoning districts whose standards and configuration are in keeping with the surrounding community.” (CCP, Pg. 133)
- b. **Community Service Centers:** “Community Service Centers are intended to be intensive, efficient, defined concentrations of mixed services that meet the needs of the surrounding community and defined service areas. Community Service Centers are appropriate for a mixture of commercial uses scaled to the service area in question; residential uses of varying densities depending upon available services; and Community Facilities such as schools, parks, community centers, and other similar Community Facilities. The mixture and intensity of land uses contained within Community Service Centers are intended to be appropriate within the context of the surrounding community and intended service area. Community Service Centers should also be properly controlled by appropriate aesthetic standards, access management standards, and other appropriate development control measures.”

7. **Proposal** The applicant is proposing to construct a total of 114,166SQFT of retail sales and service space within 2 separate structures, a convenience store with gas/diesel pumps, and automatic carwash. The major site plan also shows a 9,600SQFT retail space that will be located on a outparcel. The major site plan also shows a total of 280 parking spaces to serve the entire property, with ADA accessible parking spaces throughout the subject area serving each structure. The major site plan also includes the following:
 - 7.1. 94,296SQFT grocery store
 - 7.2. 19,870SQFT retail space adjacent to the grocery store
 - 7.3. An unspecified 9,600SQFT retail store
 - 7.4. 6,125SQFT convenience store with gas and diesel pumps
 - 7.5. A drive through automatic carwash with vacuums
 - 7.6. Total of 8.9 acres of impervious surface area (79.5%)
 - 7.7. Total of 2.3 acres of pervious surface area (20.5%)
 - 7.8. Enclosed dumpster area
 - 7.9. Landscaped parking islands and grassed areas surrounding the site
 - 7.10. EV charging stations in the parking lots
8. **TIA** As part of this project, the applicant was required to submit a TIA to NCDOT. The revised major site plan shows 2 right-in and right-out access points into the property. The primary entrance to the property will be a signalized intersection directly across from where Butler Bridge Rd (SR1345) runs into US Hwy 25.
9. **Variance** The applicant has submitted a variance application, V-23-02, to reduce the front yard setback requirements from 30' to 25'. The Zoning Board of Adjustment will hold a quasi-judicial hearing on the request during their August 30th meeting. The variance request was due to additional right-of-way NCDOT requirement for improvements pertaining to ingress and egress.
10. **Landscaping & Buffering Requirements** The subject area is not required to buffer the permitter of the property since the surrounding properties all fall within the Regional Commercial (RC) zoning district. The subject area will have to provide a landscaping plan for the following elements:
 - 10.1. **Parking area landscaping** is required for new parking areas with 10 or more dedicated parking spaces. The parking area standards requires 1 small or large deciduous tree for every 5 parking spaces. Additionally, when no buffer is required along the property lines and parking is proposed within 20' of a property line, a planting strip is required. The planting strip is a minimum of 10' in width and shall contain 2 small or large deciduous or evergreen trees per 100 linear feet.
 - 10.2. **Car wash buffer/screening** requires a Screen Class Two (2) that consists of a row of conical evergreen plants (minimum of 8' in height at maturity) planted in the 15' area around that use and structure which is to be screened and spaced a maximum of 15' apart.
 - 10.3. **Dumpster screening** is required for a proposed solid waste collection facility. The dumpster will require a Screen Class One (1) Two (2) or Three (3) that are outlined in Section 42-181 Screen Classifications.

11. Oblique Aerial Photos

View from East



01/07/2022

View from North



01/06/2022

View from South



01/07/2022

View from West



01/07/2022

HENDERSON COUNTY
MAJOR SITE PLAN REVIEW APPLICATION

CONTACT INFORMATION

Property Owner:

Name: Ingles Markets, Inc. Phone: 828.669.2941
Complete Address: P.O. Box 6676, Asheville, NC 28816

Applicant:

Name: Ingles Markets, Inc. - Preston Kendall Phone: 828.669.2941
Complete Address: P.O. Box 6676, Asheville, NC 28816

Agent:

Name: _____ Phone: _____
Complete Address: _____
Agent Form (Circle One): Yes No

Plan Preparer:

Name: Land Planning Associates of NC, Inc - John Cox Phone: 864.242.6072
Complete Address: 110 West 1st Avenue, Easley, SC 29640

GENERAL INFORMATION

Date of Application: _____

Site Plan Attached (Circle One): Yes No

PARCEL INFORMATION

PIN: 9652316641 Tract Size (Acres): 11.20

Zoning District: RC Fire District: _____

Supplemental Requirement# _____ Watershed: _____

Permitted by Right _____ Floodplain: _____

Special Use Permit _____


Location / Property to be developed: 5620 Hendersonville Road, Fletcher, NC 28732

County Use Only

Fee: \$ _____ Paid: _____ Method: _____ Received by: _____

APPLICATION IDENTIFICATION		N.C. DEPARTMENT OF TRANSPORTATION STREET AND DRIVEWAY ACCESS PERMIT APPLICATION	
Driveway Permit No.	Date of Application		
County: Henderson			
Development Name: Ingles #140			
LOCATION OF PROPERTY:			
Route/Road: Hendersonville Road			
Exact Distance 1021	<input type="checkbox"/> Miles <input checked="" type="checkbox"/> Feet	N S E W <input checked="" type="checkbox"/> <input type="checkbox"/> <input type="checkbox"/> <input type="checkbox"/>	
From the Intersection of Route No. Hendersonville Road and Route No.		US Hwy 26	Toward Fletcher
Property Will Be Used For: <input type="checkbox"/> Residential /Subdivision <input checked="" type="checkbox"/> Commercial <input type="checkbox"/> Educational Facilities <input type="checkbox"/> TND <input type="checkbox"/> Emergency Services <input type="checkbox"/> Other			
Property:	<input type="checkbox"/> is	<input type="checkbox"/> is not	within City Zoning Area.
AGREEMENT			
<ul style="list-style-type: none"> • I, the undersigned property owner, request access and permission to construct driveway(s) or street(s) on public right-of-way at the above location. • I agree to construct and maintain driveway(s) or street entrance(s) in absolute conformance with the current "Policy on Street and Driveway Access to North Carolina Highways" as adopted by the North Carolina Department of Transportation. • I agree that no signs or objects will be placed on or over the public right-of-way other than those approved by NCDOT. • I agree that the driveway(s) or street(s) will be constructed as shown on the attached plans. • I agree that that driveway(s) or street(s) as used in this agreement include any approach tapers, storage lanes or speed change lanes as deemed necessary. • I agree that if any future improvements to the roadway become necessary, the portion of driveway(s) or street(s) located on public right-of-way will be considered the property of the North Carolina Department of Transportation, and I will not be entitled to reimbursement or have any claim for present expenditures for driveway or street construction. • I agree that this permit becomes void if construction of driveway(s) or street(s) is not completed within the time specified by the "Policy on Street and Driveway Access to North Carolina Highways". • I agree to pay a \$50 construction inspection fee. Make checks payable to NCDOT. This fee will be reimbursed if application is denied. • I agree to construct and maintain the driveway(s) or street(s) in a safe manner so as not to interfere with or endanger the public travel. • I agree to provide during construction proper signs, signal lights, flaggers and other warning devices for the protection of traffic in conformance with the current "Manual on Uniform Traffic Control Devices for Streets and Highways" and Amendments or Supplements thereto. Information as to the above rules and regulations may be obtained from the District Engineer. • I agree to indemnify and save harmless the North Carolina Department of Transportation from all damages and claims for damage that may arise by reason of this construction. • I agree that the North Carolina Department of Transportation will assume no responsibility for any damages that may be caused to such facilities, within the highway right-of-way limits, in carrying out its construction. • I agree to provide a Performance and Indemnity Bond in the amount specified by the Division of Highways for any construction proposed on the State Highway system. • The granting of this permit is subject to the regulatory powers of the NC Department of Transportation as provided by law and as set forth in the N.C. Policy on Driveways and shall not be construed as a contract access point. • I AGREE TO NOTIFY THE DISTRICT ENGINEER WHEN THE PROPOSED WORK BEGINS AND WHEN IT IS COMPLETED. 			
2004-01	NOTE: Submit Four Copies of Application to Local District Engineer, N.C. Department of Transportation 61-03419		
		TEB 65-04rev.	

SIGNATURES OF APPLICANT

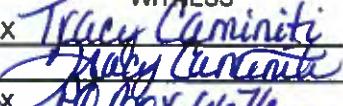PROPERTY OWNER (APPLICANT)		WITNESS	
COMPANY	X Ingle Markets, Inc. - Preston Kendall	NAME	x Tracy Caminiti
SIGNATURE		SIGNATURE	
ADDRESS	x P.O. Box 6676, Asheville, NC 28816	ADDRESS	x P.O. Box 6676 x Asheville NC 28816
	X Phone No. x828.669.2941		
AUTHORIZED AGENT		WITNESS	
COMPANY		NAME	
SIGNATURE		SIGNATURE	
ADDRESS		ADDRESS	
	Phone No.		

APPROVALS

APPLICATION RECEIVED BY DISTRICT ENGINEER

SIGNATURE

DATE

APPLICATION APPROVED BY LOCAL GOVERNMENTAL AUTHORITY (when required)

SIGNATURE

TITLE

DATE

APPLICATION APPROVED BY DISTRICT ENGINEER

SIGNATURE

DATE

INSPECTION BY NCDOT

SIGNATURE

TITLE

DATE

COMMENTS:

REVISIONS:

NO.	DATE	DESCRIPTION	BY
1	8/26/22	REVISED SITE ANALYSIS BLOCK	SCW
2	9/1/22	REVISED ZIPS PAY BOOTHS	SCW
3	6/28/23	REVISED PER DOT COMMENTS AND BUILDING CHANGE	JDC
4	7/20/23	REVISED JOINTS IN SIDEWALK AND RELOCATED CUSTOMER PICKUP	JDC

7/20/23
B.M.

CORPORATE SEAL:




DBA
LAND PLANNING ASSOCIATES OF NC, INC.
110 WEST 1ST AVENUE - SUITE A
EASLEY, SC 29640
864.242.6072
design@pa-inc.net

ingles
Markets Incorporated
STORE #140
5620 HENDERSONVILLE ROAD
FLETCHER NC

PROPERTY INFORMATION:
TAX MAP NUMBER: 9652316641, 9652316277
REFERENCE D.B. & PG: DB 3396 PG 597
ADDITIONAL INFO: 9652314347
DB 3464 PG 102

ISSUE FOR CONSTRUCTION:
PERMIT DATE:
BID DATE:
DRAWN BY: PCB
DESIGN BY: JDC
CHECKED BY: PMR
DATE: 4/11/22
SCALE: HORIZ. 1' = 50' VERT.
JOB NUMBER: 21.018

SITE PLAN
C-104
STORE #140
HENDERSONVILLE ROAD
FLETCHER NC

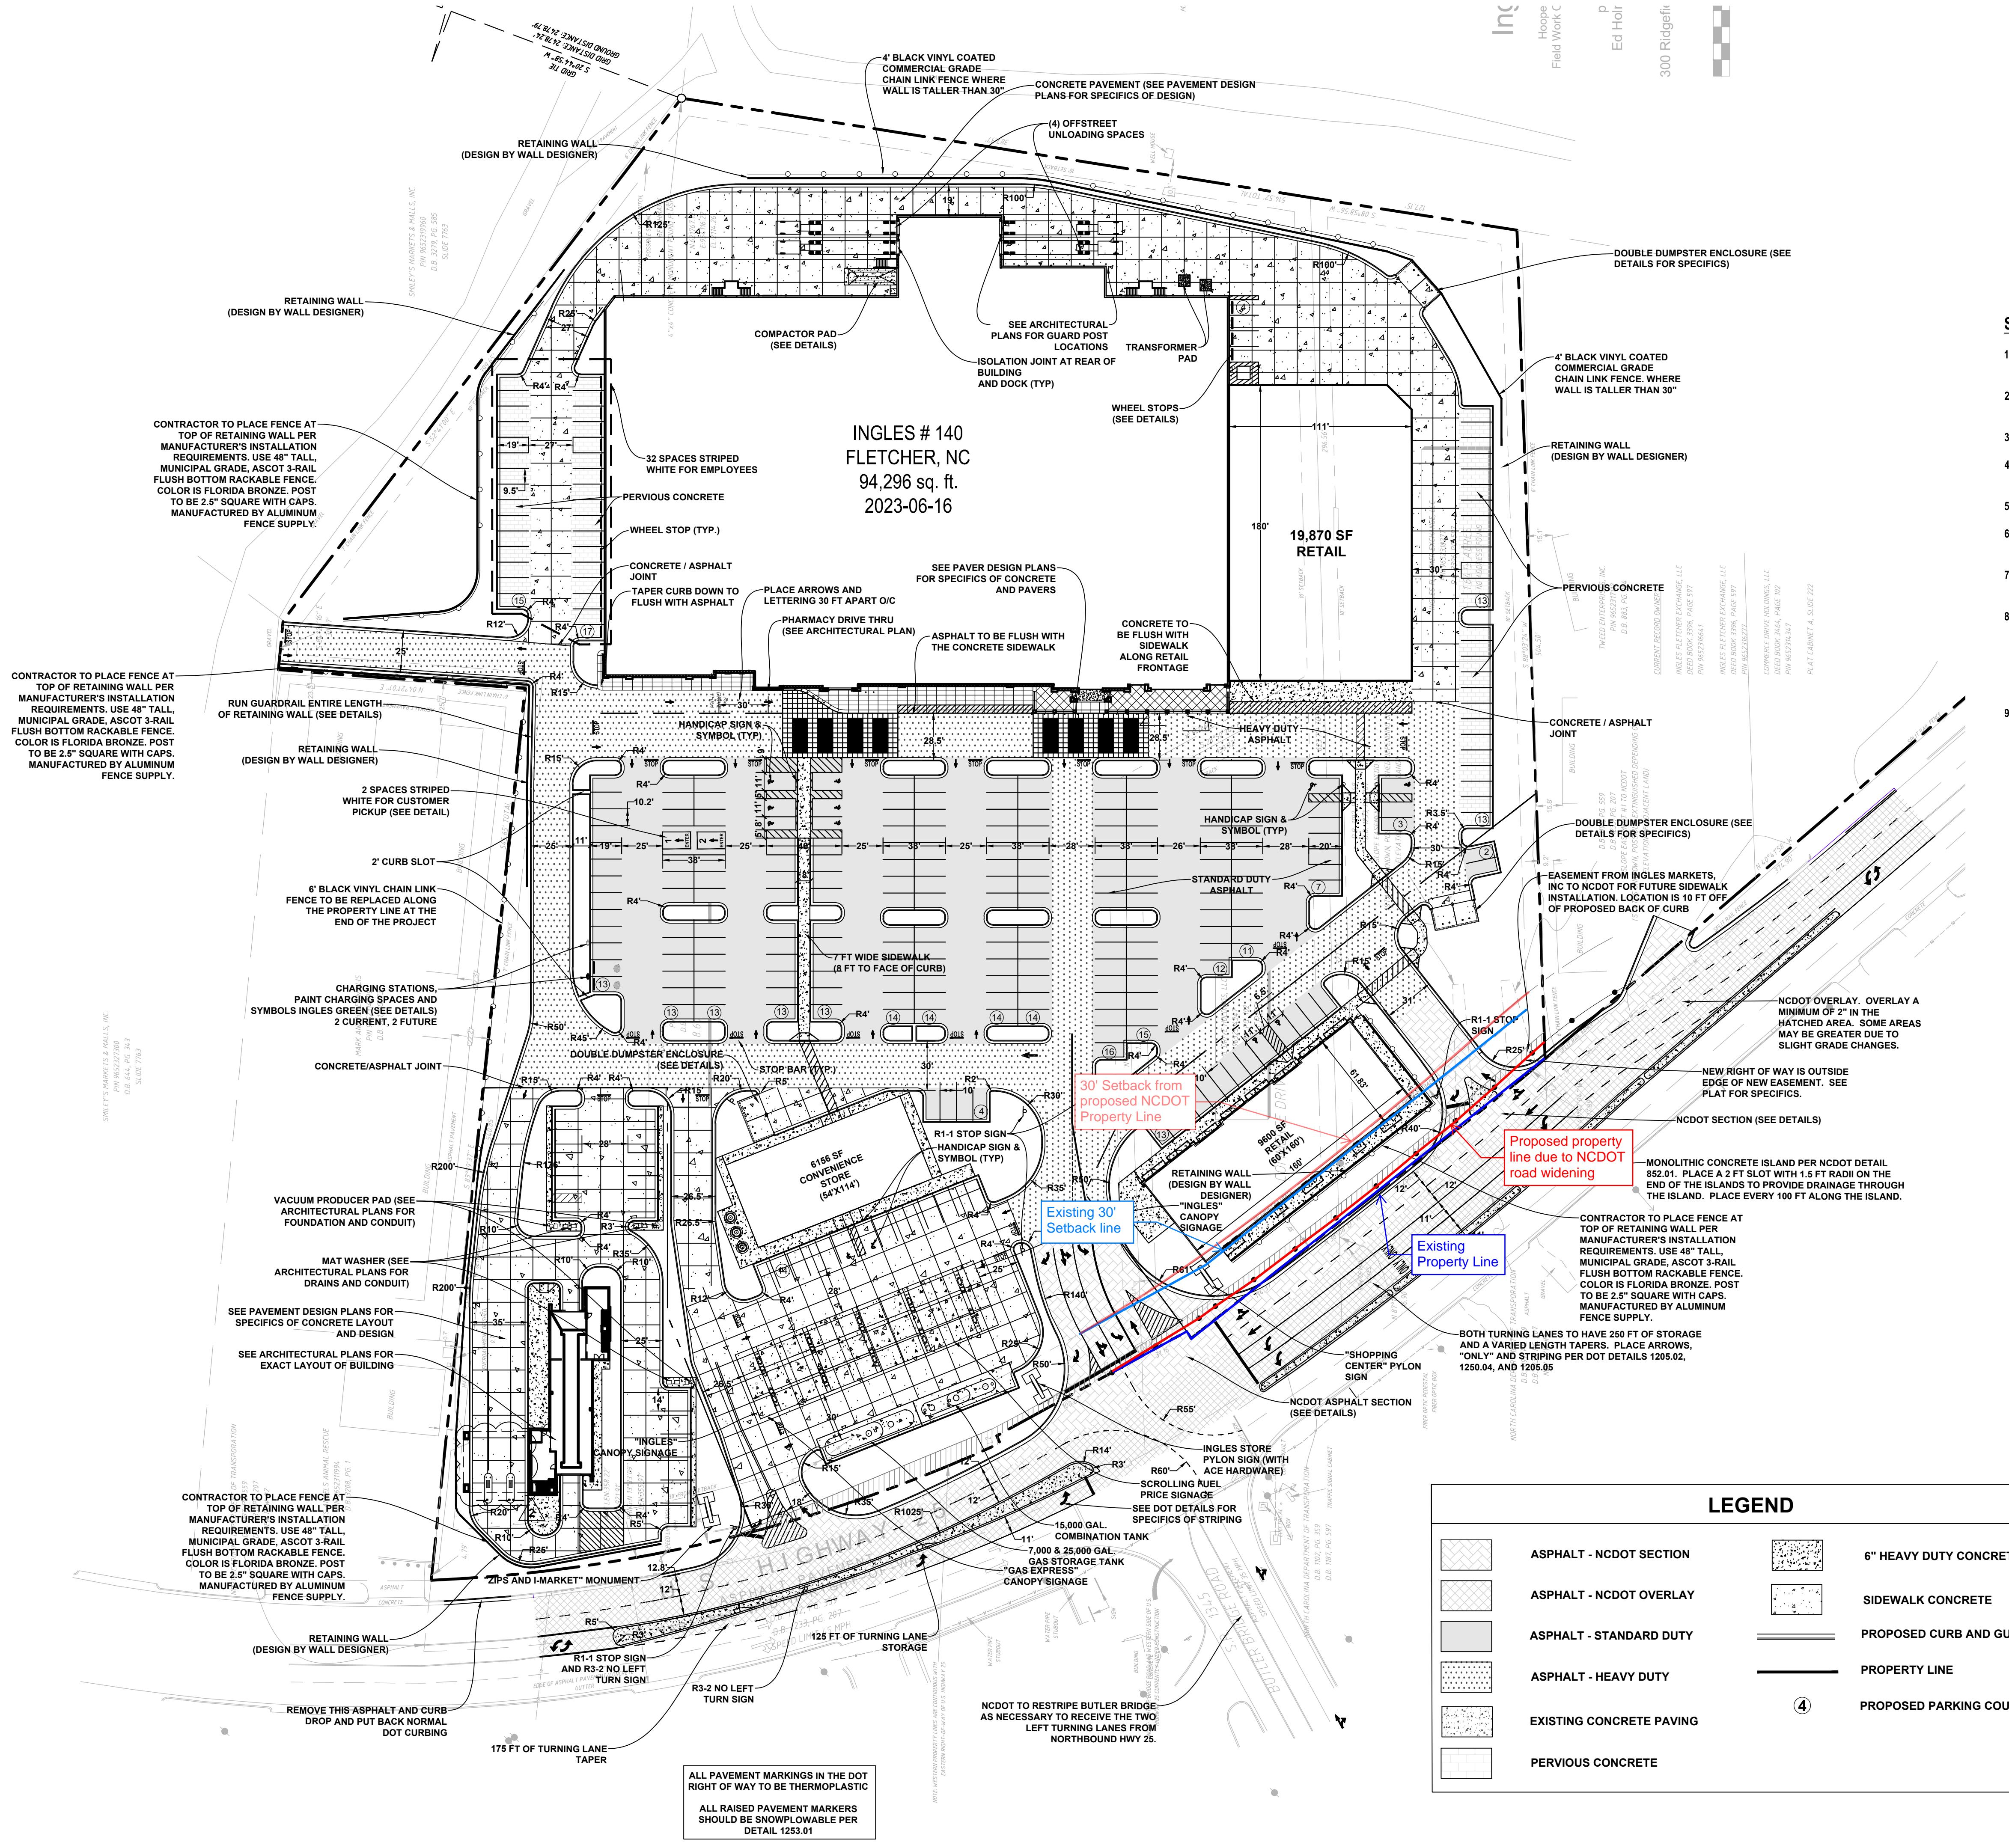

NO.	DATE	DESCRIPTION	BY
1	8/26/22	REVISED CONTACTS	SCW
2	6/28/23	ADDED NCDOT DETAIL SHEETS REVISED NCDOT CONTACT	JDC

SITE DEVELOPMENT PLANS

FOR

ingles

Markets Incorporated

STORE NO. 140
5620 HENDERSONVILLE ROAD
FLETCHER, NC 28732



GOVERNING AGENCIES

WATER
 CITY OF HENDERSONVILLE WATER
 160 6TH AVE. EAST
 HENDERSONVILLE, NC 28792
 828.243.3740
 ATTN: ADAM STUERER

NCDOT
 4142 HAYWOOD ROAD
 MILLS RIVER, NC 28742
 828.891.7911
 ATTN: TROY WILSON

SANITARY SEWER
 METROPOLITAN SEWER DISTRICT
 2028 RIVERSIDE DRIVE
 ASHEVILLE, NC 28804
 828.225.8289
 ATTN: KEVIN JOHNSON

TELEPHONE
 AT&T
 24 O'HENRY AVENUE
 ASHEVILLE, NC 28801
 828.279.3114
 ATTN: MATT STRICKLAND

STORMWATER & EROSION CONTROL
 HENDERSON COUNTY
 240 SECOND AVENUE EAST
 HENDERSONVILLE, NC 28792
 828.694.6553
 ATTN: NATALIE BERRY

PLANNING DEPARTMENT
 HENDERSON COUNTY
 100 NORTH KING STREET
 HENDERSONVILLE, NC 28792
 828.694.6555
 ATTN: MATT CHAMPION

OWNER / DEVELOPER

OWNER 1

INGLES FLETCHER EXCHANGE, LLC
 P.O. BOX 6676
 ASHEVILLE, NC 28816
 ATTN: RANDY JAMESON
 (VP OF REAL ESTATE)

OWNER 2

COMMERCE DRIVE HOLDINGS, LLC
 301 COLLEGE STREET, SUITE 110
 ASHEVILLE, NC 28801
 ATTN: ROBERT P INGLE II

CIVIL ENGINEER

LAND PLANNING ASSOCIATES OF NC, INC.
 110 WEST 1ST AVENUE SUITE A
 EASLEY, SC 29640
 864.242.6072
 ATTN: JOHN D. COX, PE

ARCHITECT

ROBERTSON LOIA ROOF, P.C.
 3460 PRESTON RIDGE RD. SUITE 275
 ALPHARETTA, GA 30005
 770.674.2600
 FAX: 678.319.0745
 ATTN: SAMIA COKER

LANDSCAPE ARCHITECT

DESIGN ASSOCIATES
 1293 HENDERSONVILLE RD. SUITE 21
 ASHEVILLE, NC 28803
 828.277.7410
 ATTN: CLAY MOONEY

CIVIL DRAWING LIST

SHEET	TITLE
C-100	COVER SHEET
C-101	EXISTING CONDITIONS
C-102	DEMOLITION PLAN
C-103	EROSION CONTROL PHASE I
C-103B	EROSION CONTROL PHASE II
C-104	SITE PLAN
C-105	GRADING AND STORMWATER PLAN
C-106	UTILITY PLAN
C-107	OVERLAY PLAN
C-108	STORMWATER PLAN AND PROFILE
C-109	STORMWATER PLAN AND PROFILE
C-110	STORMWATER PLAN AND PROFILE
C-111	SEWER PLAN AND PROFILE
C-112	SEWER PLAN AND PROFILE
C-113	SITE DETAILS
C-114	SITE AND UTILITY DETAILS
C-115	UTILITY DETAILS
C-116	EROSION CONTROL DETAILS
C-117	EROSION CONTROL DETAILS
C-118	SEEDING NOTES
C-119	SEEDING NOTES
C-120	DUMPSTER ENCLOSURE DETAILS
C-121	NCDOT DETAILS
C-121A	NCDOT DETAILS
C-121B	NCDOT DETAILS
C-122	TOPSOIL PLAN
C-123	CAR CHARGING DETAILS
C-124	UNDERGROUND DETENTION DETAILS
C-125	UNDERGROUND DETENTION DETAILS

ingles

Markets Incorporated
STORE #140
 5620 HENDERSONVILLE ROAD
 FLETCHER NC

PROPERTY INFORMATION:

TAX MAP NUMBER: 9652316641, 9652316277
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 DB 3464 PG 102


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 DESIGN BY: JDC
 CHECKED BY: PMR
 DATE: 4/19/22
 SCALE: HORIZ. VERT.
 JOB NUMBER: 21.018

COVER SHEET

C-100

STORE #140
 HENDERSONVILLE ROAD
 FLETCHER NC

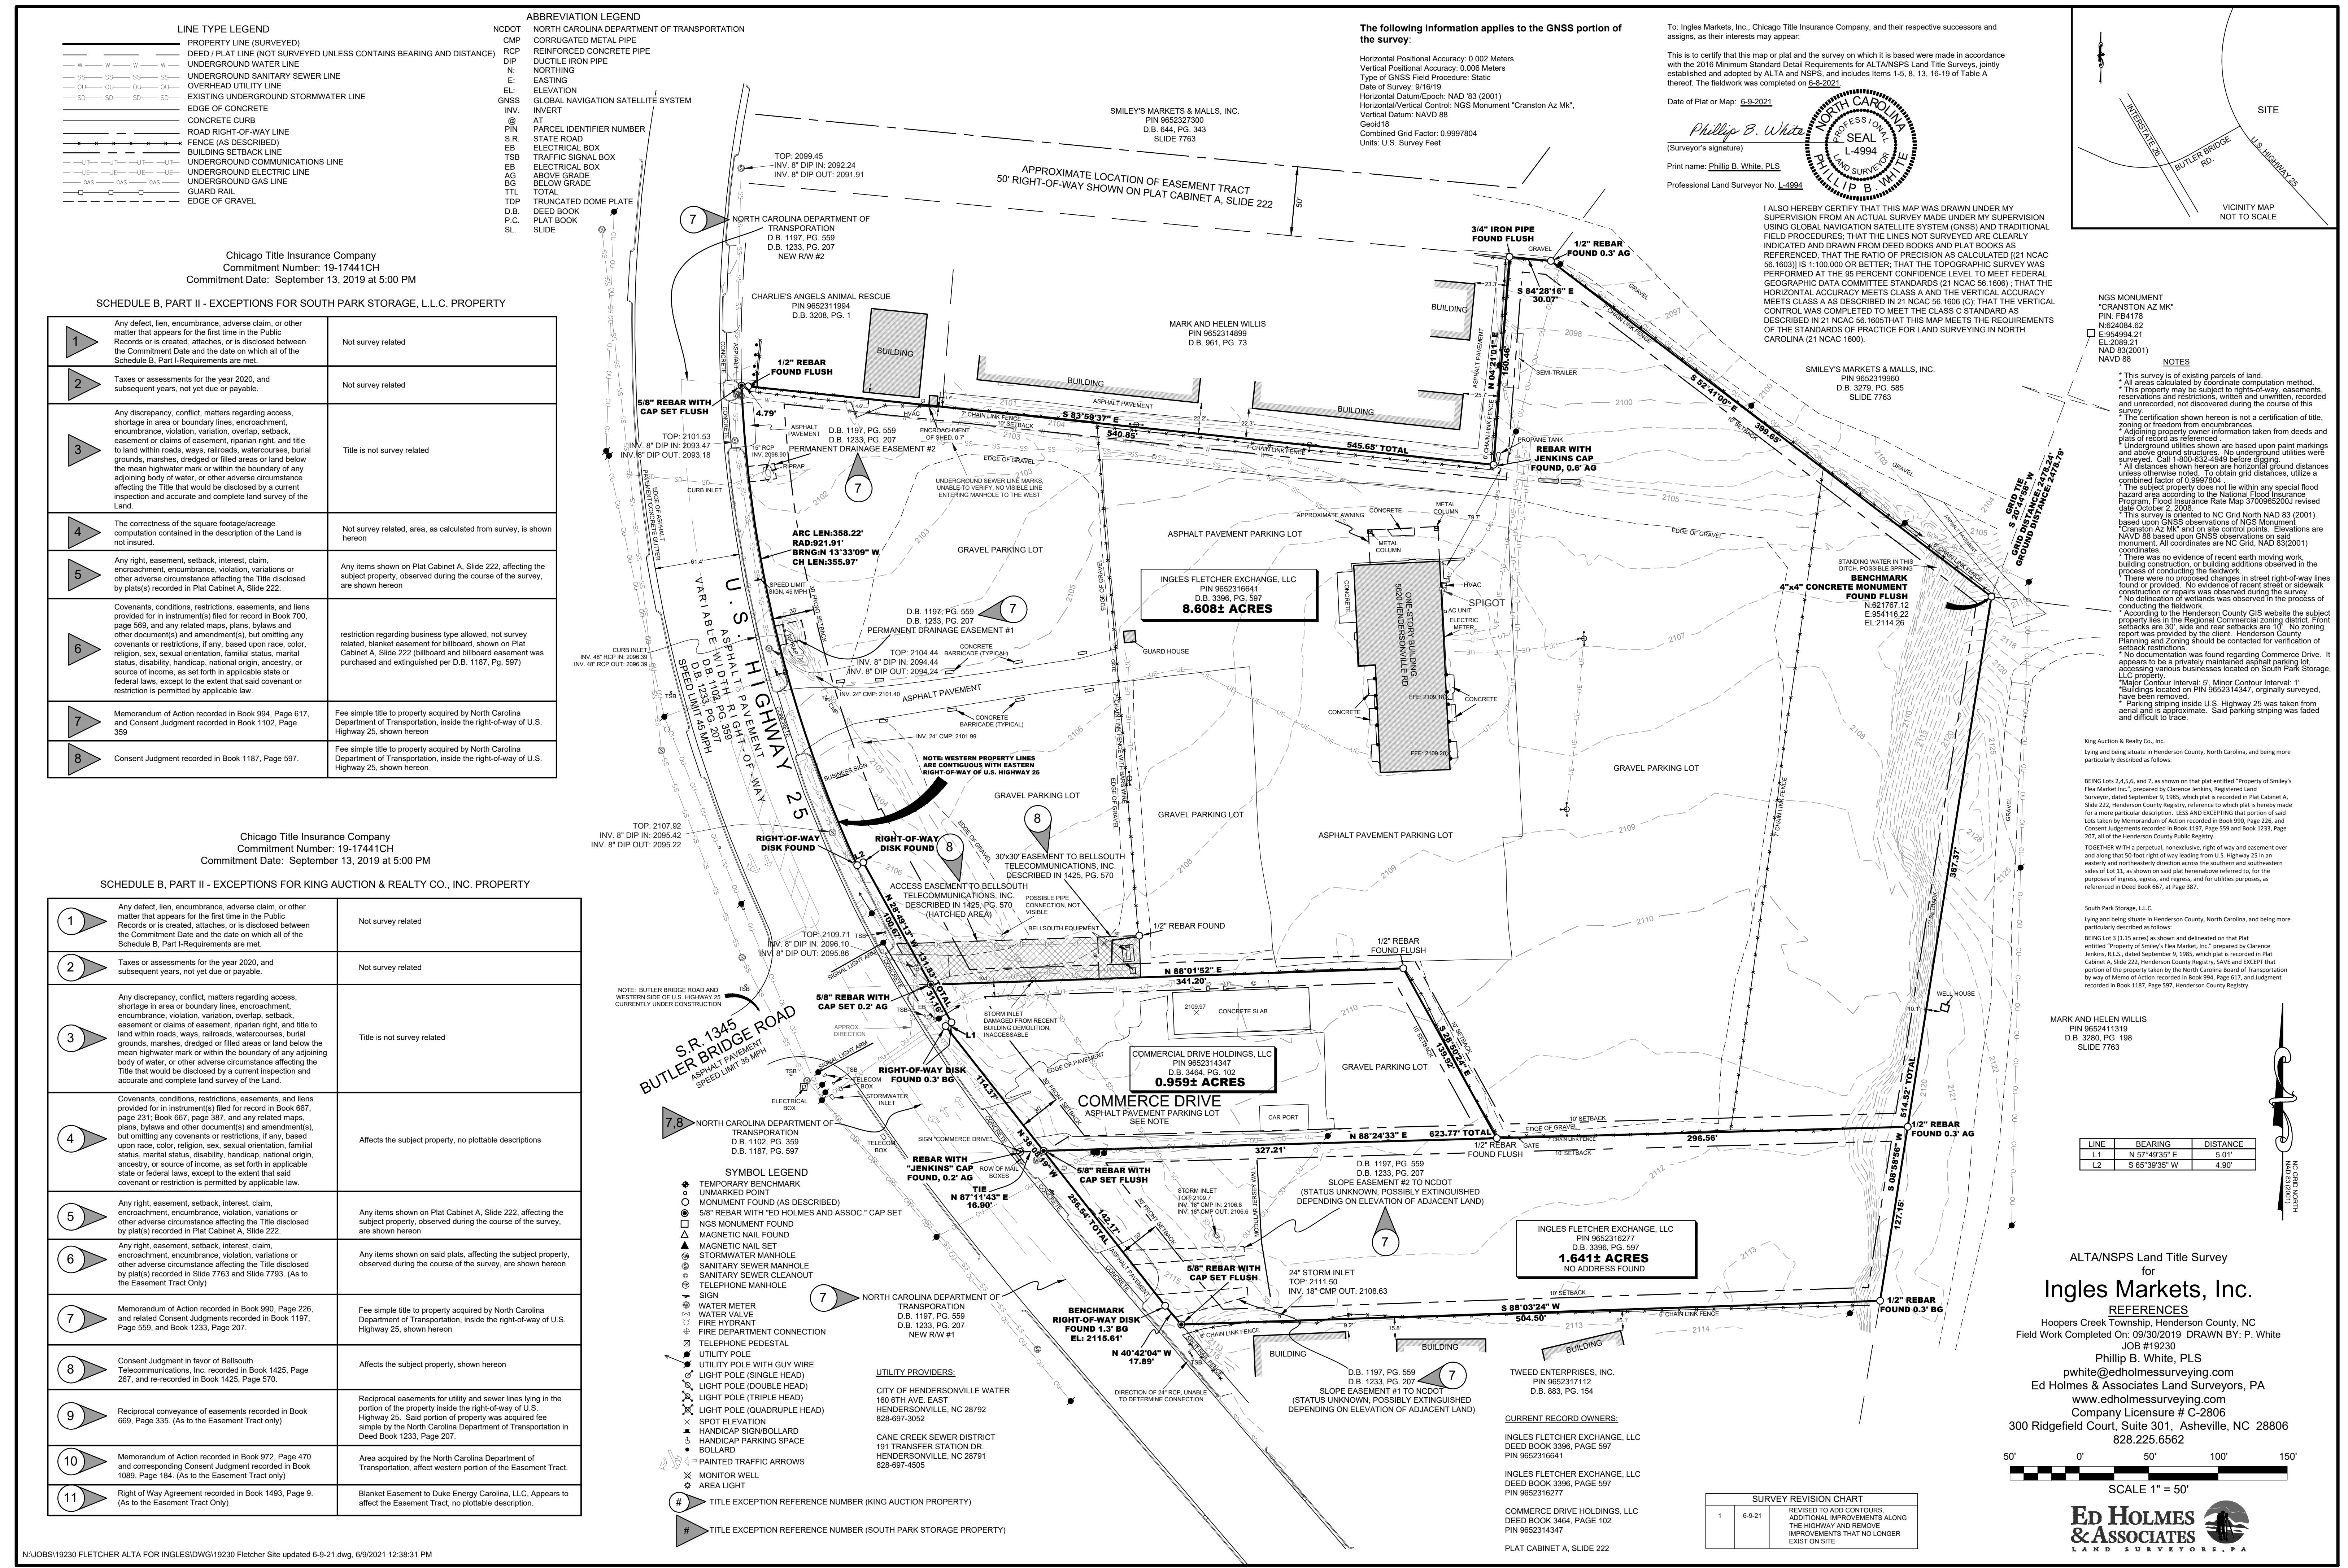

REVISIONS:

NO.	DATE	DESCRIPTION	BY
1	8/26/22	REVISED CIVIL DEMOLITION NOTES	SCW
2	6/28/23	REVISED TO INCLUDE NCDOT ROAD WORK	SCW

CIVIL DEMOLITION NOTES:

- THE CONTRACTOR IS RESPONSIBLE FOR OBTAINING ALL PERMITS REQUIRED FOR THE DEMOLITION AND REMOVAL OF THE STRUCTURES LOCATED ON THIS SITE.
- CONTRACTOR TO SAW-CUT EXISTING PAVEMENT AS REQUIRED TO REMOVE PAVEMENT AS REQUIRED.
- INFORMATION CONCERNING UNDERGROUND UTILITIES WAS OBTAINED FROM AVAILABLE RECORDS AND FIELD LOCATIONS WHEN POSSIBLE, BUT THE CONTRACTOR MUST DETERMINE THE EXACT LOCATION AND ELEVATION OF ALL EXISTING UTILITIES BY DIGGING TEST PITS BY HAND AT ALL CROSSINGS WELL IN ADVANCE OF TRENCHING. IF CLEARANCES ARE LESS THAN SPECIFIED ON THE PLAN OR TWELVE INCHES (12'), WHICHEVER IS LESS, CONTACT THE DESIGN ENGINEER AND THE OWNER PRIOR TO PROCEEDING WITH CONSTRUCTION.
- THE CONTRACTOR SHALL REMOVE EXISTING STORM DRAIN LINES, ASPHALT PAVEMENT, CONCRETE CURB, AND ANY OTHER EXISTING CONDITION WHICH WILL INTERFERE WITH THE WORK AS PROPOSED ON THESE PLANS.
- DEMOLITION SHALL BE PERFORMED IN ACCORDANCE WITH ALL FEDERAL, STATE, AND LOCAL REQUIREMENTS.
- ALL DEBRIS SHALL BE REMOVED FROM THE SITE AND DELIVERED TO A LICENSED TRANSFER STATION OR LANDFILL.
- THE TRENCHES WHERE EXISTING UTILITIES HAVE BEEN REMOVED OR RELOCATED SHALL BE RECOMPACTED TO 95% STANDARD PROCTOR.
- THE CONTRACTOR SHALL NOTIFY ALL PERTINENT UTILITY COMPANIES 48 HOURS PRIOR TO ANY DEMOLITION WORK. ALL DEMOLITION WORK SHALL BE COORDINATED WITH LOCAL UTILITY COMPANIES TO MINIMIZE IMPACTS ON UTILITY DOWN TIME.
- ALL EROSION CONTROL MEASURES SHALL BE IN PLACE BEFORE ANY DEMOLITION BEGINS (INCLUDES SEDIMENT BASIN SEEN ON EROSION CONTROL PHASE 1 PLAN)
- ALL WORK SHALL BE DONE IN ACCORDANCE WITH SITE SPECIFICATIONS.

SEAL:

6/28/23

CORPORATE SEAL:



DBA
LAND PLANNING ASSOCIATES OF NC, INC.
 110 WEST 1ST AVENUE - SUITE A
 EASLEY, SC 29640
 864.242.6072
 design@pa-inc.net

ingles

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STORE #140
5620 HENDERSONVILLE ROAD
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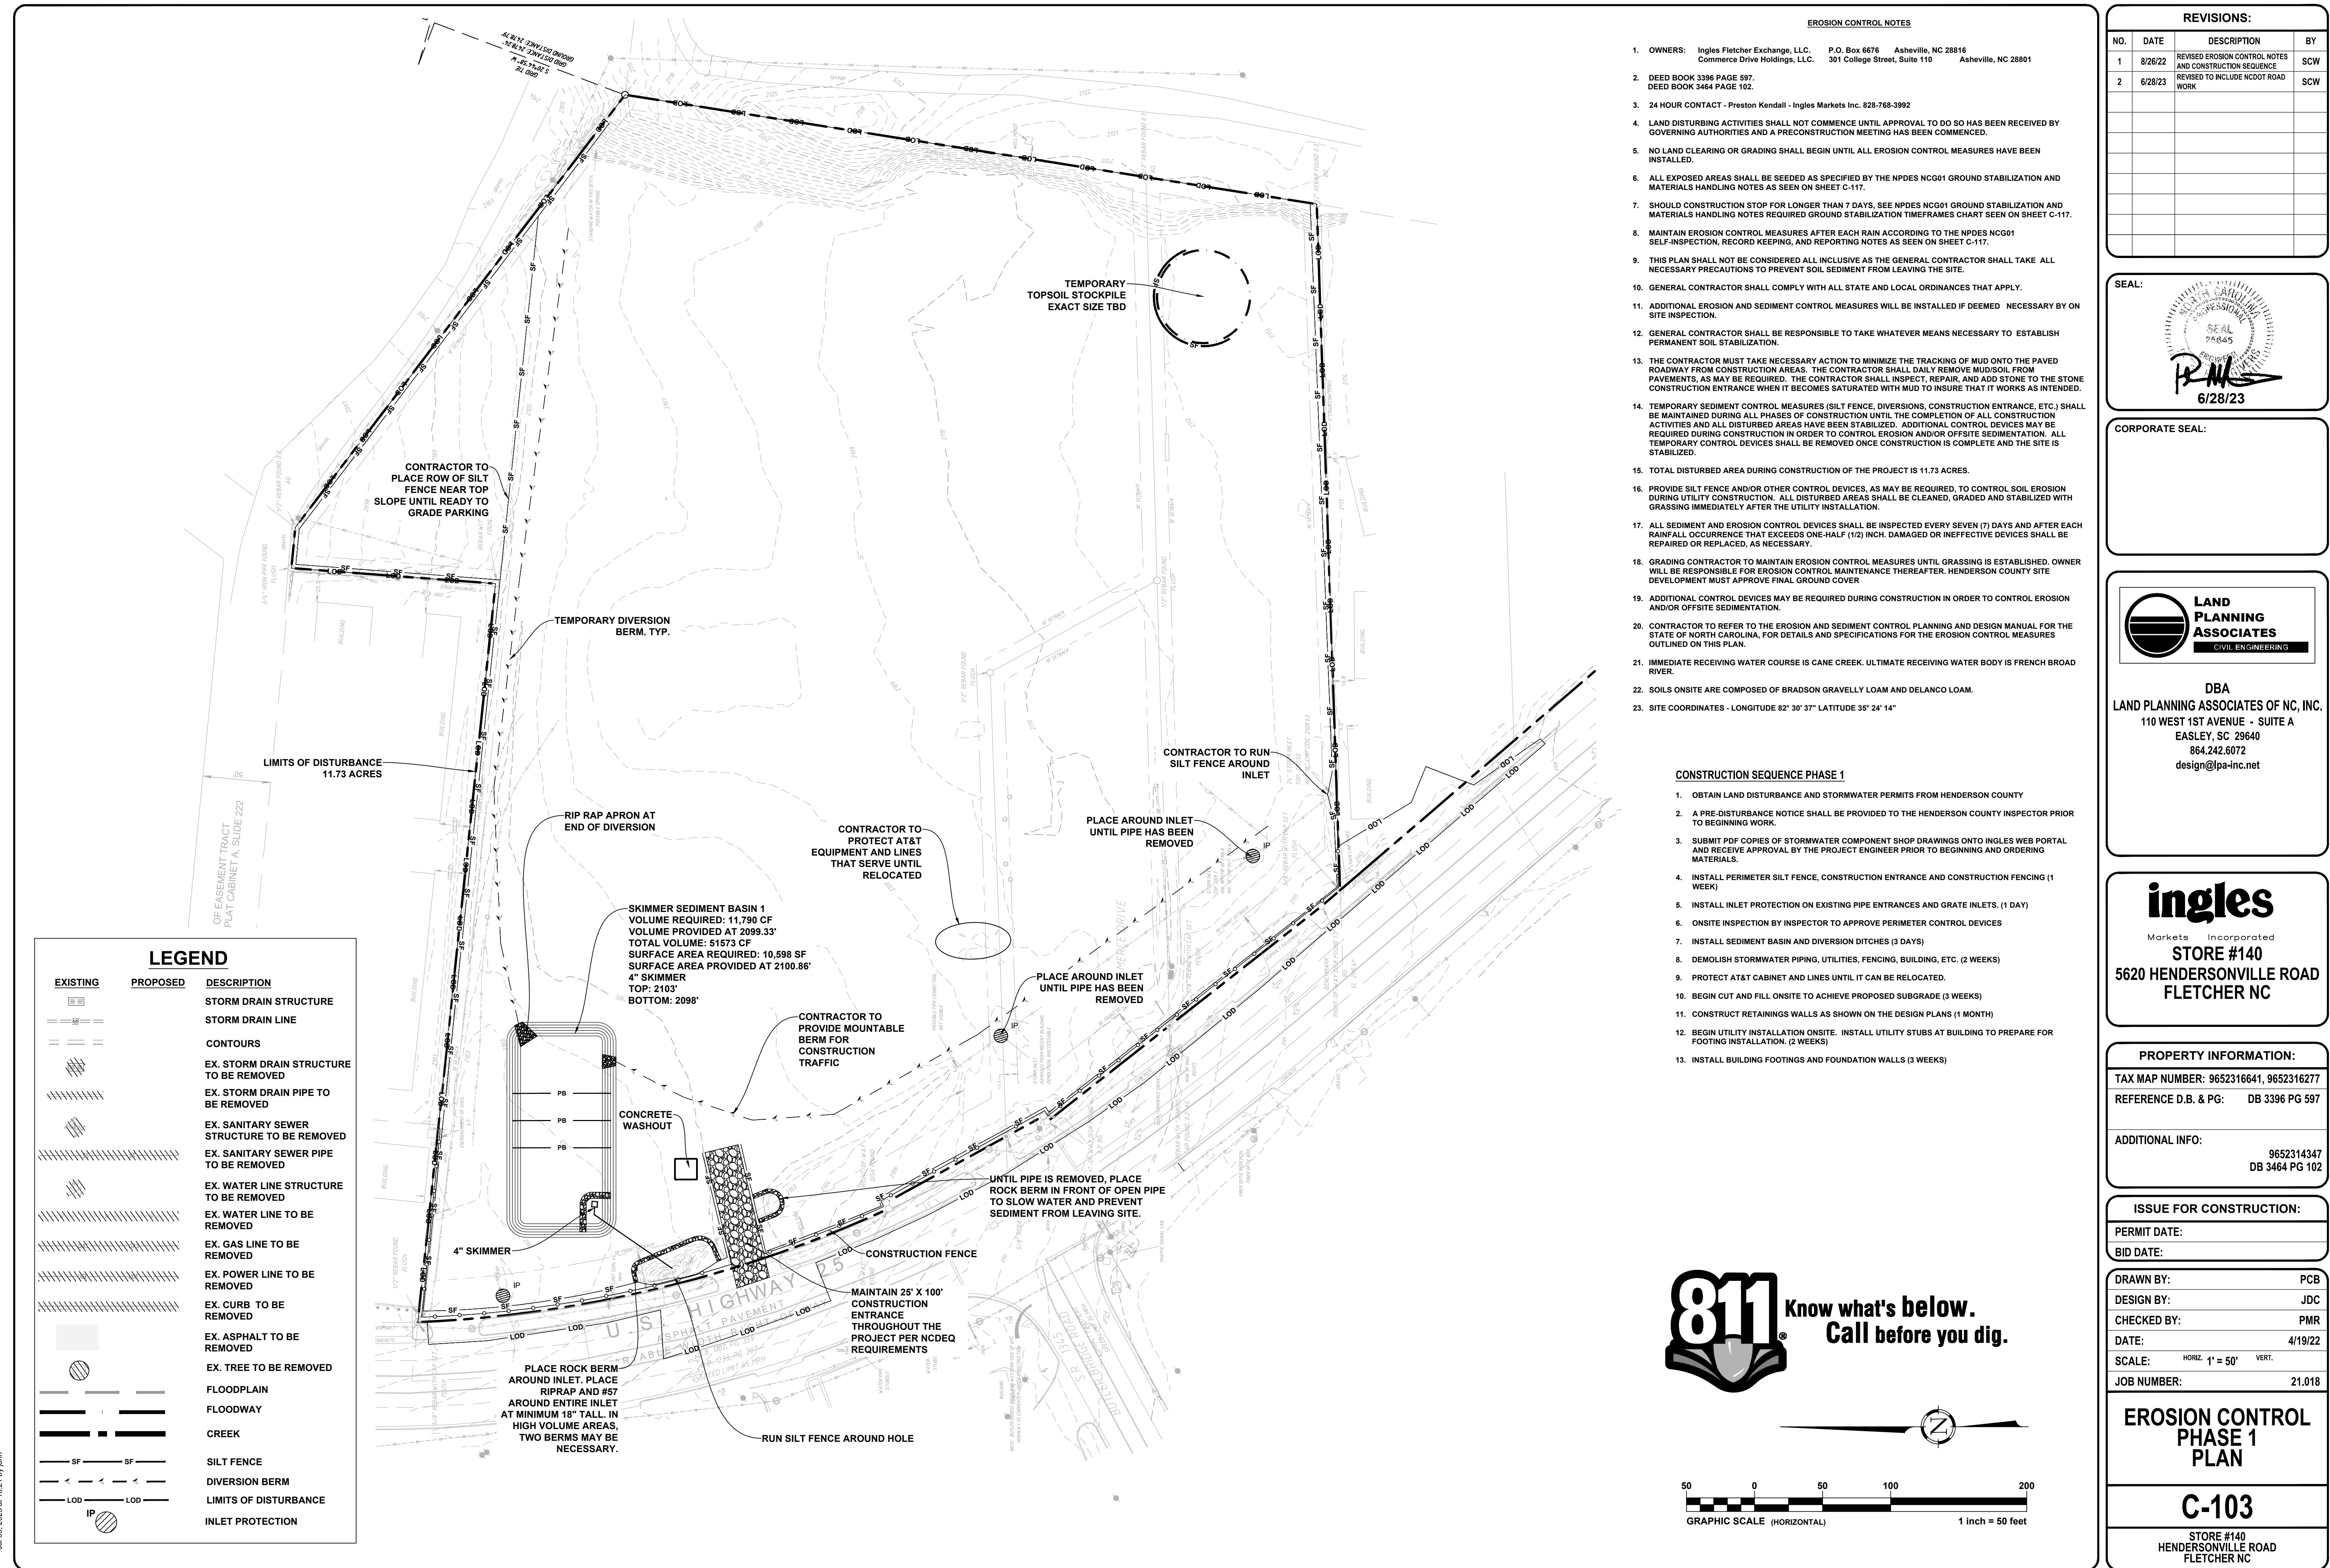
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 CHECKED BY: PMR
 DATE: 4/19/22
 SCALE: HORIZ. 1' = 50' VERT.
 JOB NUMBER: 21.018



50 0 50 100 200
 GRAPHIC SCALE (HORIZONTAL)
 1 inch = 50 feet

C-102STORE #140
 HENDERSONVILLE ROAD
 FLETCHER NC



REVISIONS:


NO.	DATE	DESCRIPTION	BY
1	8/26/22	REVISED EROSION CONTROL NOTES AND CONSTRUCTION SEQUENCE	SCW
2	6/28/23	REVISED TO INCLUDE NCDDT ROAD WORK	SCW

EROSION CONTROL NOTES

- OWNERS: Ingles Fletcher Exchange, LLC. P.O. Box 6676 Asheville, NC 28816 Commerce Drive Holdings, Inc. 301 College Street, Suite 110 Asheville, NC 28801
- DEED BOOK 3396 PAGE 597.
DEED BOOK 3464 PAGE 102.
- 24 HOUR CONTACT - Preston Kendall - Ingles Markets Inc. 828-768-3992
- LAND DISTURBING ACTIVITIES SHALL NOT COMMENCE UNTIL APPROVAL TO DO SO HAS BEEN RECEIVED BY GOVERNING AUTHORITIES AND A PRECONSTRUCTION MEETING HAS BEEN COMMENCED.
- NO LAND CLEARING OR GRADING SHALL BEGIN UNTIL ALL EROSION CONTROL MEASURES HAVE BEEN INSTALLED.
- ALL EXPOSED AREAS SHALL BE SEADED AS SPECIFIED BY THE NPDES NCG01 GROUND STABILIZATION AND MATERIALS HANDLING NOTES AS SEEN ON SHEET C-117.
- SHOULD CONSTRUCTION STOP FOR LONGER THAN 7 DAYS, SEE NPDES NCG01 GROUND STABILIZATION AND MATERIALS HANDLING NOTES REQUIRED GROUND STABILIZATION TIMEFRAMES CHART SEEN ON SHEET C-117.
- MAINTAIN EROSION CONTROL MEASURES AFTER EACH RAIN ACCORDING TO THE NPDES NCG01 SELF-INVESTIGATION, RECORD KEEPING, AND REPORTING NOTES AS SEEN ON SHEET C-117.
- THIS PLAN SHALL NOT BE CONSIDERED ALL INCLUSIVE AS THE GENERAL CONTRACTOR SHALL TAKE ALL NECESSARY PRECAUTIONS TO PREVENT SOIL SEDIMENT FROM LEAVING THE SITE.
- GENERAL CONTRACTOR SHALL COMPLY WITH ALL STATE AND LOCAL ORDINANCES THAT APPLY.
- ADDITIONAL EROSION AND SEDIMENT CONTROL MEASURES WILL BE INSTALLED IF DEEMED NECESSARY BY ON SITE INSPECTION.
- GENERAL CONTRACTOR SHALL BE RESPONSIBLE TO TAKE WHATEVER MEANS NECESSARY TO ESTABLISH PERMANENT SOIL STABILIZATION.
- THE CONTRACTOR MUST TAKE NECESSARY ACTION TO MINIMIZE THE TRACKING OF MUD ONTO THE PAVED ROADWAY FROM CONSTRUCTION AREAS. THE CONTRACTOR SHALL DAILY REMOVE MUD/SOIL FROM PAVEMENTS, AS MAY BE REQUIRED. THE CONTRACTOR SHALL INSPECT, REPAIR, AND ADD STONE TO THE STONE CONSTRUCTION ENTRANCE WHEN IT BECOMES SATURATED WITH MUD TO INSURE THAT IT WORKS AS INTENDED.
- TEMPORARY SEDIMENT CONTROL MEASURES (SILT FENCE, DIVERSIONS, CONSTRUCTION ENTRANCE, ETC.) SHALL BE MAINTAINED DURING ALL PHASES OF CONSTRUCTION UNTIL THE COMPLETION OF ALL CONSTRUCTION ACTIVITIES AND ALL DISTURBED AREAS HAVE BEEN STABILIZED. ADDITIONAL CONTROL DEVICES MAY BE REQUIRED DURING CONSTRUCTION IN ORDER TO CONTROL EROSION AND/OR OFFSITE SEDIMENTATION. ALL TEMPORARY CONTROL DEVICES SHALL BE REMOVED ONCE CONSTRUCTION IS COMPLETE AND THE SITE IS STABILIZED.
- TOTAL DISTURBED AREA DURING CONSTRUCTION OF THE PROJECT IS 11.73 ACRES.
- PROVIDE SILT FENCE AND/OR OTHER CONTROL DEVICES, AS MAY BE REQUIRED, TO CONTROL SOIL EROSION DURING UTILITY CONSTRUCTION. ALL DISTURBED AREAS SHALL BE CLEANED, GRADED AND STABILIZED WITH GRASSING IMMEDIATELY AFTER THE UTILITY INSTALLATION.
- ALL SEDIMENT AND EROSION CONTROL DEVICES SHALL BE INSPECTED EVERY SEVEN (7) DAYS AND AFTER EACH RAINFALL OCCURRENCE THAT EXCEEDS ONE-HALF (1/2) INCH. DAMAGED OR INEFFECTIVE DEVICES SHALL BE REPAIRED OR REPLACED, AS NECESSARY.
- GRADING CONTRACTOR TO MAINTAIN EROSION CONTROL MEASURES UNTIL GRASSING IS ESTABLISHED. OWNER WILL BE RESPONSIBLE FOR EROSION CONTROL MAINTENANCE THEREAFTER. HENDERSON COUNTY SITE DEVELOPMENT MUST APPROVE FINAL GROUND COVER.
- ADDITIONAL CONTROL DEVICES MAY BE REQUIRED DURING CONSTRUCTION IN ORDER TO CONTROL EROSION AND/OR OFFSITE SEDIMENTATION.
- CONTRACTOR TO REFER TO THE EROSION AND SEDIMENT CONTROL PLANNING AND DESIGN MANUAL FOR THE STATE OF NORTH CAROLINA, FOR DETAILS AND SPECIFICATIONS FOR THE EROSION CONTROL MEASURES OUTLINED ON THIS PLAN.
- IMMEDIATE RECEIVING WATER COURSE IS CANE CREEK. ULTIMATE RECEIVING WATER BODY IS FRENCH BROAD RIVER.
- SOILS ONSITE ARE COMPOSED OF BRADSON GRAVELLY LOAM AND DELANO LOAM.
- SITE COORDINATES - LONGITUDE 82° 30' 37" LATITUDE 35° 24' 14"

6/28/23
R.M.

SEAL:

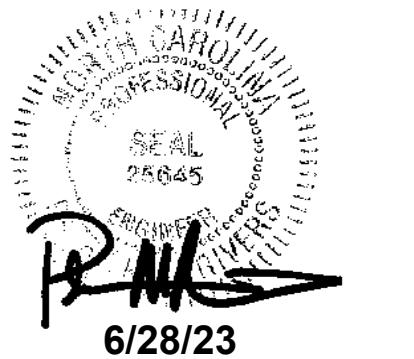

CORPORATE SEAL:



DBA
LAND PLANNING ASSOCIATES OF NC, INC.
110 WEST 1ST AVENUE - SUITE A
EASLEY, SC 29640
864.242.6072
design@pa-inc.net


ingles


Markets Incorporated
STORE #140
5620 HENDERSONVILLE ROAD
FLETCHER NC



50 0 50 100 200
GRAPHIC SCALE (HORIZONTAL)
1 inch = 50 feet

C-103B

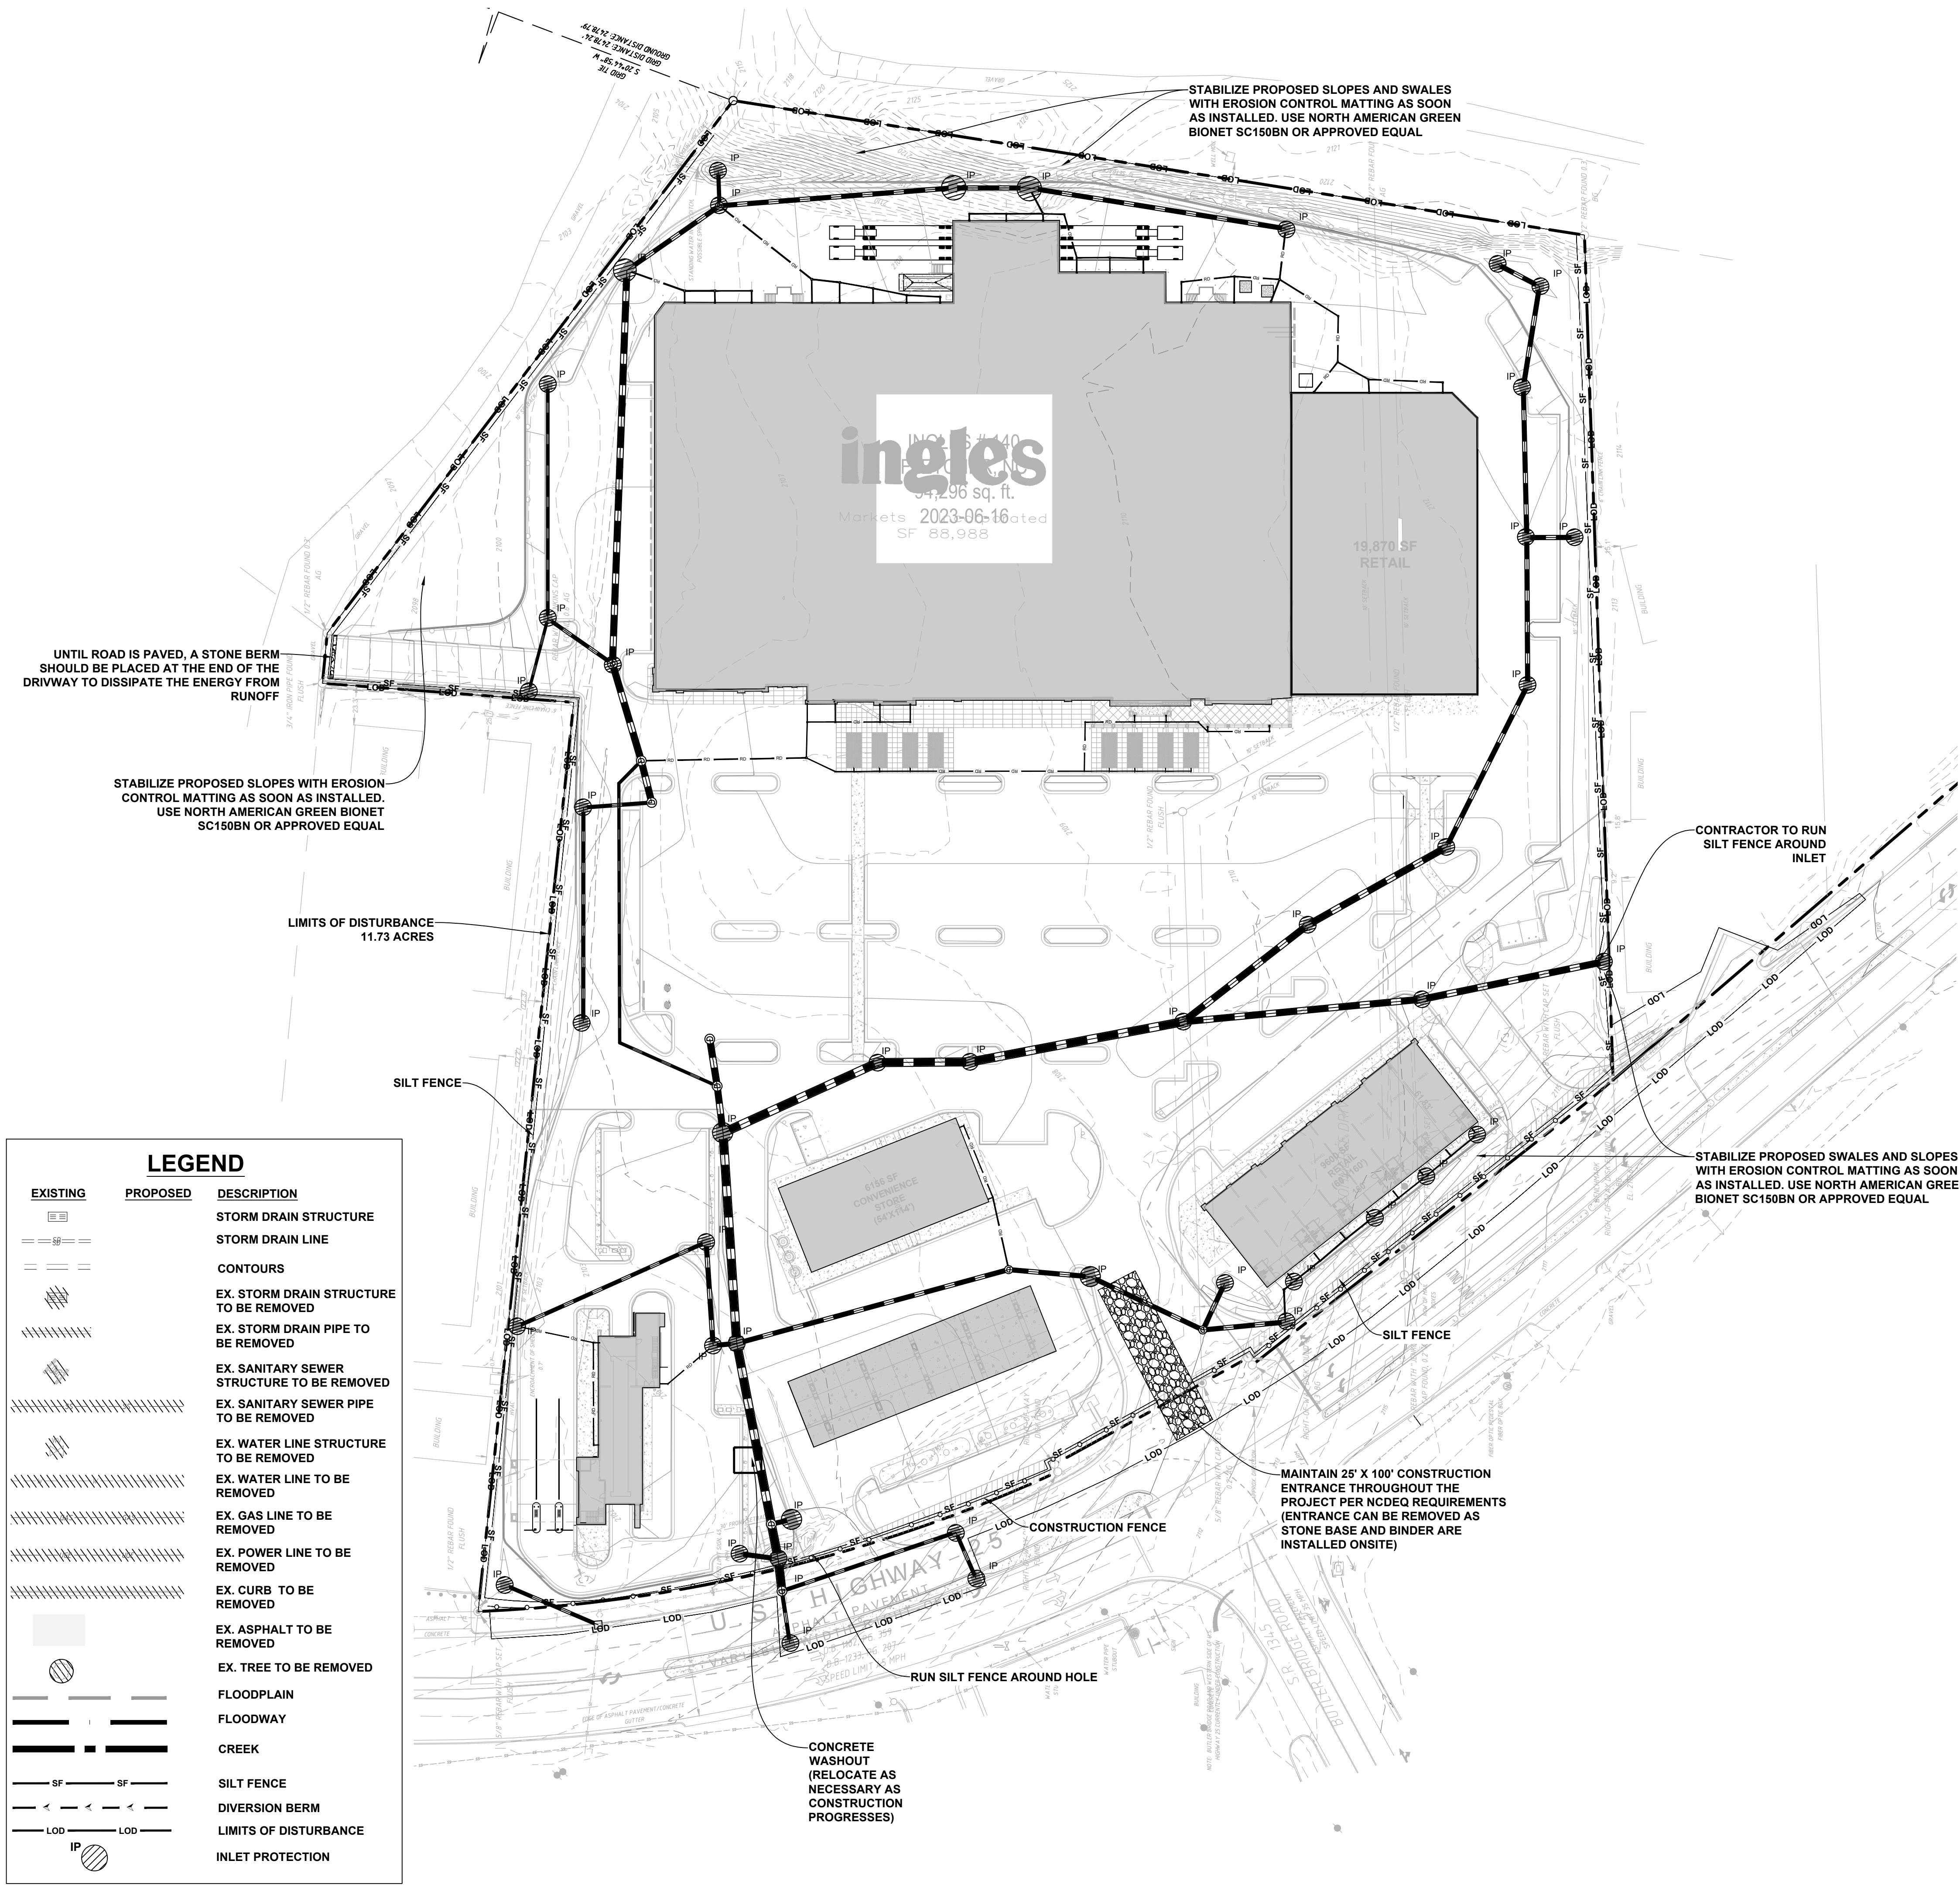STORE #140
HENDERSONVILLE ROAD
FLETCHER NC

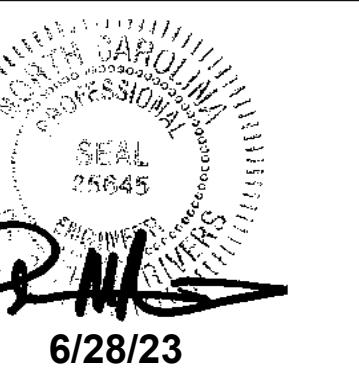

6/28/23

The seal is circular with a scalloped edge. The outer ring contains the text "NOTARY PUBLIC", "STATE OF SOUTH CAROLINA", "PROFESSIONAL NOTARY", and "SEAL NO. 25645". The inner circle features a stylized signature of "BRIAN M. JOHNSON" above the date "6/28/23".

SITE NOTES:

1. ALL WORK SHALL BE DONE IN STRICT ACCORDANCE WITH THE STANDARD SITE SPECIFICATIONS.
 2. ALL DIMENSIONS, UNLESS OTHERWISE NOTES, ARE TO FACE OF CURB, FACE OF BUILDING, OR CENTERLINE OF PARKING BAY.
 3. UNLESS NOTED OTHERWISE, PAVEMENT SHALL BE STANDARD DUTY PAVEMENT.
 4. ALL HANDICAP SPACES ARE TO RECEIVE A HANDICAP SIGN AND A HANDICAP SYMBOL PAINTED ON THE ASPHALT.
 5. ALL RADII SHALL BE 4' UNLESS OTHERWISE NOTED.
 6. ALL CONCRETE SIDEWALKS AND APRONS SHALL RECEIVE CONSTRUCTION JOINTS AT 25' ON CENTER UNLESS OTHERWISE NOTED.
 7. CONTRACTOR SHALL COORDINATE AND COMPLY WITH ALL UTILITY COMPANIES INVOLVED IN THE PROJECT AND PAY ALL REQUIRED FEES AND COSTS.
 8. ALL CUSTOMER PARKING STRIPING IS TO BE YELLOW WITHIN PROPERTY BOUNDARIES. ALL EMPLOYEE PARKING STRIPING IS TO BE WHITE TO DESIGNATE THEIR LOCATION. CAR CHARGING SPACES ARE TO BE GREEN PER CAR CHARGING DETAILS. CUSTOMER PICKUP SPACES ARE TO BE WHITE, PLEASE SEE DETAIL SHEET FOR LAYOUT. ALL STRIPING IN D.O.T. RIGHTS-OF-WAY OR LEADING TO A TRAFFIC SIGNAL IS TO BE WHITE THERMOPLASTIC UNLESS SPECIFIED ON THE PLANS DIFFERENTLY.
 9. THE SITE IS NOT WITHIN A FLOOD HAZARD AREA.

SITE ANALYSIS

PROPERTY OWNER 1:	INGLES FLETCHER EXCHANGE, LLC. P.O. BOX 6676 ASHEVILLE, NC 28816
PROPERTY OWNER 2:	COMMERCE DRIVE HOLDINGS, LLC. 301 COLLEGE STREET, SUITE 110 ASHEVILLE, NC 28801

The logo features the word "ingles" in a large, bold, black, sans-serif font. The letters have a textured, almost wood-grain appearance. Below it, the words "Markets Incorporated" are written in a smaller, standard black font. Underneath that, "STORE #140" is displayed in a large, bold black font. At the bottom, the address "5620 HENDERSONVILLE ROAD" is followed by "FLETCHER NC" in a large, bold black font.

PROPERTY INFORMATION

TAX MAP NUMBER: 9652316641, 9652316277




ADDITIONAL INFO

ISSUE FOR CONSTRUCTION:

PERMIT D

BID DATE:		
DRAWN BY: PCB		
DESIGN BY: JDC		
CHECKED BY: PMR		
DATE:	4/11/22	
SCALE:	HORIZ. 1' = 50'	VERT.
JOB NUMBER: 21.018		


LEGEND

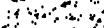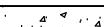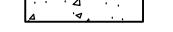	ASPHALT - NCDOT SECTION		6" HEAVY DUTY CONCRETE PAVING
	ASPHALT - NCDOT OVERLAY		SIDEWALK CONCRETE
	ASPHALT - STANDARD DUTY		PROPOSED CURB AND GUTTER
	ASPHALT - HEAVY DUTY		PROPERTY LINE
	EXISTING CONCRETE PAVING		PROPOSED PARKING COUNT
	PERVIOUS CONCRETE		



C-104

**STORE #140
HENDERSONVILLE ROAD
FLETCHER NC**

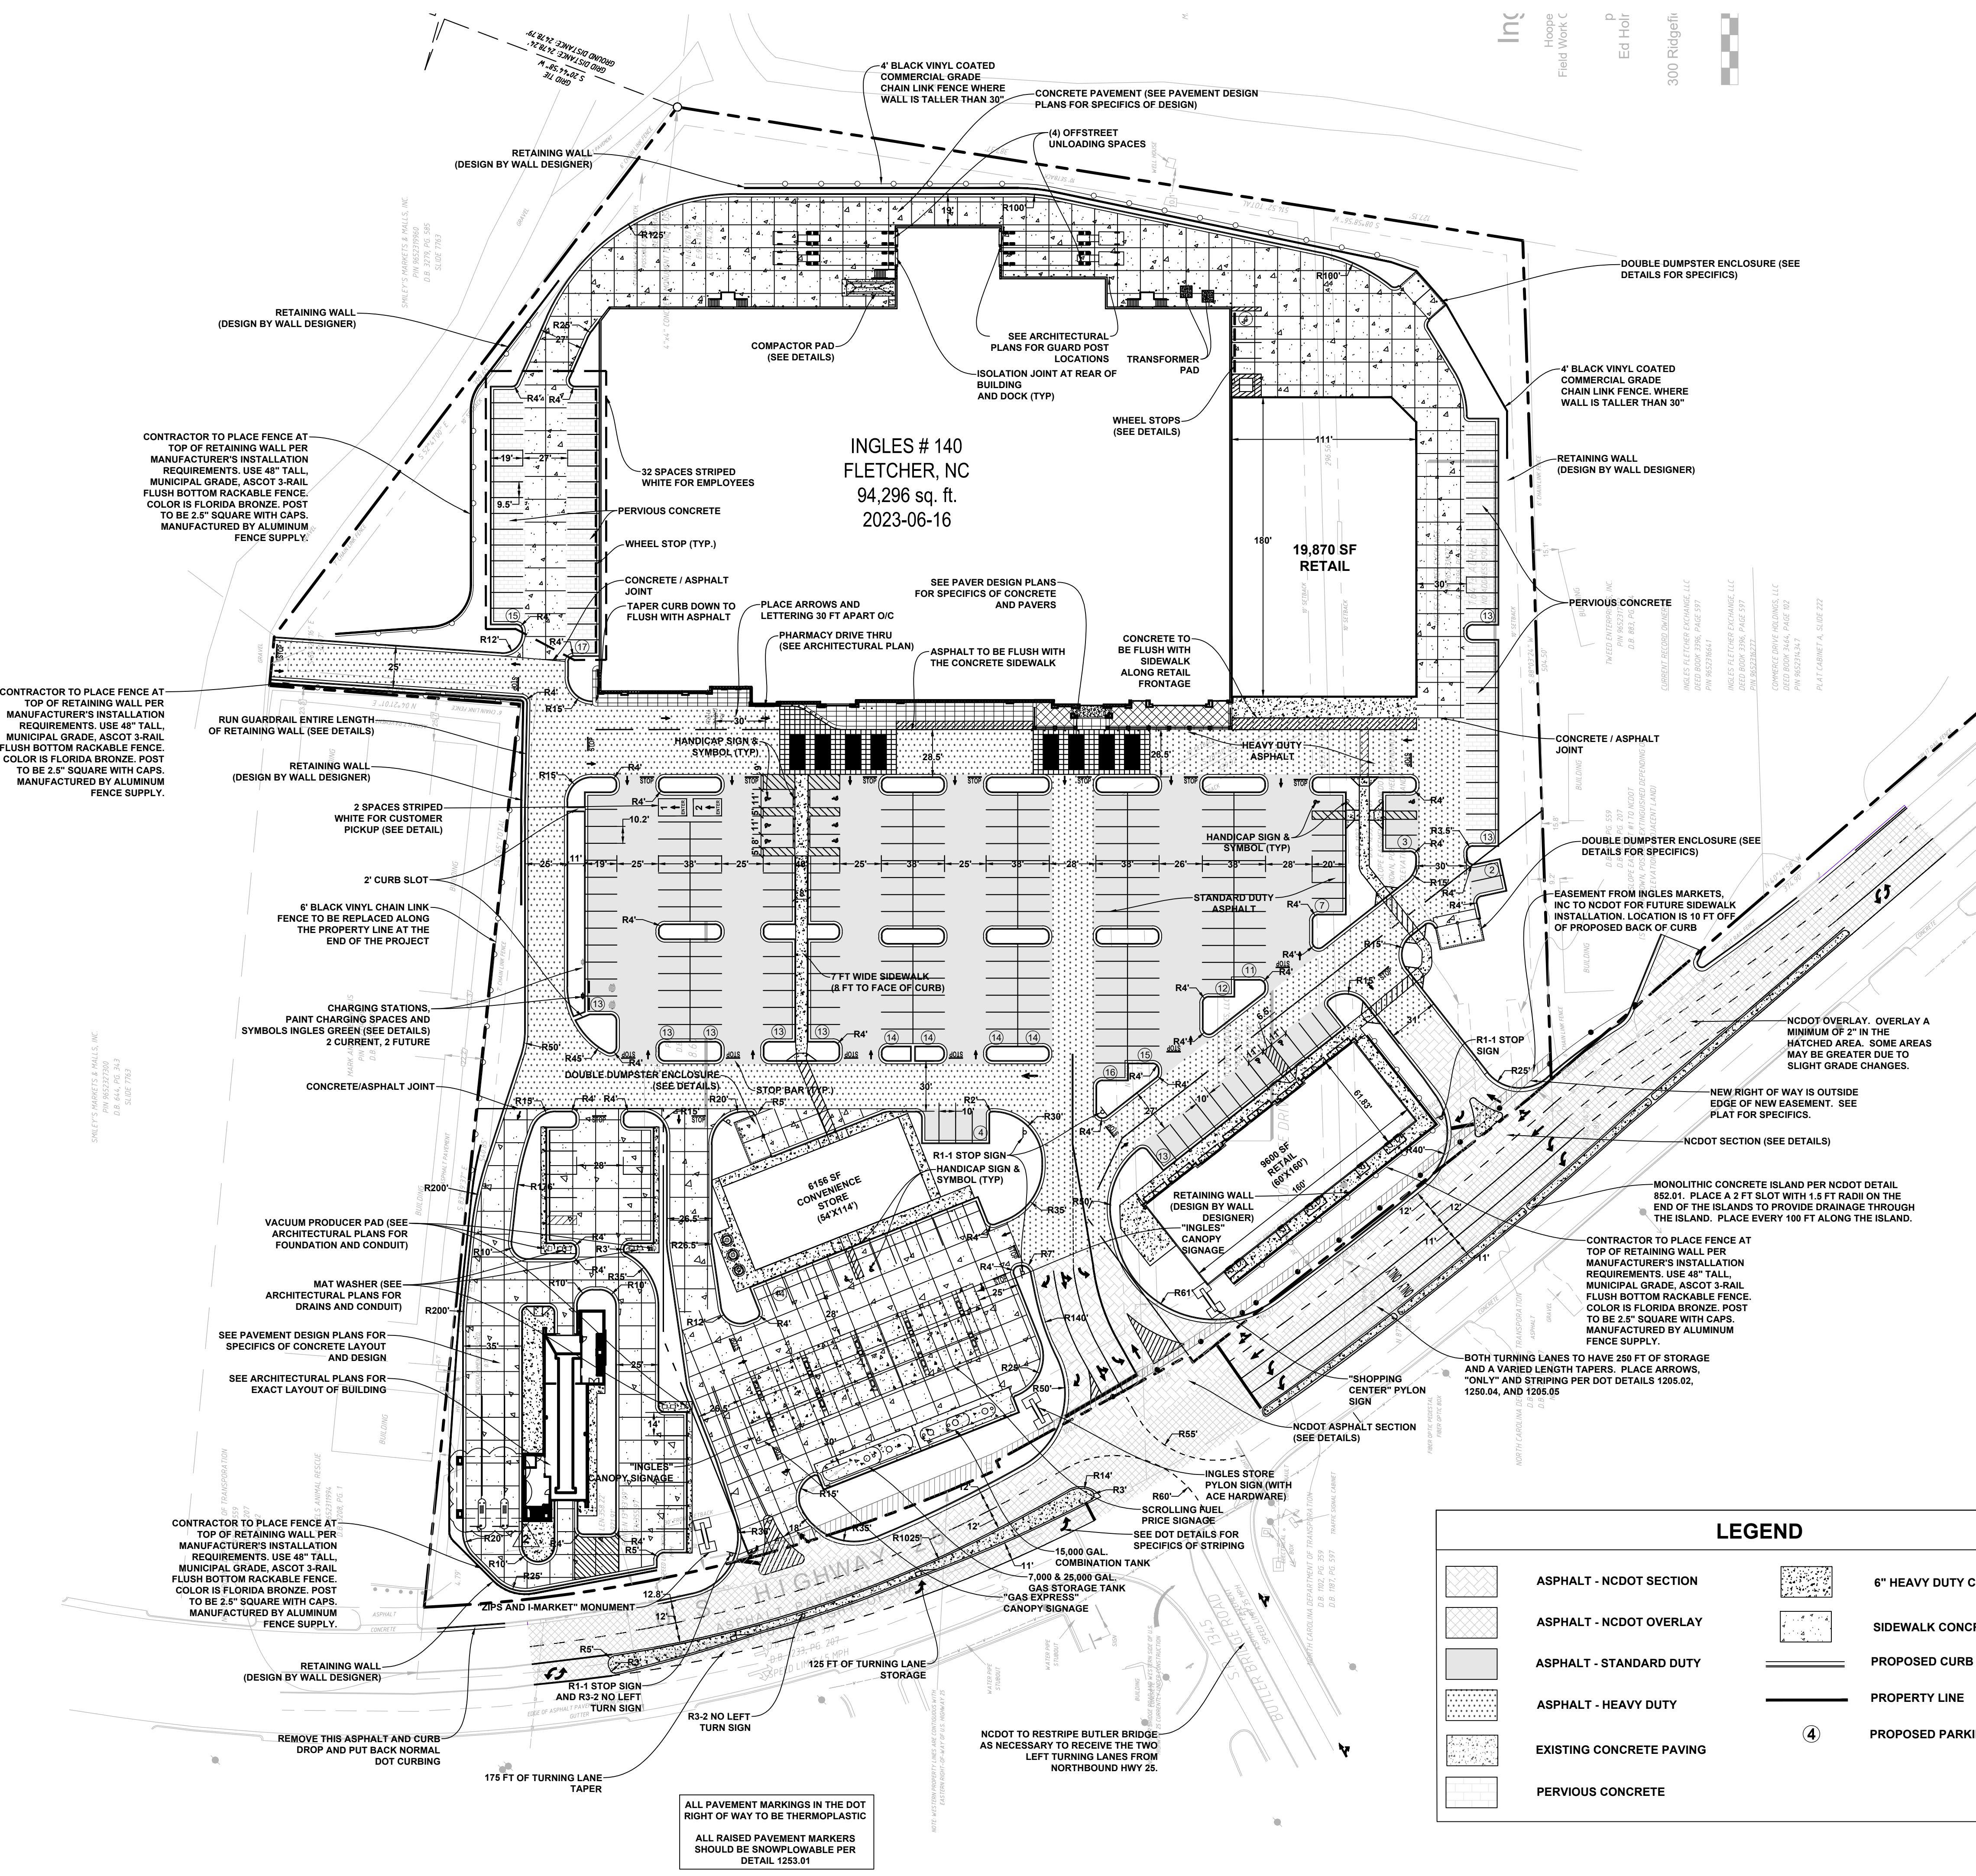

REVISIONS:

NO.	DATE	DESCRIPTION	BY
1	8/26/22	REVISED WATER LAYOUT AND ADDED RESTAURANT GREASE TRAP	SCW
2	9/1/22	REVISED ZIPS PAY BOOTHS	SCW
3	6/28/23	MAJOR REVISION	PCB

SEAL:

6/28/23

CORPORATE SEAL:



DBA
LAND PLANNING ASSOCIATES OF NC, INC.
110 WEST 1ST AVENUE - SUITE A
EASLEY, SC 29640
864.242.6072
design@pa-inc.net

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Markets Incorporated
STORE #140
5620 HENDERSONVILLE ROAD
FLETCHER NC

PROPERTY INFORMATION:
TAX MAP NUMBER: 9652316641, 9652316277
REFERENCE D.B. & PG: DB 3396 PG 597

ADDITIONAL INFO:
9652314347
DB 3464 PG 102




ISSUE FOR CONSTRUCTION:
PERMIT DATE:
BID DATE:

DRAWN BY: PCB
DESIGN BY: JDC
CHECKED BY: PMR
DATE: 4/19/22
SCALE: HORIZ. 1' = 50' VERT.
JOB NUMBER: 21.018

GRADING AND STORMWATER PLAN

C-105

STORE #140
HENDERSONVILLE ROAD
FLETCHER NC

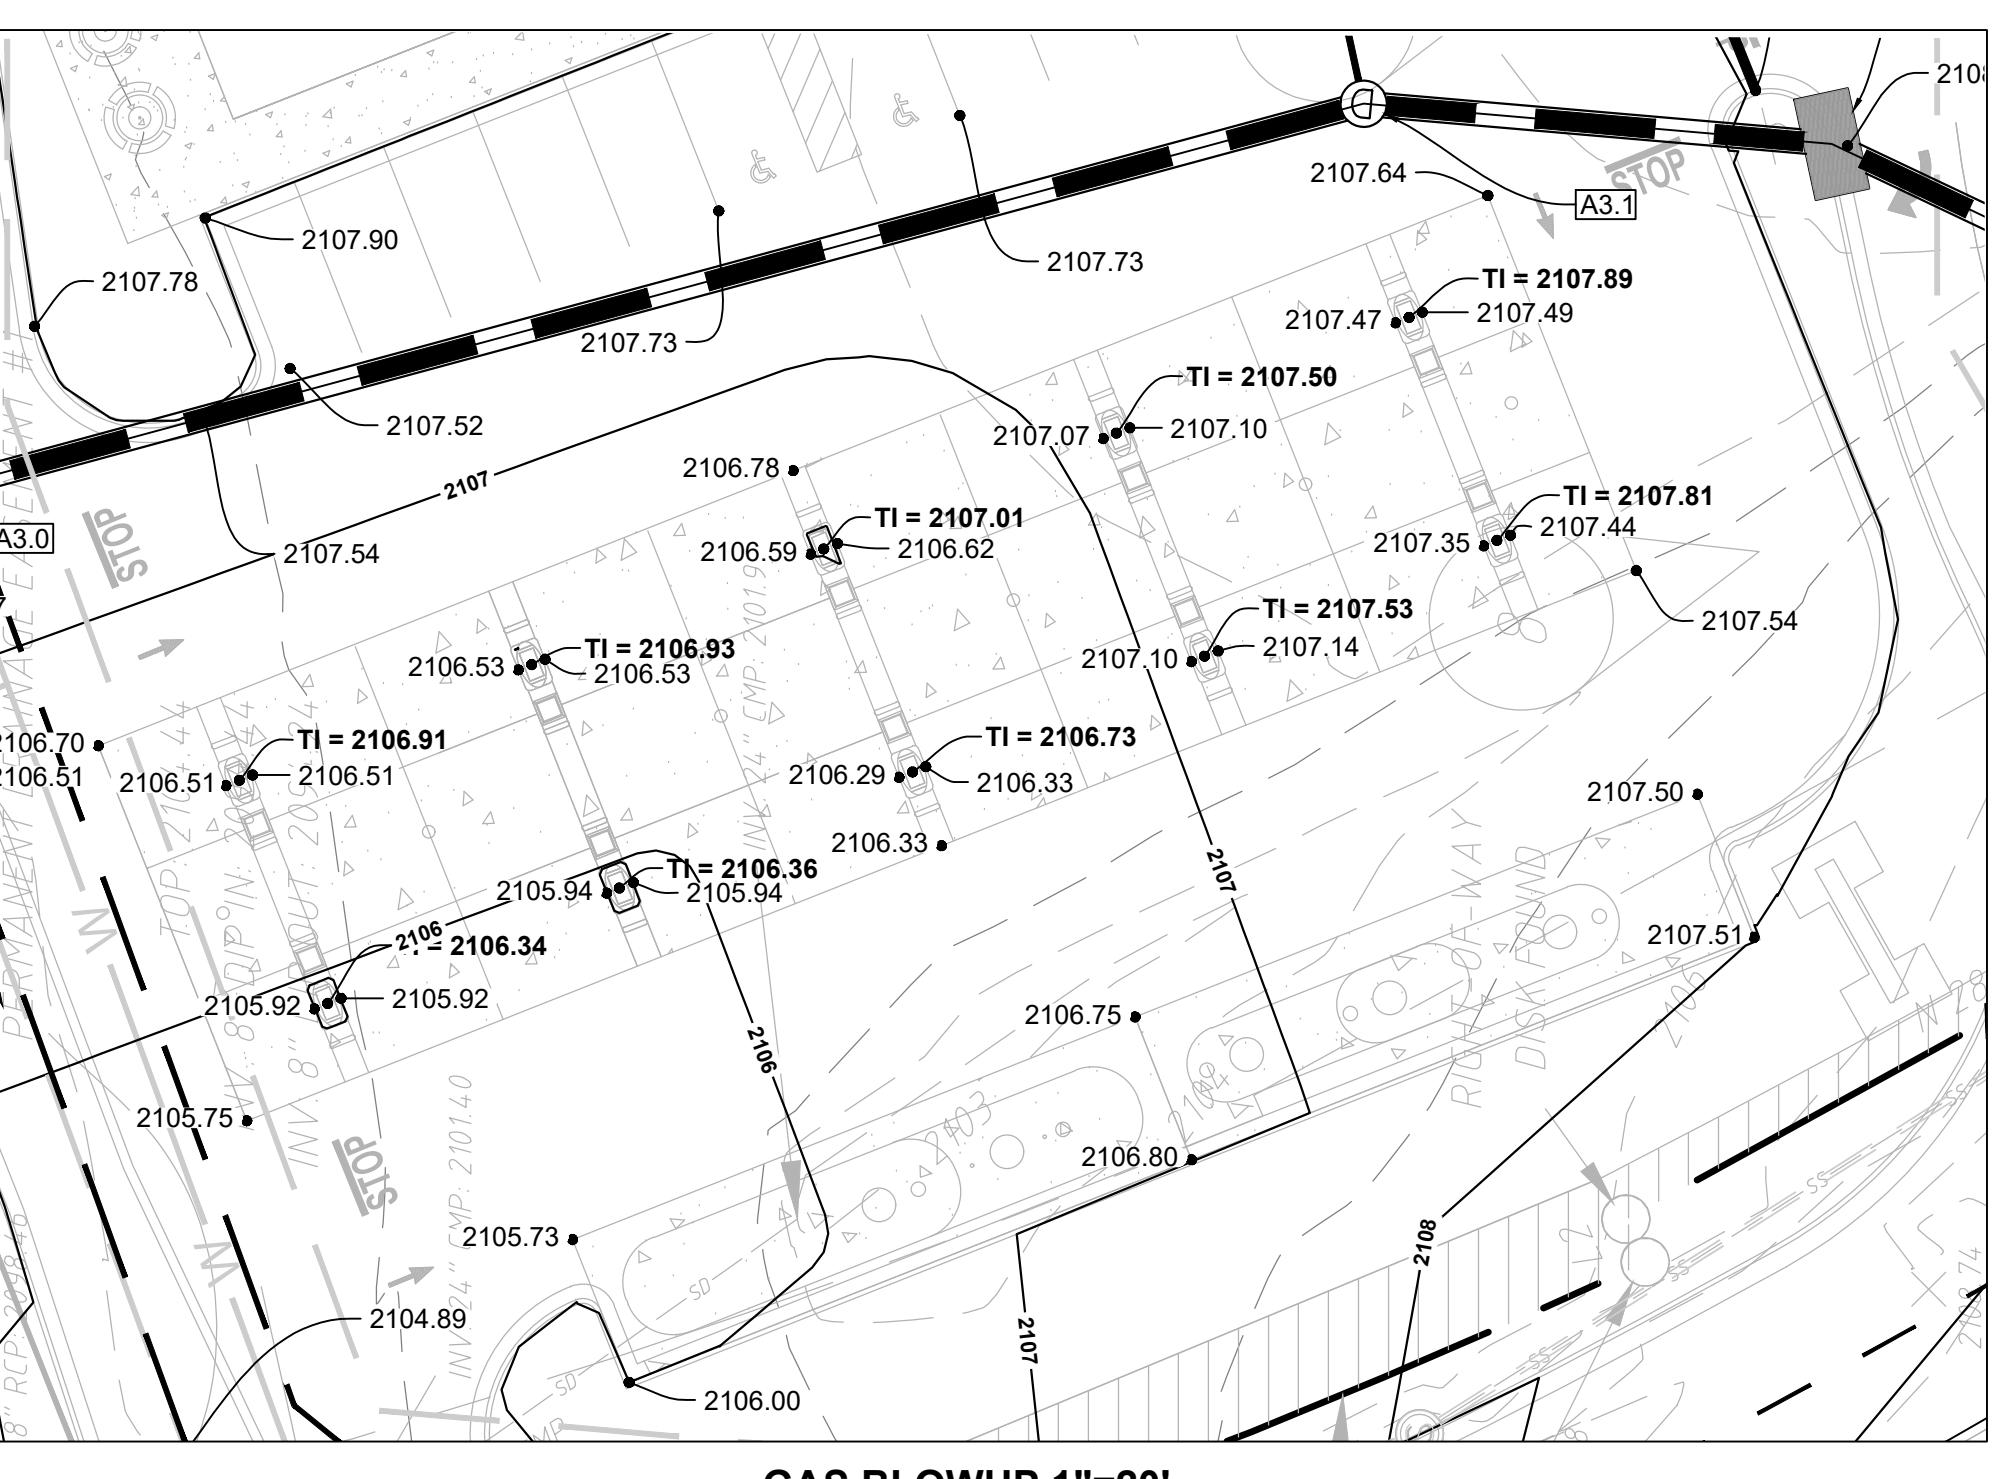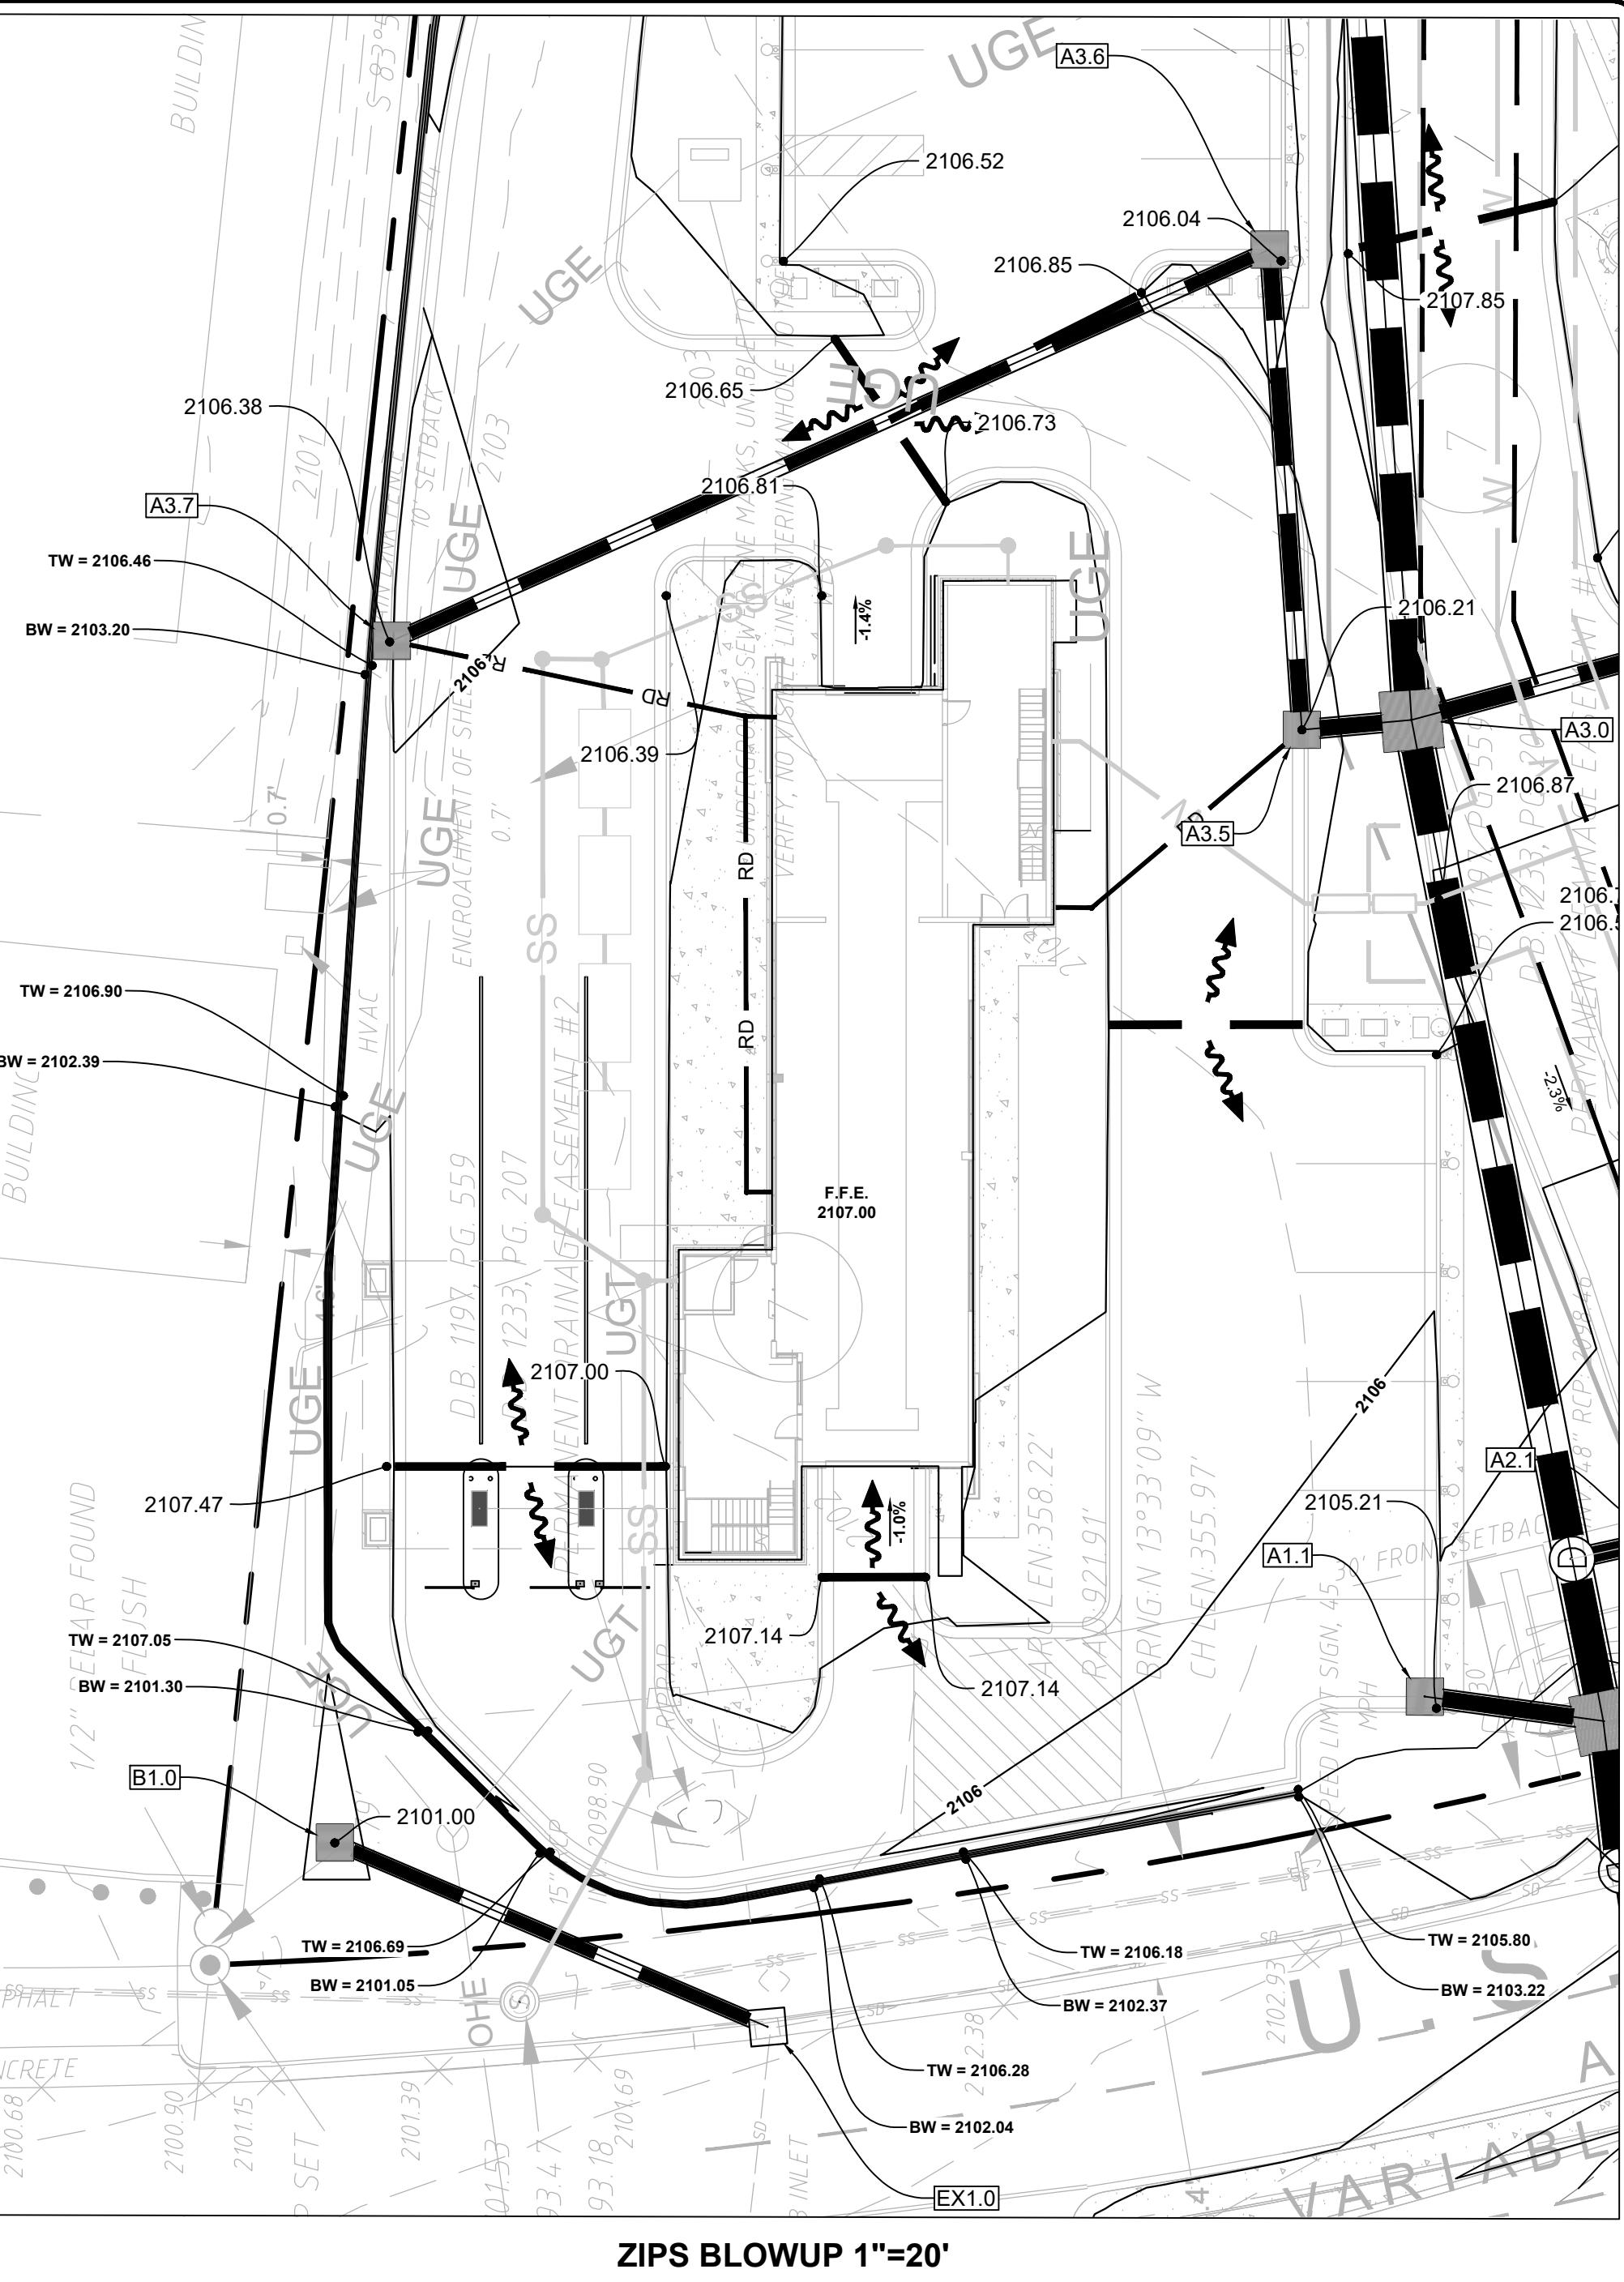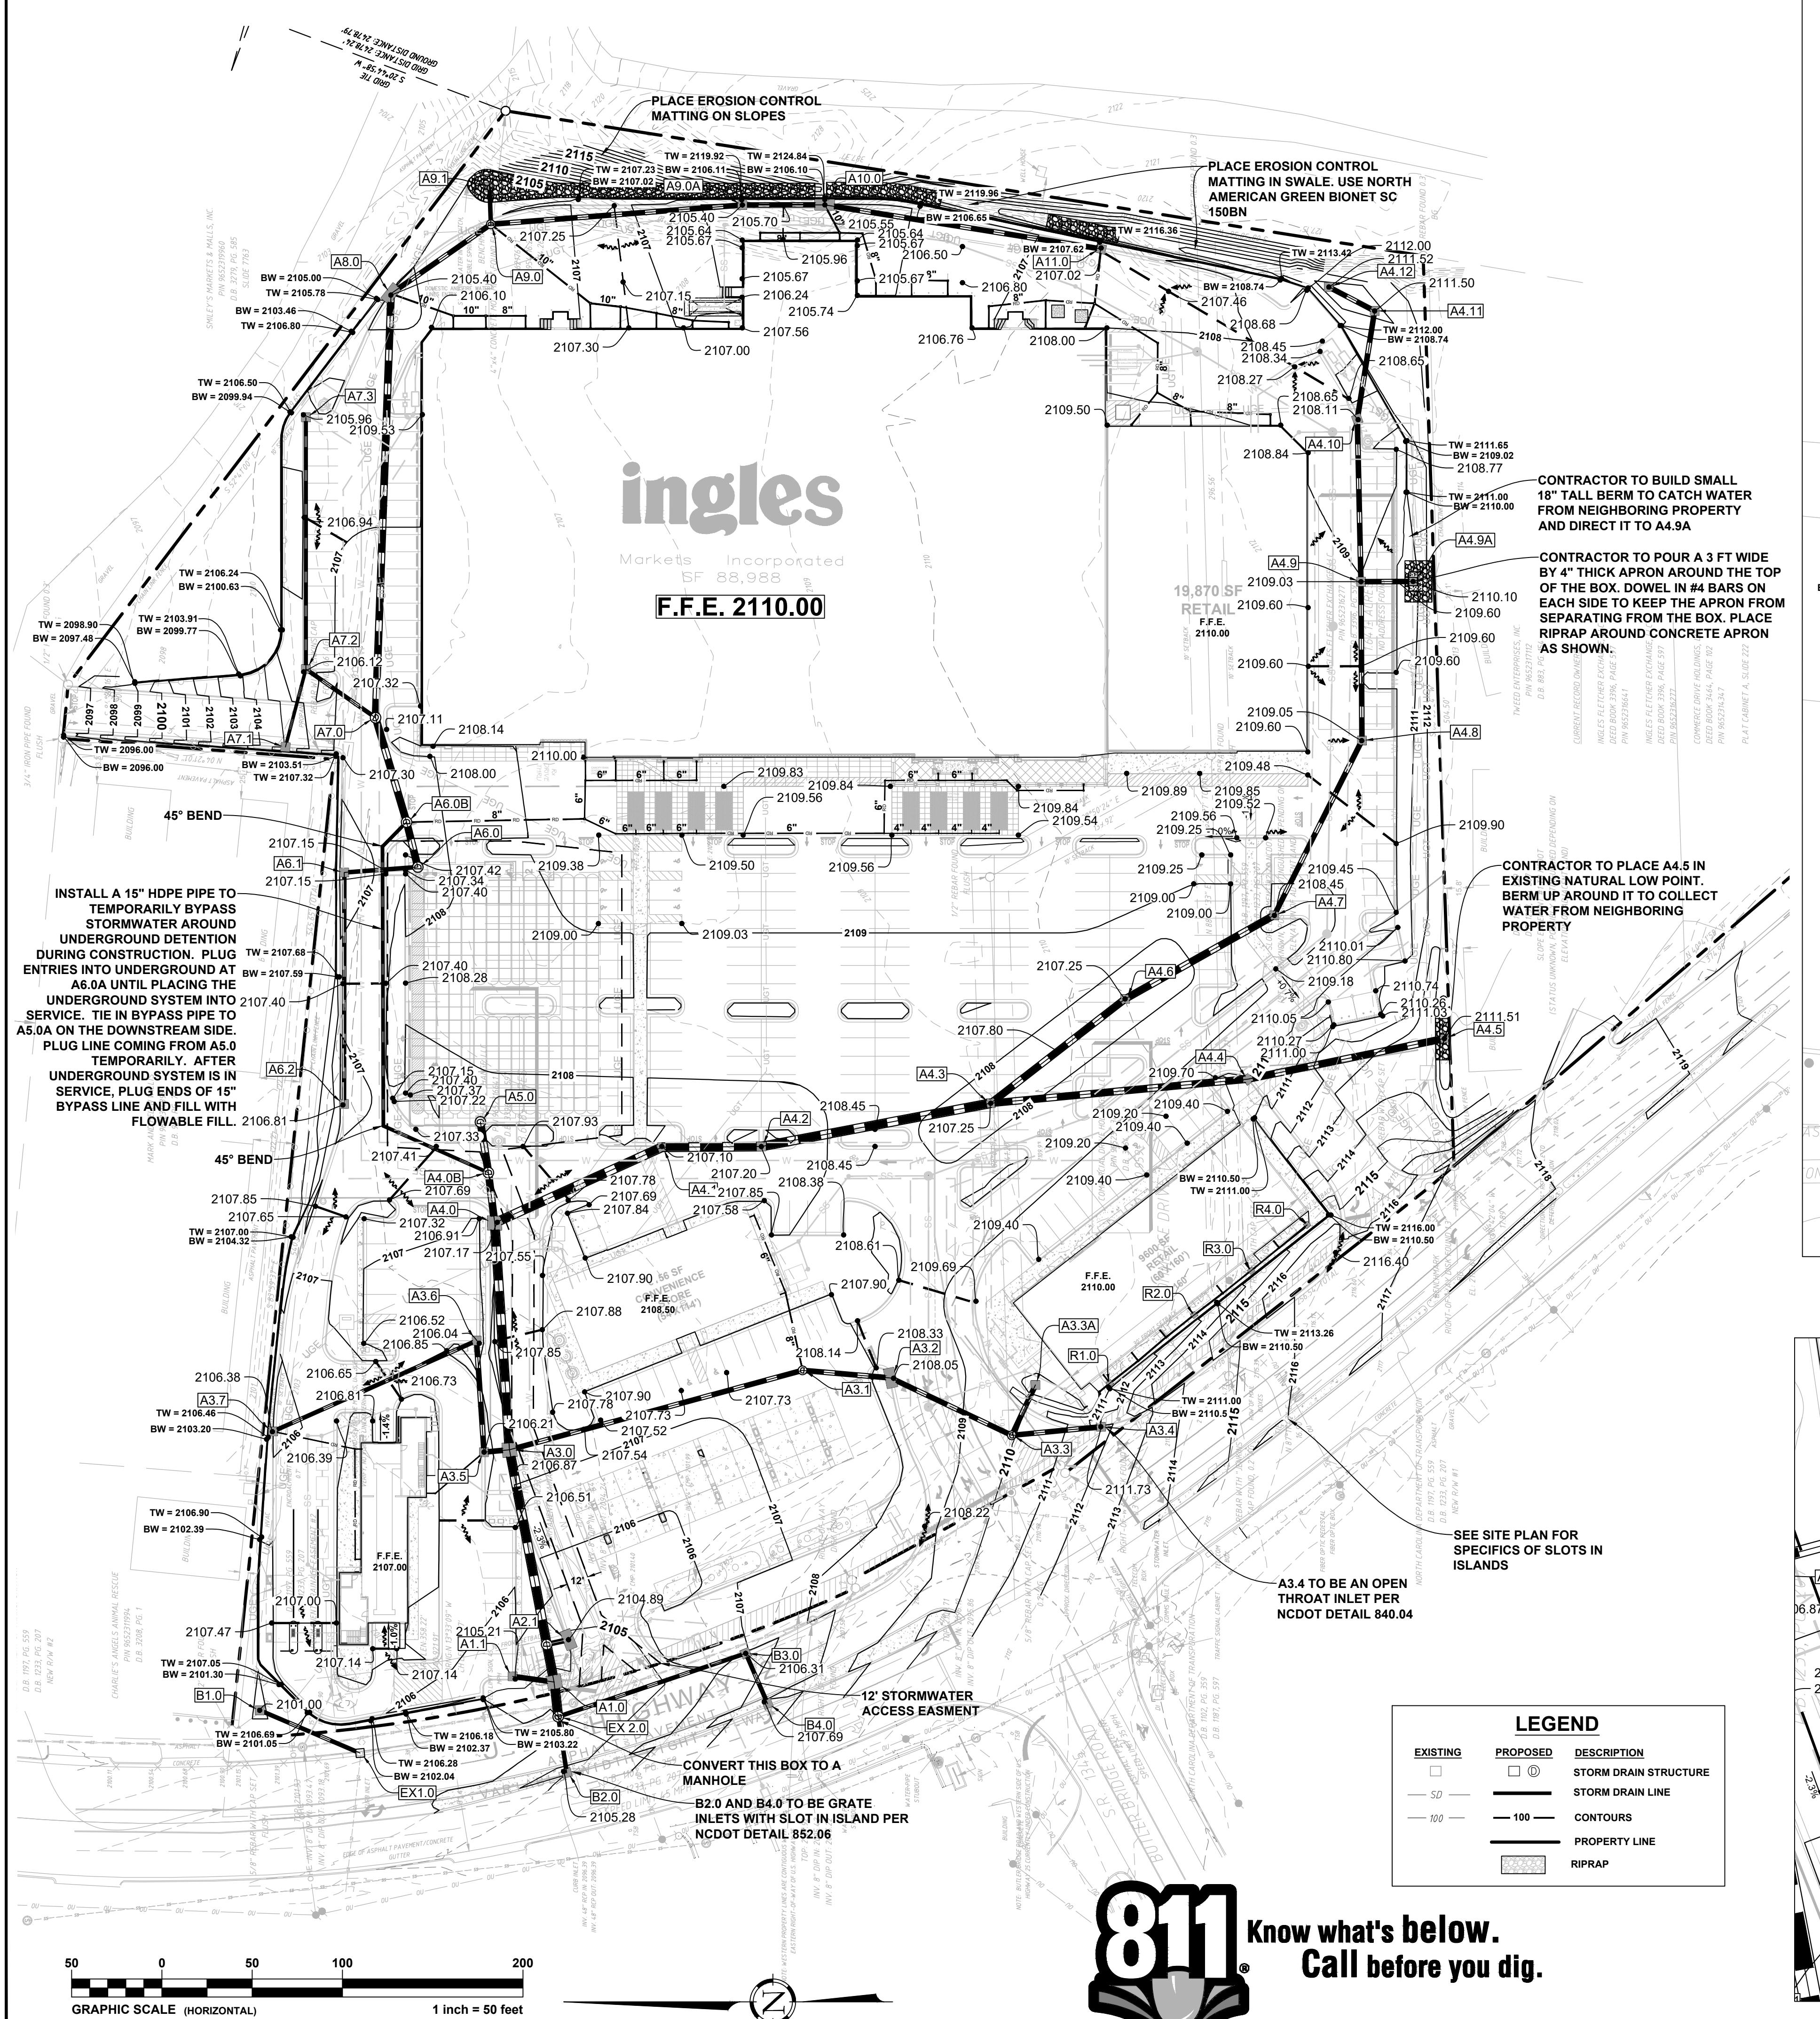

REVISIONS:

NO.	DATE	DESCRIPTION	BY
1	8/26/22	REVISED WATER LAYOUT AND ADDED RESTAURANT GREASE TRAP	SCW
2	9/1/22	REVISED ZIPS PAY BOOTHS	SCW
3	6/28/23	MAJOR REVISION	PCB

SITE UTILITY NOTES:

- ANCHOR COLLARS SHALL BE PROVIDED ON STORM AND SANITARY SEWER LINES WHOSE SLOPE EXCEED 25%.
- WATER METER AND WATER TAP SHALL BE RAISED AS NECESSARY TO BE FLUSH WITH NEW FINISH GRADES.
- TOPS OF EXISTING MANHOLES SHALL BE RAISED AS NECESSARY TO BE FLUSH WITH NEW FINISH GRADES.
- CONTRACTOR IS TO COORDINATE INSTALLATION OF GAS LINES WITH LOCAL GAS COMPANY. CONTRACTOR SHALL COORDINATE THE TYING IN OF INDIVIDUAL GAS METERS TO THE MAIN. CONTRACTOR IN CONJUNCTION WITH THE GAS COMPANY SHALL DETERMINE THE AMOUNT OF GAS LINE HE/SHE IS TO PROVIDE OUTSIDE THE GAS COMPANY'S ALLOWANCE.
- REFER TO INTERIOR PLUMBING DRAWINGS FOR TIE-IN OF ALL UTILITIES.
- EXISTING UTILITIES SHALL BE VERIFIED IN FIELD PRIOR TO INSTALLATION OF ANY NEW PIPE LINES. DRAWINGS DO NOT PURPORT TO SHOW ALL EXISTING UTILITIES.
- THRUST BLOCKS SHALL BE LOCATED AT ALL WATER PIPE VALVES, VERTICAL BENDS, AND VERTICAL ELBOWS AND TEES. HYDRANTS SHALL BE SIZED AND INSTALLED IN ACCORDANCE WITH NFPA BULLETIN NO. 24, SECTION 96, PARAGRAPHS 9605, 9606 AND SECTION 9605.
- SANITARY SEWER LINE SHALL BE OF DUCTILE IRON PIPE AT ALL LOCATIONS WHERE SANITARY LINE CROSSES ABOVE OR BELOW A STORM SEWER LINE.
- WHERE WATER PIPING CROSSES THE SANITARY SEWER LINE, THE WATER SERVICE WITHIN TEN FEET OF THE POINT OF CROSSING SHALL BE AT LEAST 12 INCHES ABOVE THE TOP OF THE SEWER LINE. THE SEWER LINE SHALL BE OF DUCTILE IRON WITH MECHANICAL JOINTS AT LEAST 10 FEET ON BOTH SIDES OF THE CROSSING.
- LINES UNDERGROUND SHALL BE INSTALLED, TESTED AND APPROVED BEFORE BACKFILLING.
- EXISTING DRAINAGE STRUCTURES TO BE INSPECTED AND REPAIRED AS NEEDED AND EXISTING PIPES TO BE CLEANED OUT TO REMOVE ALL SILT AND DEBRIS.
- CONTRACTOR SHALL BE RESPONSIBLE FOR ANY NECESSARY RELOCATION OF EXISTING PIPES TO BE CLEANED OUT TO REMOVE ALL SILT AND DEBRIS.
- CONTRACTOR SHALL BE RESPONSIBLE FOR ANY NECESSARY RELOCATION OF EXISTING UTILITIES SUCH AS POWER AND TELEPHONE POLES AND THE COORDINATION OF SUCH WITH THE PROPER UTILITY OWNER.
- ALL UTILITIES TO MEET 2018 NC PLUMBING CODE.

SEAL:

6/28/23

CORPORATE SEAL:



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design@pa-inc.net

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Markets Incorporated
STORE #140
5620 HENDERSONVILLE ROAD
FLETCHER NC

PROPERTY INFORMATION:

TAX MAP NUMBER: 9652316641, 9652316277
REFERENCE D.B. & PG: DB 3396 PG 597

ADDITIONAL INFO:
9652314347
DB 3464 PG 102

ISSUE FOR CONSTRUCTION:


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BID DATE:
DRAWN BY: PCB
DESIGN BY: JDC
CHECKED BY: PMR
DATE: 4/19/22
SCALE: HORIZ. 1' = 50' VERT.
JOB NUMBER: 21.018

UTILITY PLAN

C-106STORE #140
HENDERSONVILLE ROAD
FLETCHER NC

LEGEND		DESCRIPTION
EXISTING	PROPOSED	
— W —	— W —	WATER LINE
— SS —	— SS —	SANITARY SEWER LINE
○	●	SANITARY SEWER MANHOLE
— OE —	— OHE —	STORM DRAIN LINE
— T —	— OHT —	OVERHEAD ELECTRIC LINE
— UGT —	— UGE —	OVERHEAD TELEPHONE LINE
— UGE —	— UGE —	UNDERGROUND TELEPHONE
— P —	— P —	POWER POLE
— H —	— H —	FIRE HYDRANT

50 0 50 100 200
GRAPHIC SCALE (HORIZONTAL)
1 inch = 50 feet

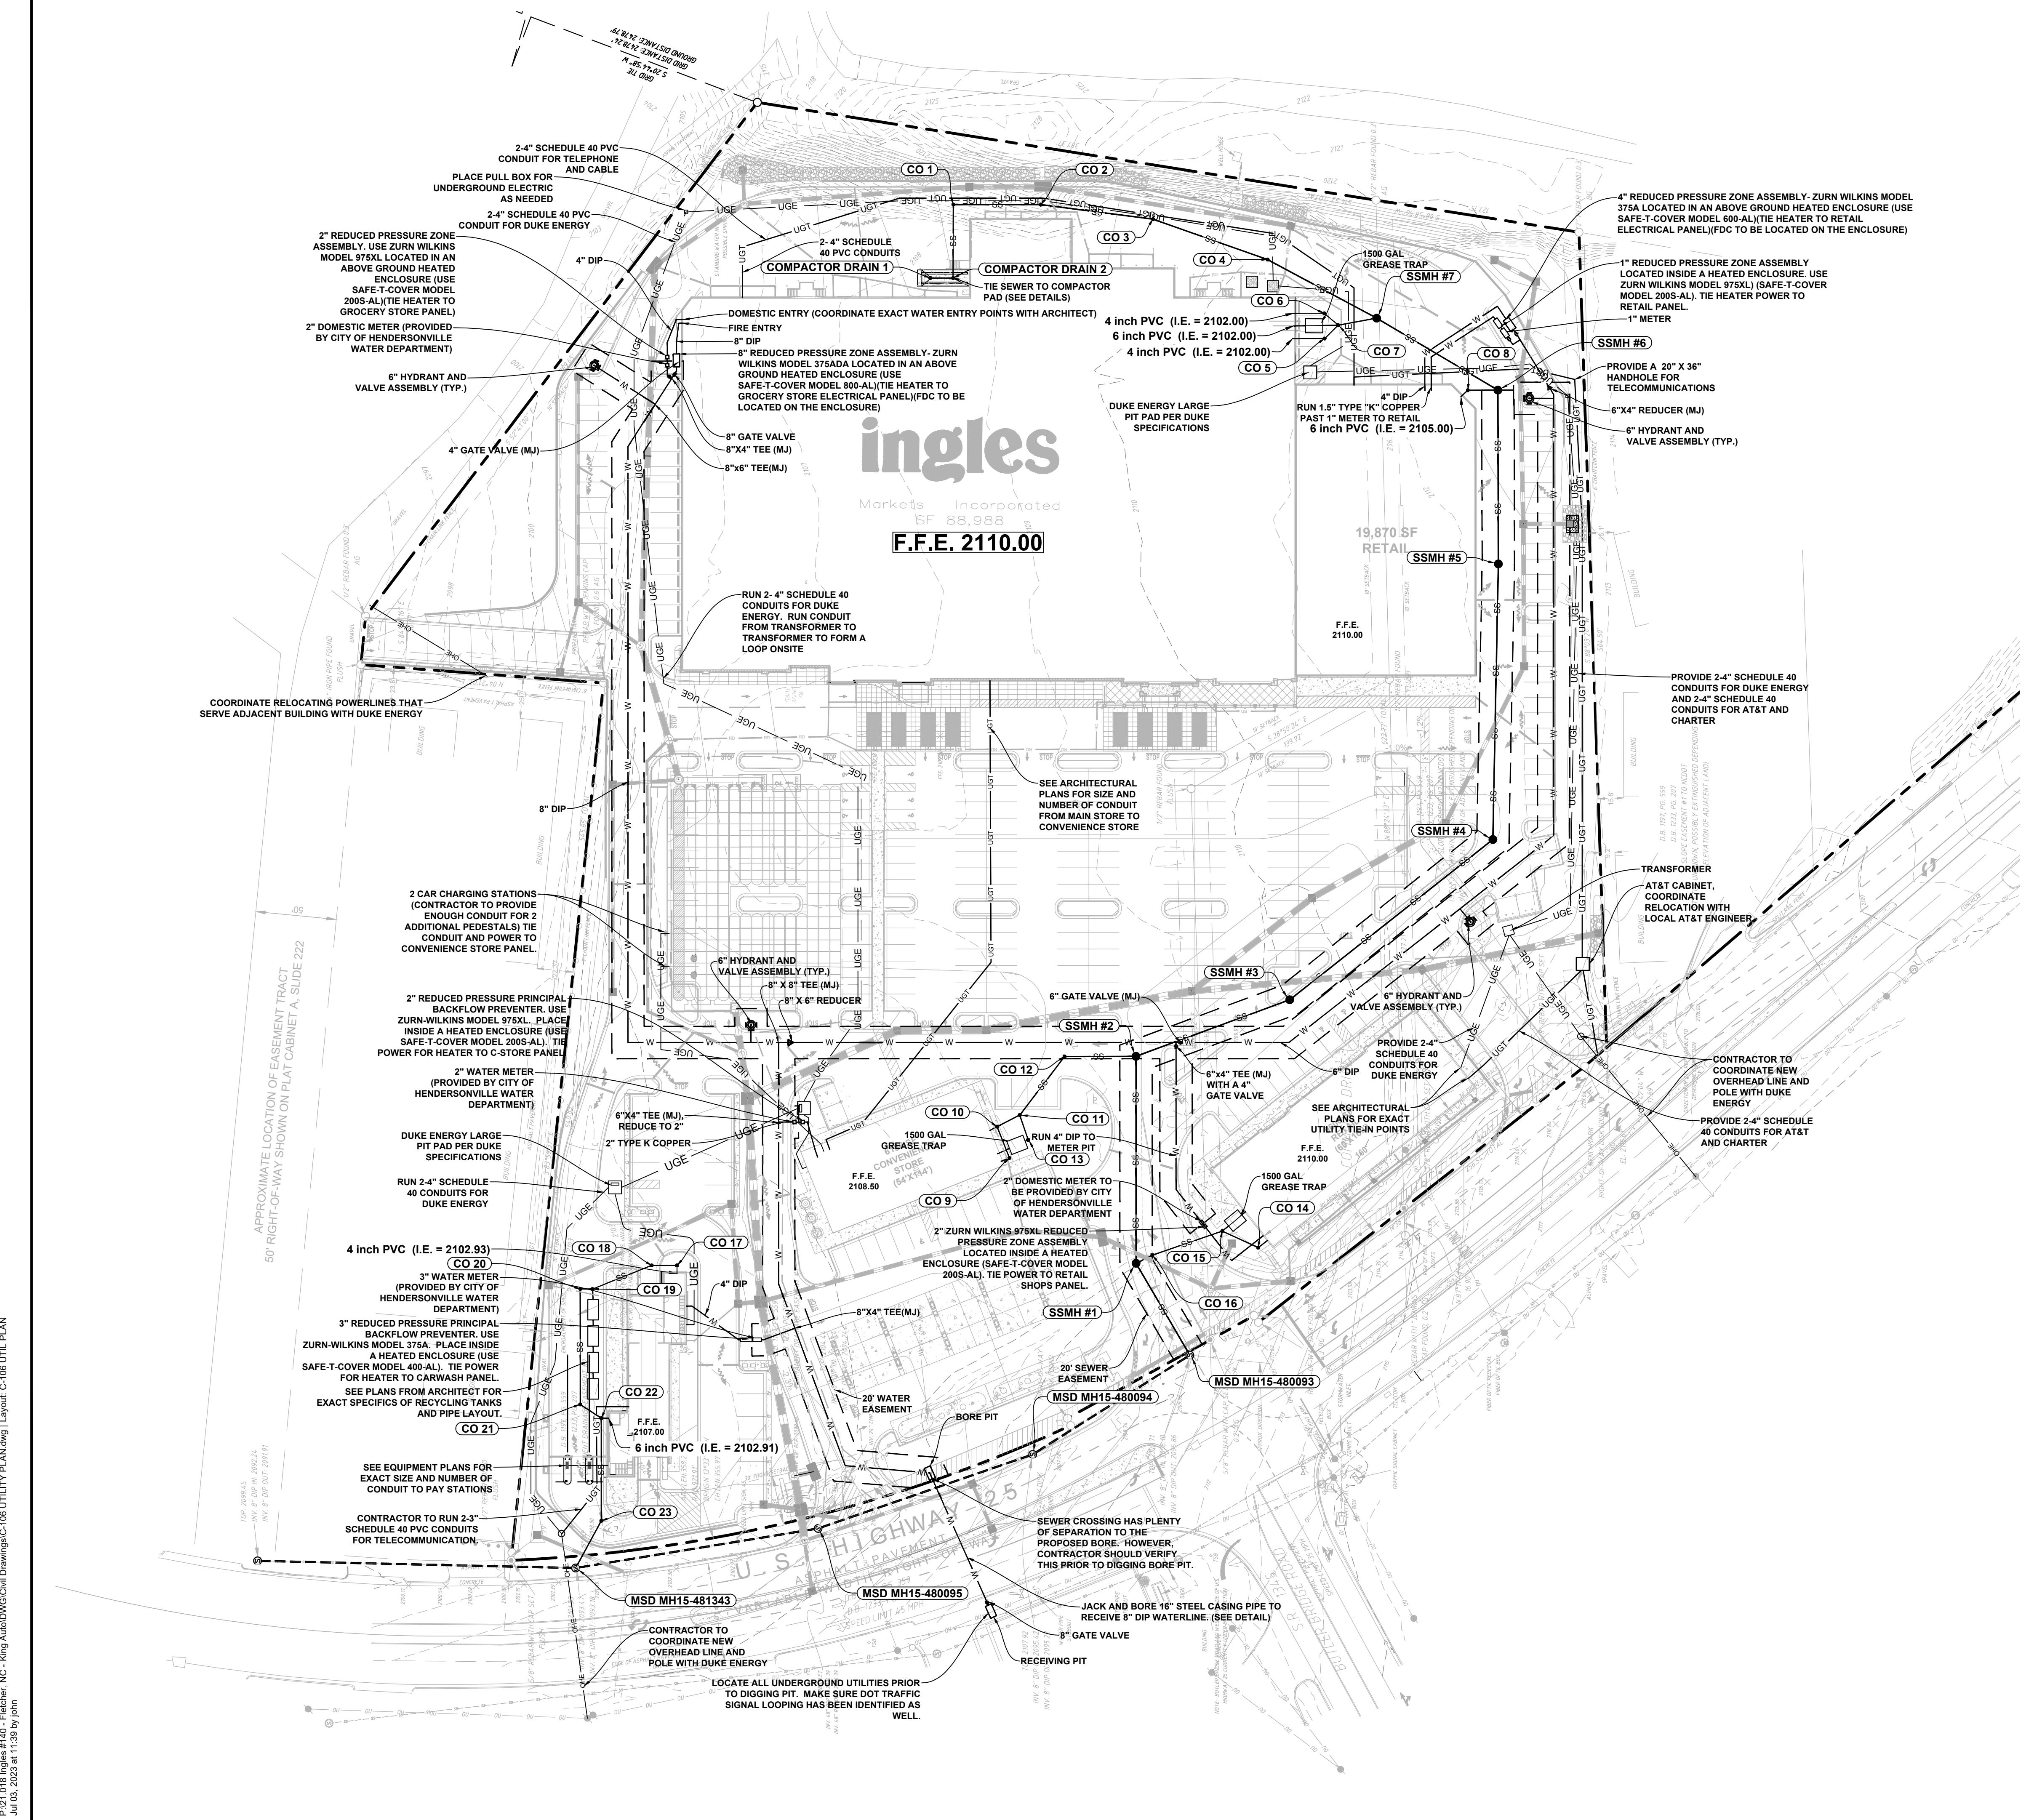

VISIONS:



6/28/23

PORATE SEAL:



**DBA
LAND PLANNING ASSOCIATES OF NC, INC.
110 WEST 1ST AVENUE - SUITE A
EASLEY, SC 29640
864.242.6072
design@lpa-inc.net**



Markets Incorporated
STORE #140
20 HENDERSONVILLE ROAD
FLETCHER NC

PROPERTY INFORMATION:

MAP NUMBER: 9652316641, 9652316277
REFERENCE D.R. & PC: DR 3306 PC 507

MAIL-INFO

9652314347
DB 3464 PG 102

THE CHALLENGE FOR CONSTRUCTION:

MIT DATE:

BY: PC

IGN BY: **JDC**

CKED BY: **PMR**

4/19/2

LE: HORIZ. 1' = 50' VERT.

OVERLAY PLAN

C-107

**STORE #140
HENDERSONVILLE ROAD
FLETCHER NC**



**Now what's below.
Call before you dig.**



P:\21.018 Ingles #140 - Fletcher, NC - King Auto\DWG\Civil Drawings\C-107 OVERLAY PLAN.dwg | Layout: C-107 OVERLAY PLAN
Jul 03, 2023 at 11:41 by john

REVISIONS:

NO.	DATE	DESCRIPTION	BY
1	8/26/22	REVISED WATER LAYOUT AND ADDED RESTAURANT GREASE TRAP	SCW
2	6/28/23	MAJOR REVISION	PCB

SEAL:

 6/28/23

CORPORATE SEAL:




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 110 WEST 1ST AVENUE - SUITE A
 EASLEY, SC 29640
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ingles
 Markets Incorporated
STORE #140
 5620 HENDERSONVILLE ROAD
 FLETCHER NC

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 REFERENCE D.B. & PG: DB 3396 PG 597
ADDITIONAL INFO:
 9652314347
 DB 3464 PG 102

ISSUE FOR CONSTRUCTION:
PERMIT DATE:
BID DATE:
DRAWN BY: PCB
DESIGN BY: JDC
CHECKED BY: PMR
DATE: 4/19/22
SCALE: HORIZ. 1' = 50' VERT. 1' = 10'
JOB NUMBER: 21.018


STORMWATER PLAN AND PROFILE
C-108
 STORE #140
 HENDERSONVILLE ROAD
 FLETCHER NC

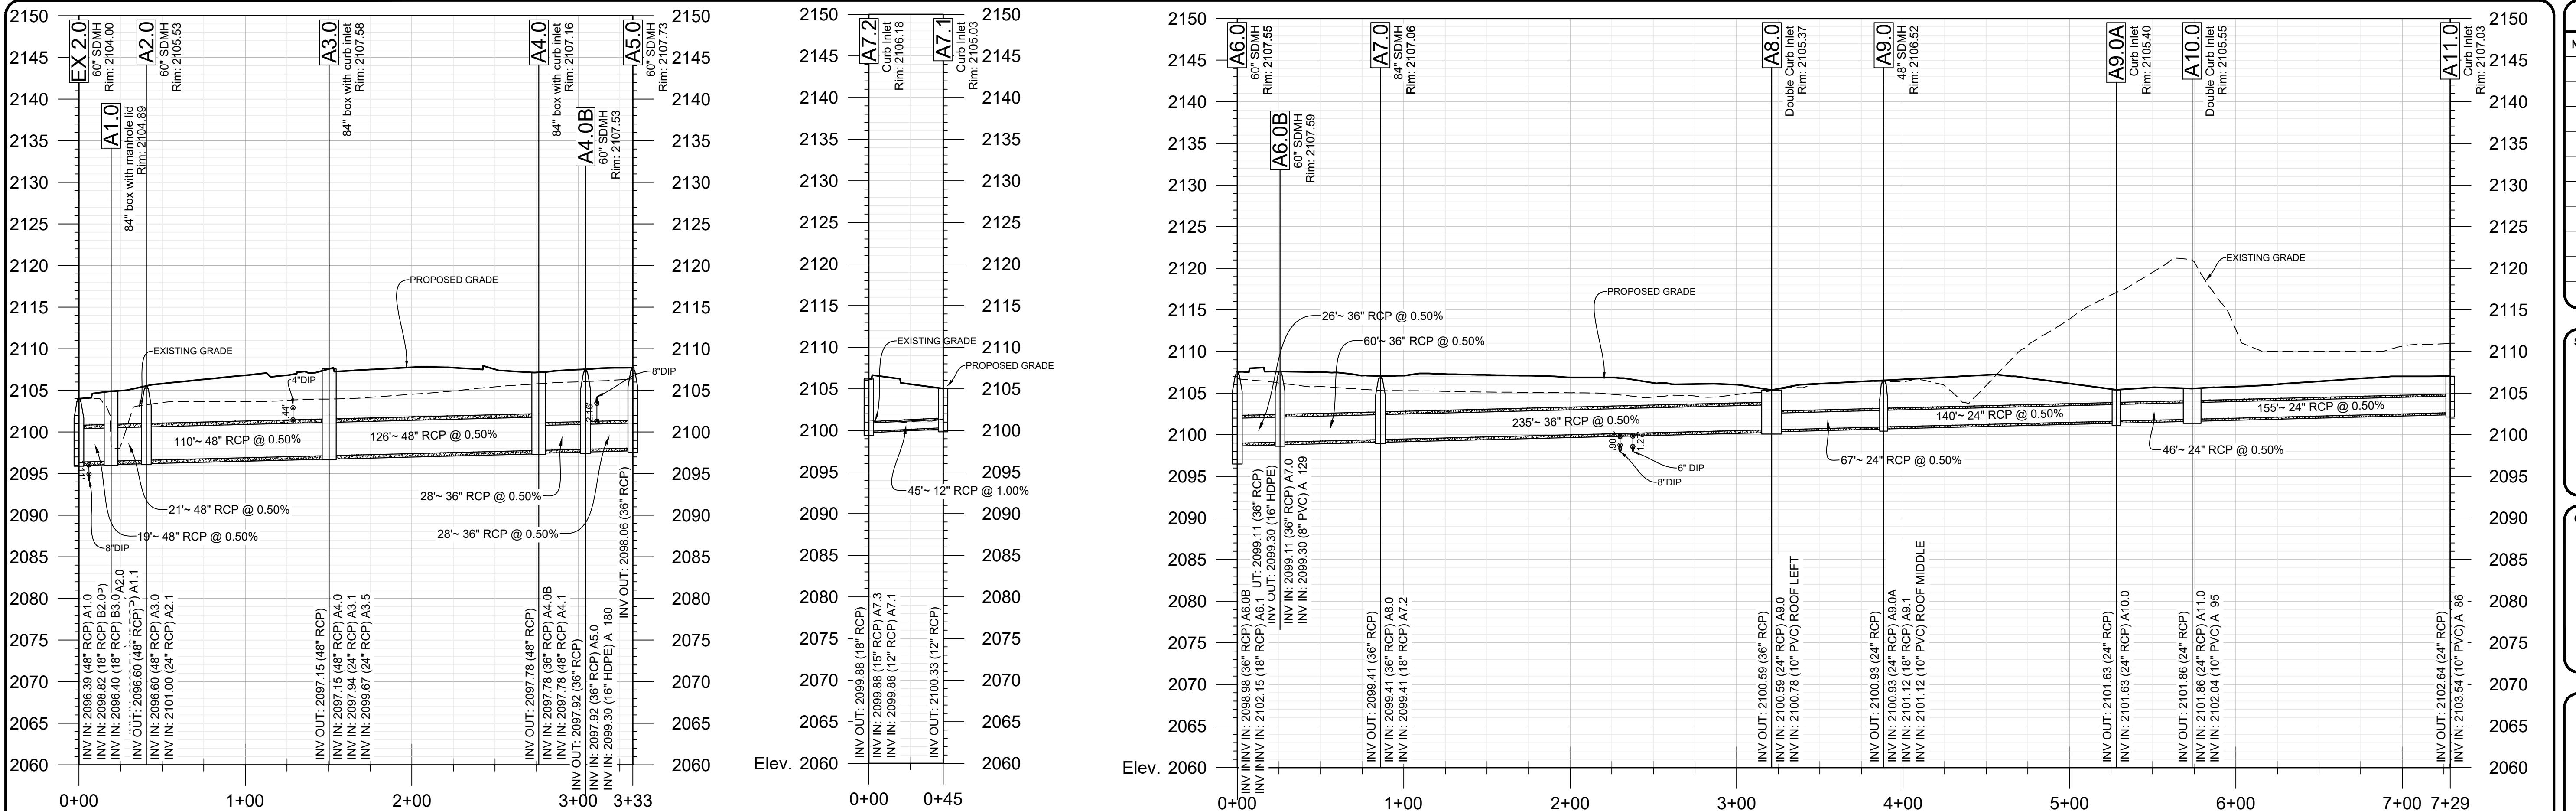

REVISIONS:

NO.	DATE	DESCRIPTION	BY
1	8/26/22	REVISED WATER LAYOUT AND ADDED RESTAURANT GREASE TRAP	SCW
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SEAL:

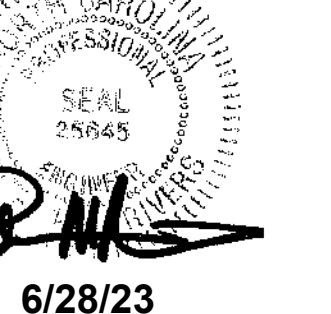

6/28/23

CORPORATE SEAL:



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STORE #140
5620 HENDERSONVILLE ROAD
FLETCHER NC

PROPERTY INFORMATION:

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DB 3464 PG 102

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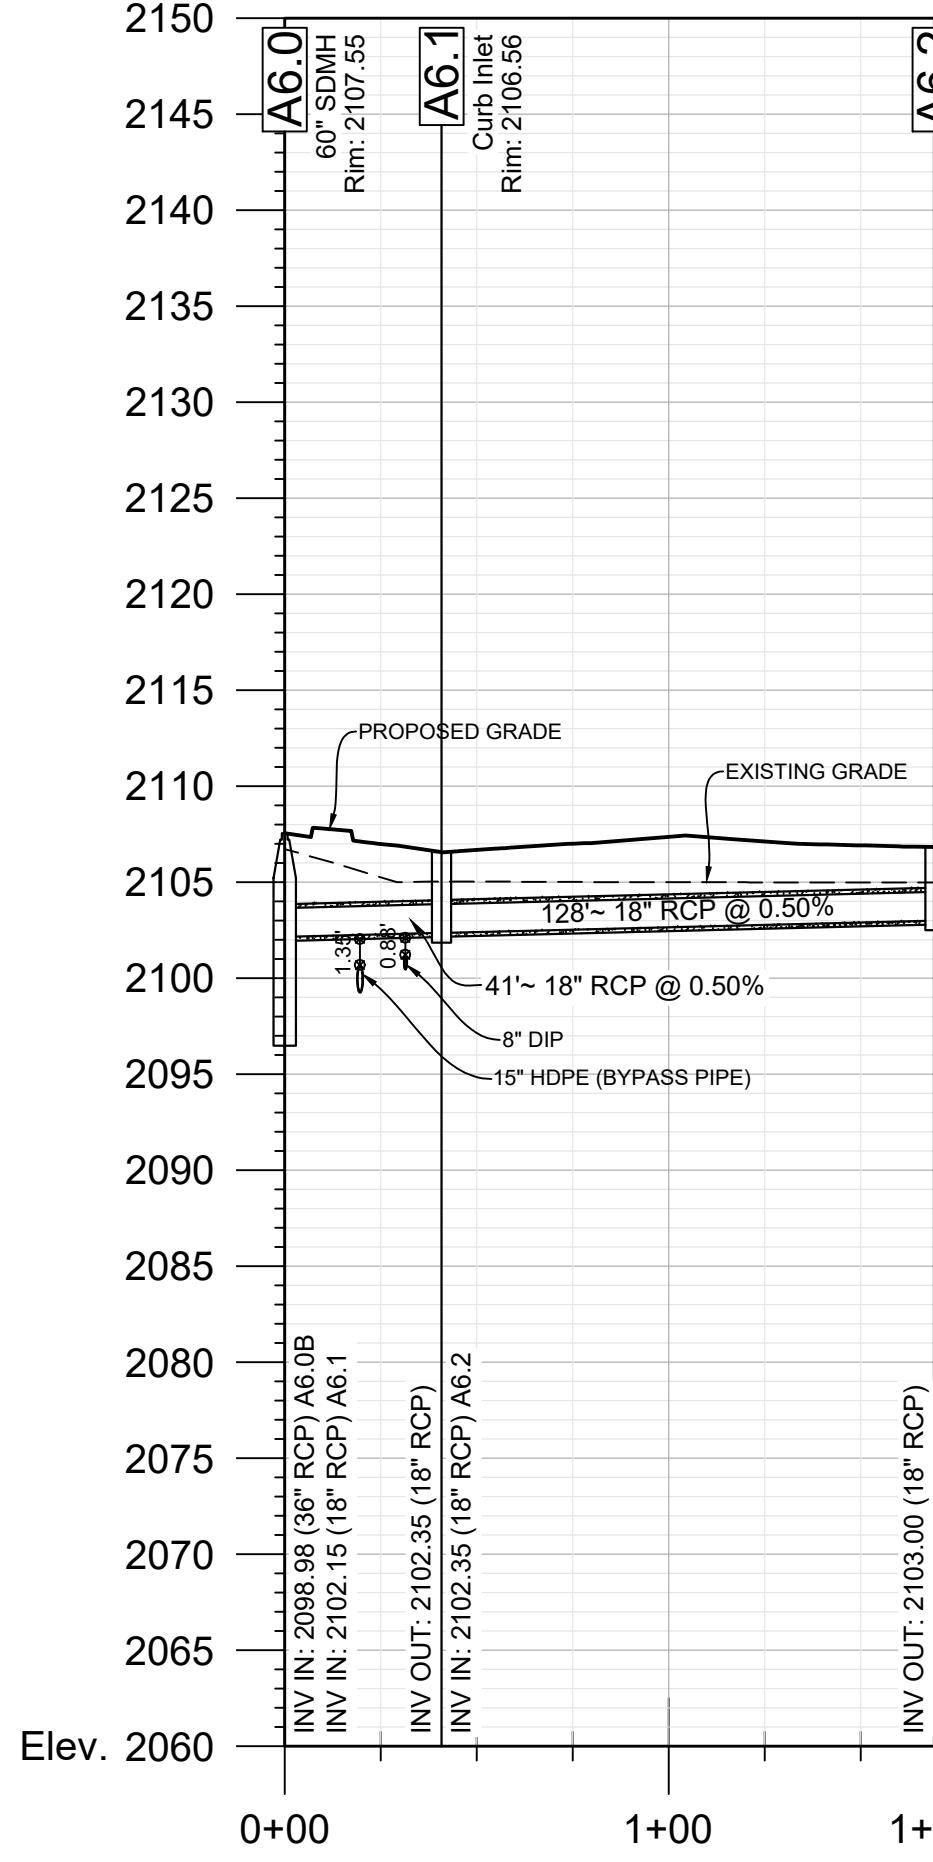
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JOB NUMBER: 21.018


STORMWATER PLAN AND PROFILE

C-109


STORE #140
HENDERSONVILLE ROAD
FLETCHER NC




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Station: 0+00.00 - 1+69.15
1" = 50' (H)
1" = 10' (V)

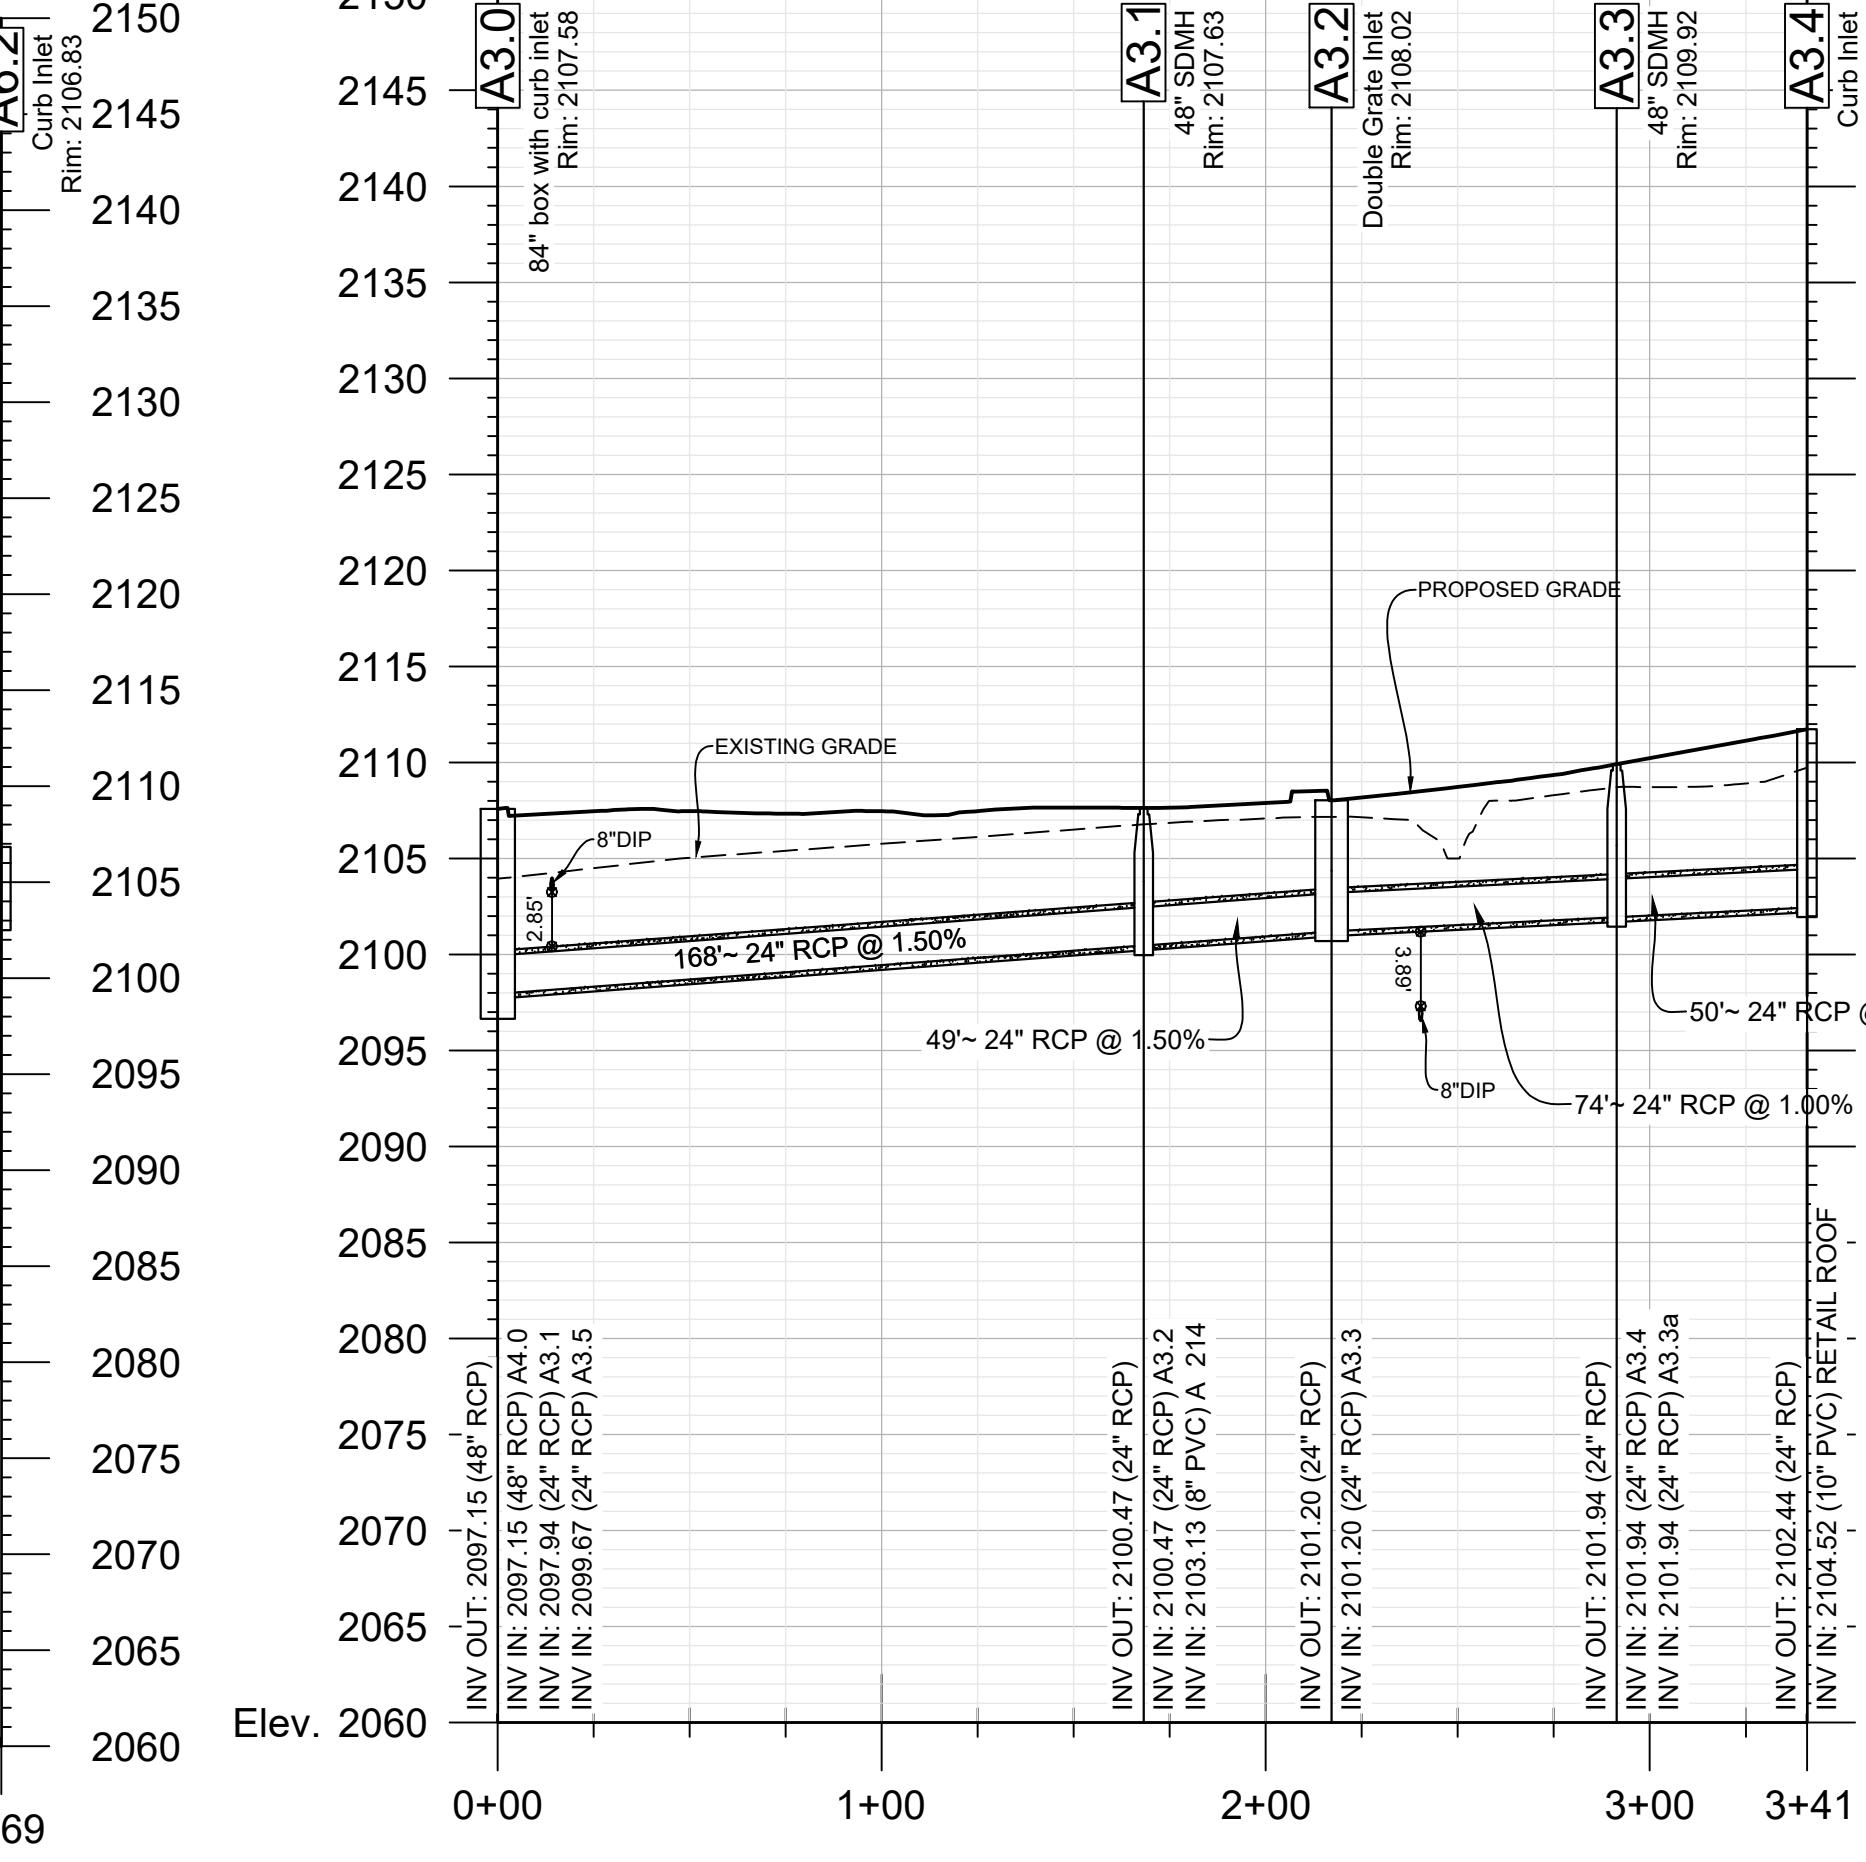


A3.0 - A3.3
Station: 0+00.00 - 3+40.92
1" = 50' (H)
1" = 10' (V)

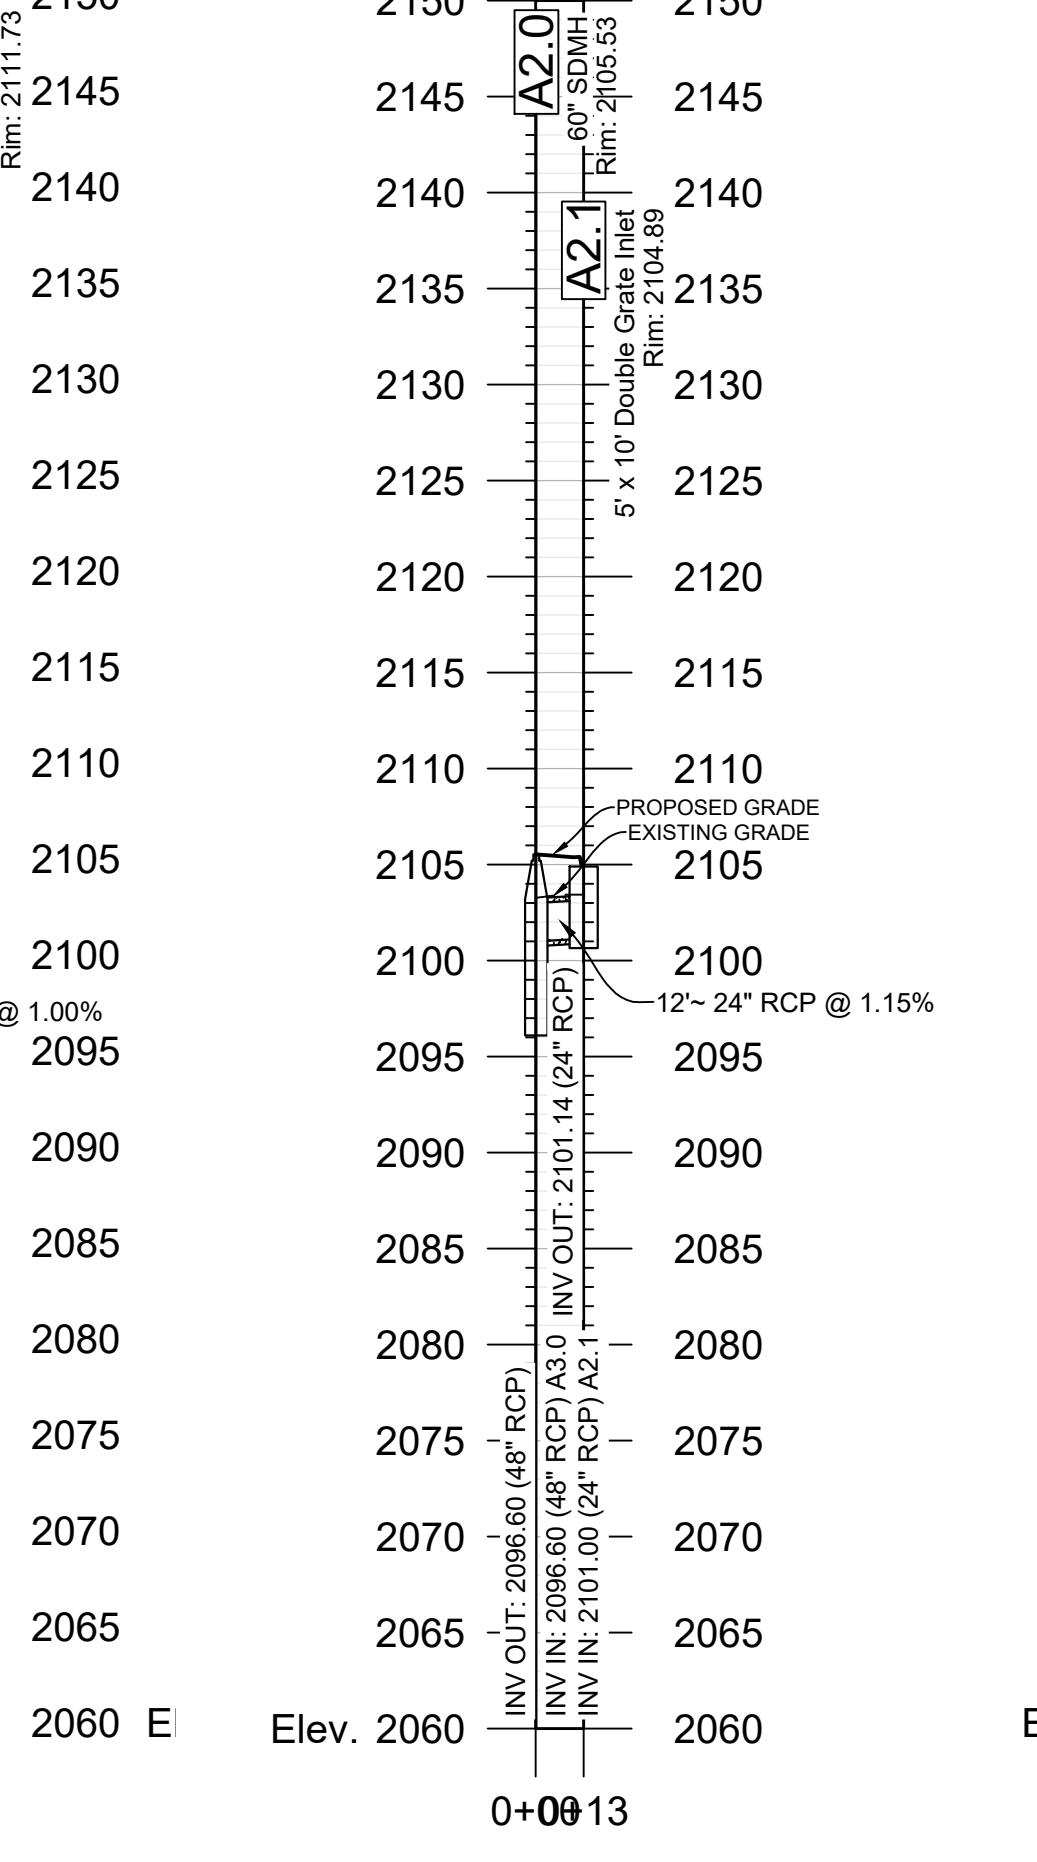


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Station: 0+00.00 - 0+12.51
1" = 50' (H)
1" = 10' (V)

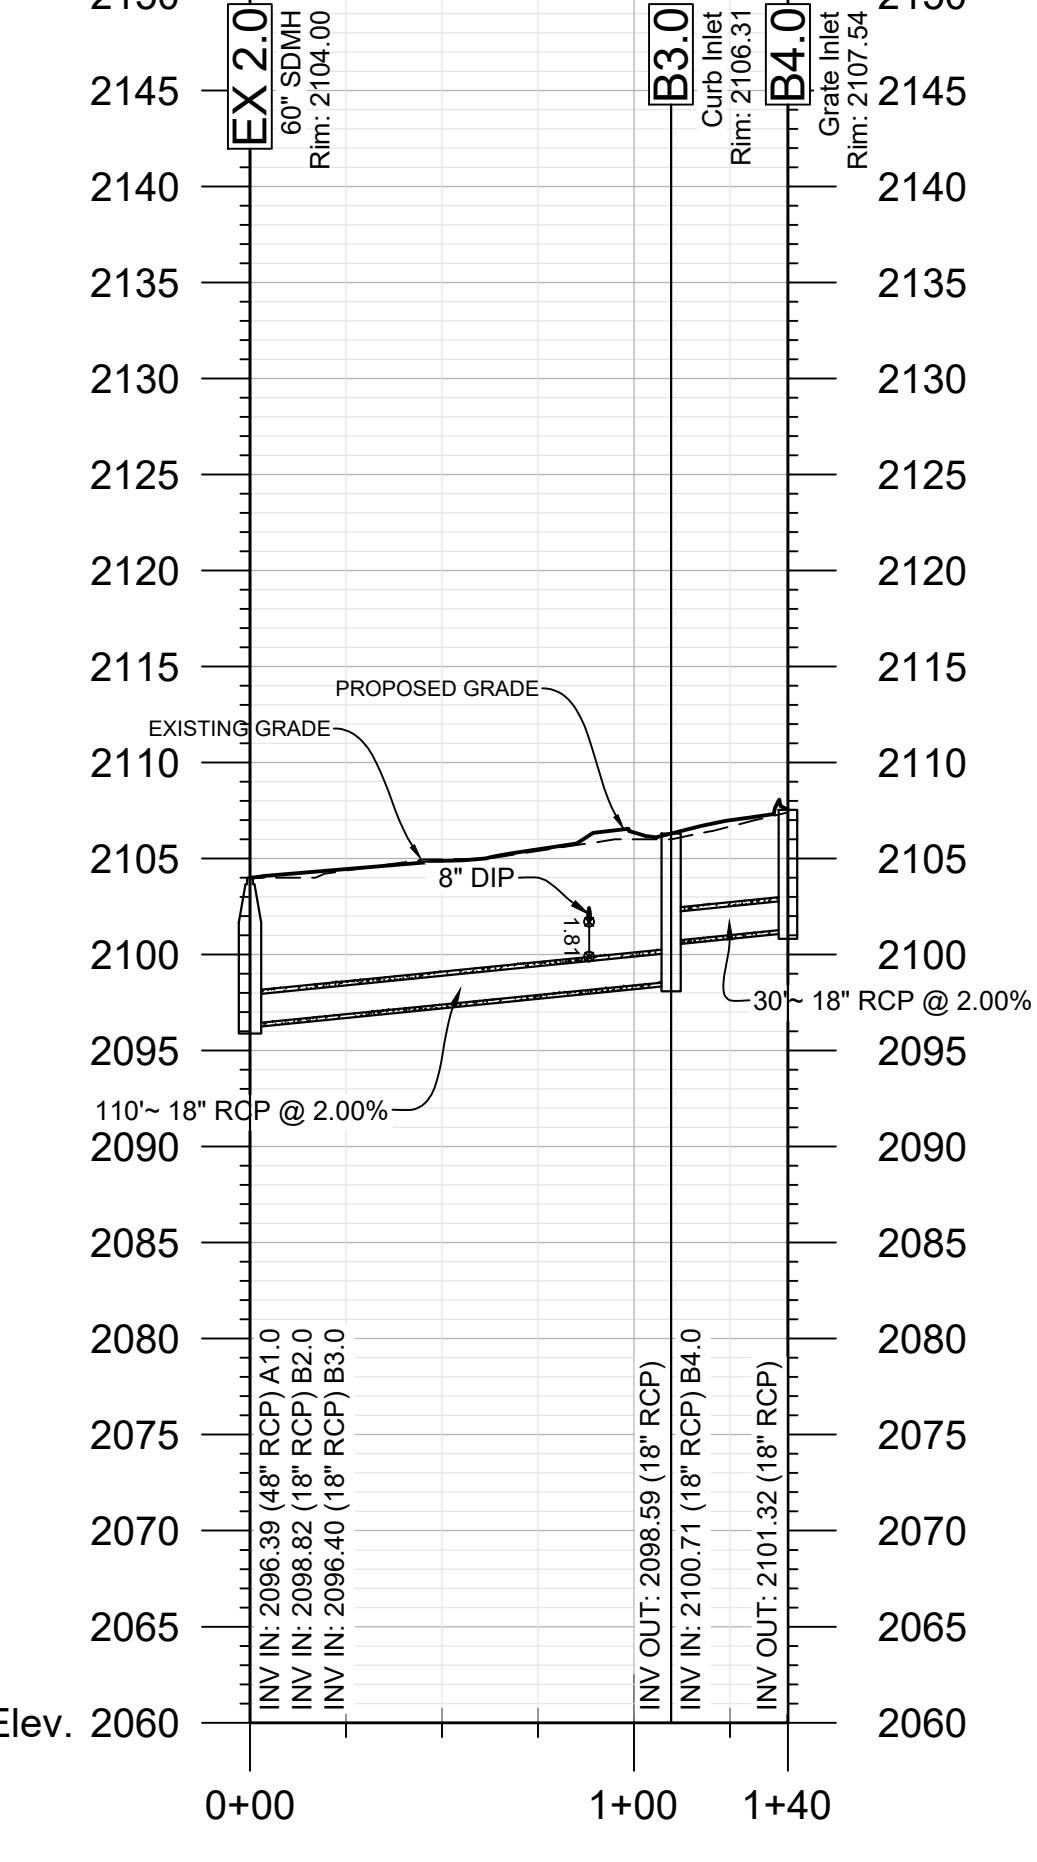


B4.0 - EX2.0
Station: 0+00.00 - 1+40.07
1" = 50' (H)
1" = 10' (V)

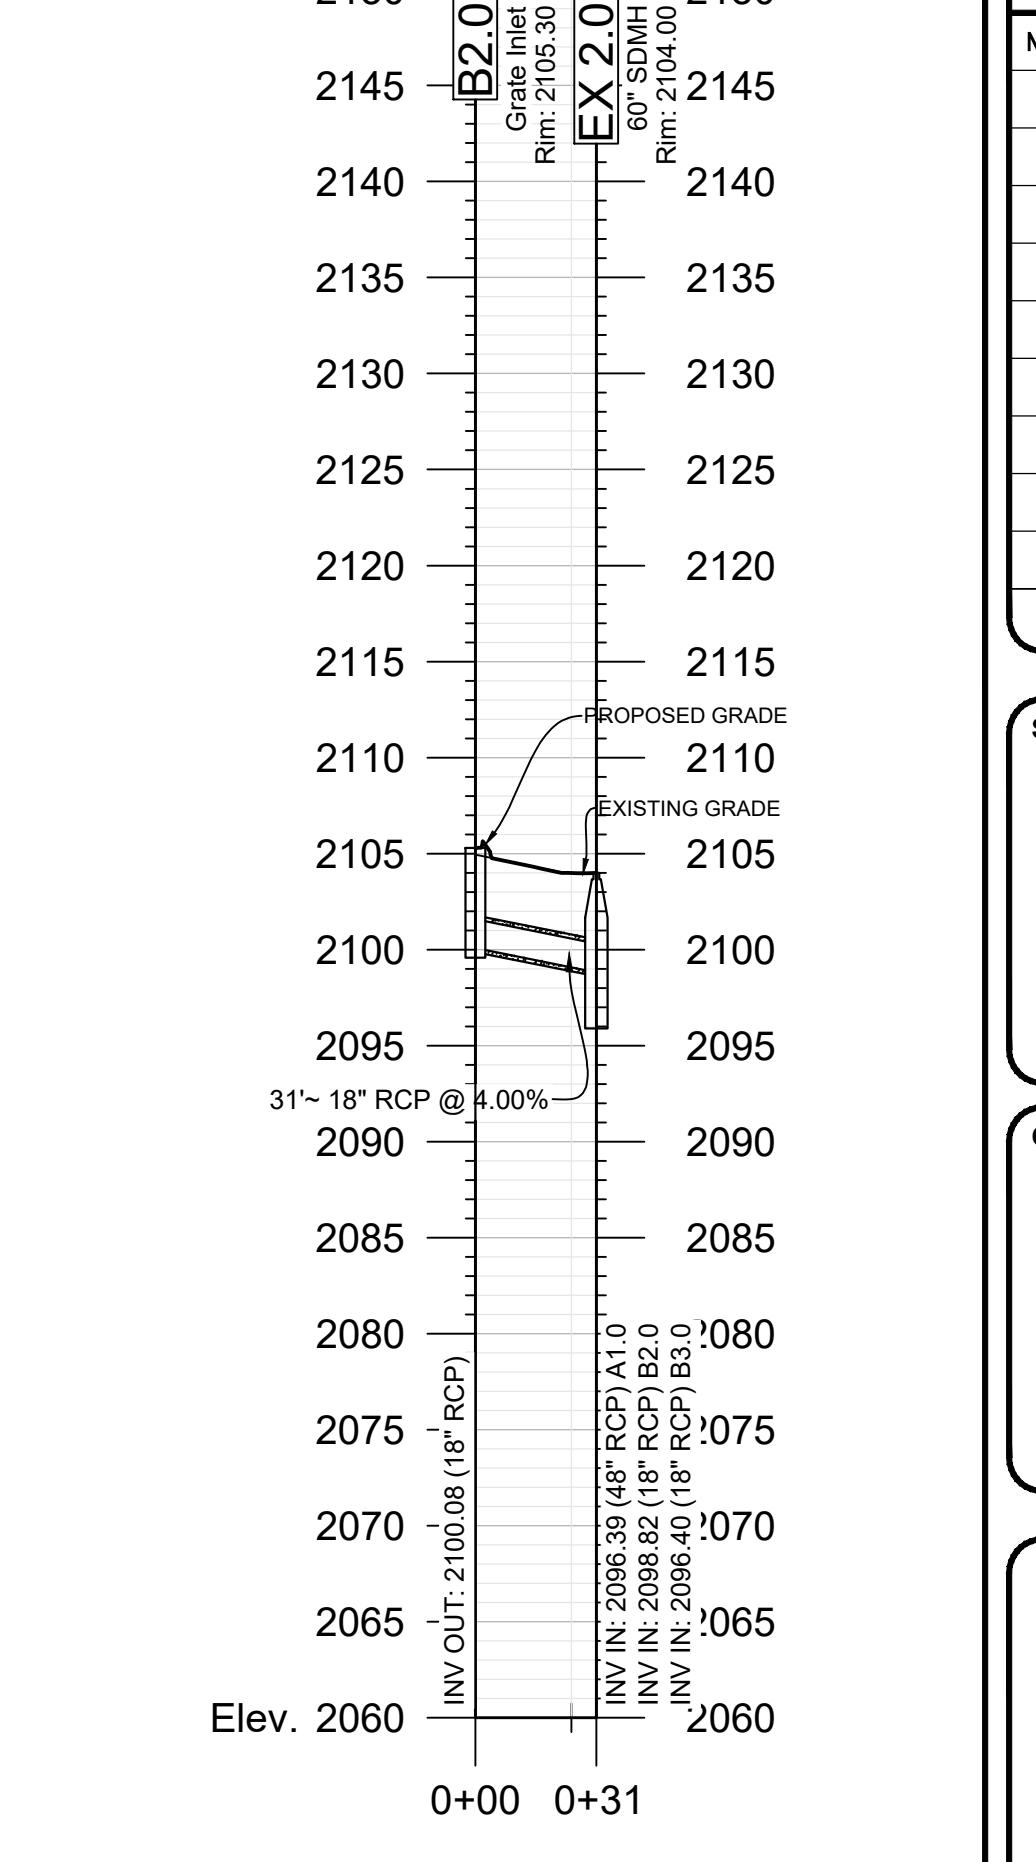


B2.0 - EX2.0
Station: 0+00.00 - 0+31.48
1" = 50' (H)
1" = 10' (V)

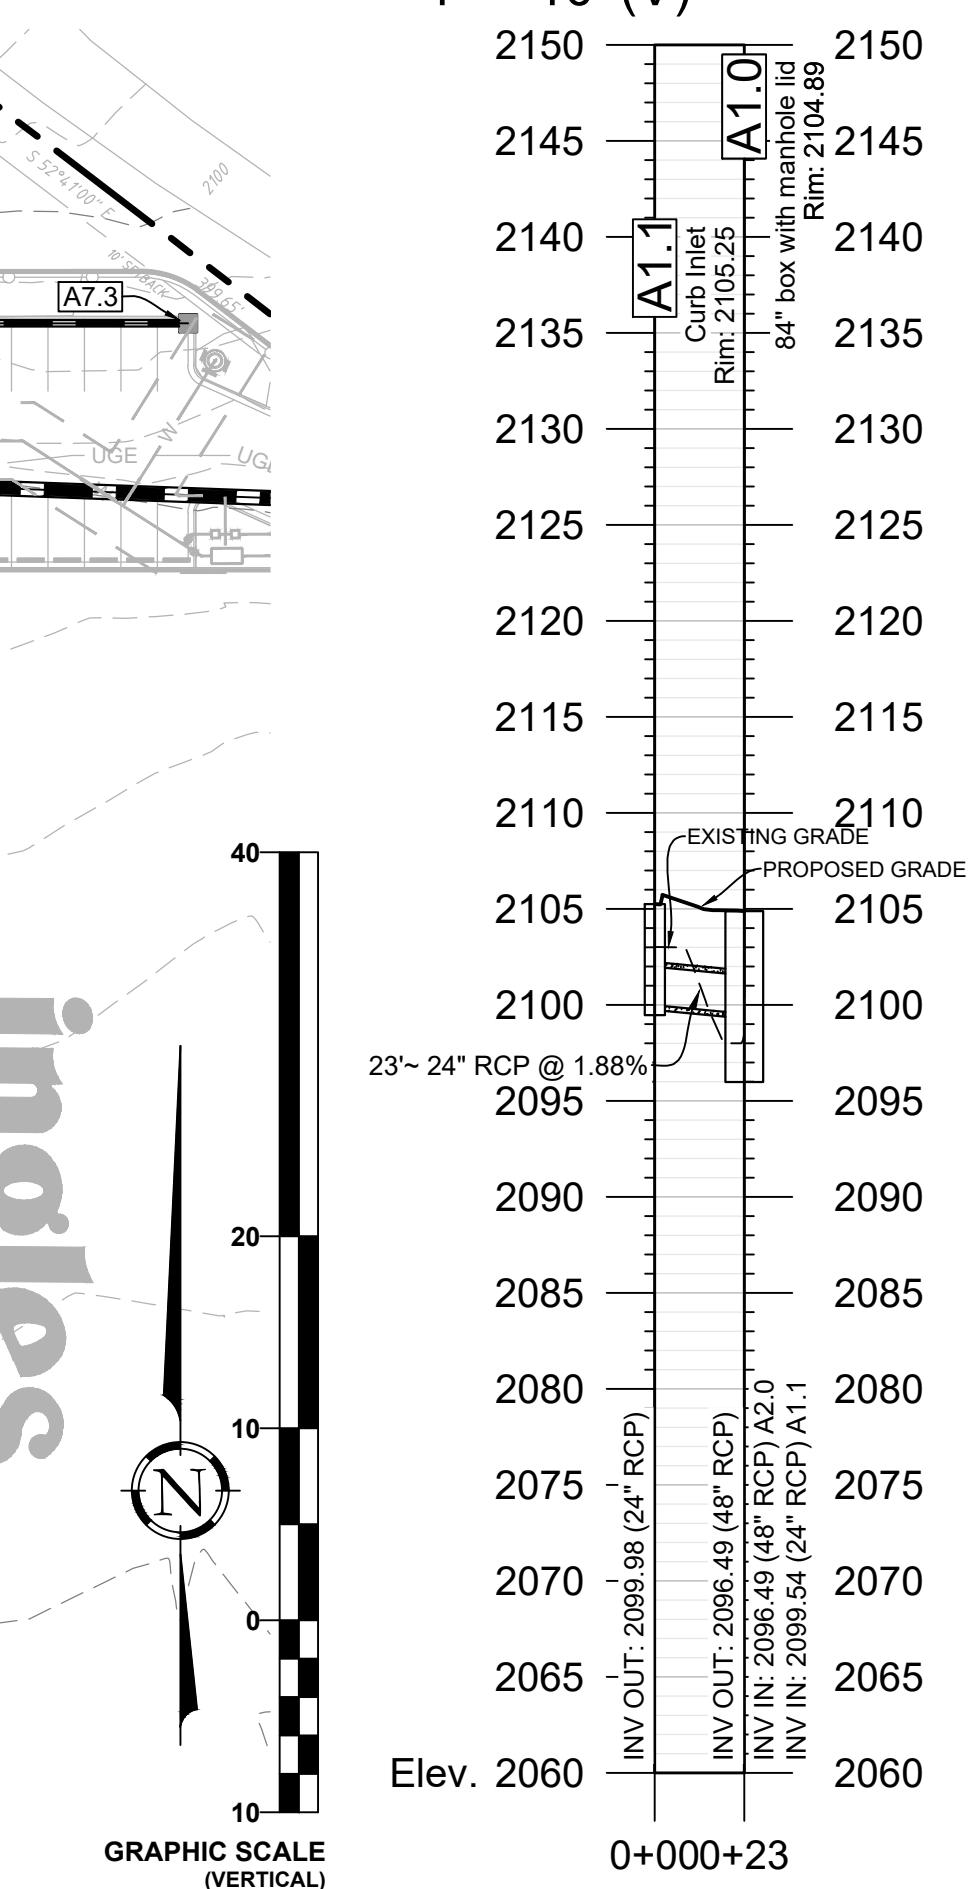

A1.0 - A1.1
Station: 0+00.00 - 0+23.00
1" = 50' (H)
1" = 10' (V)

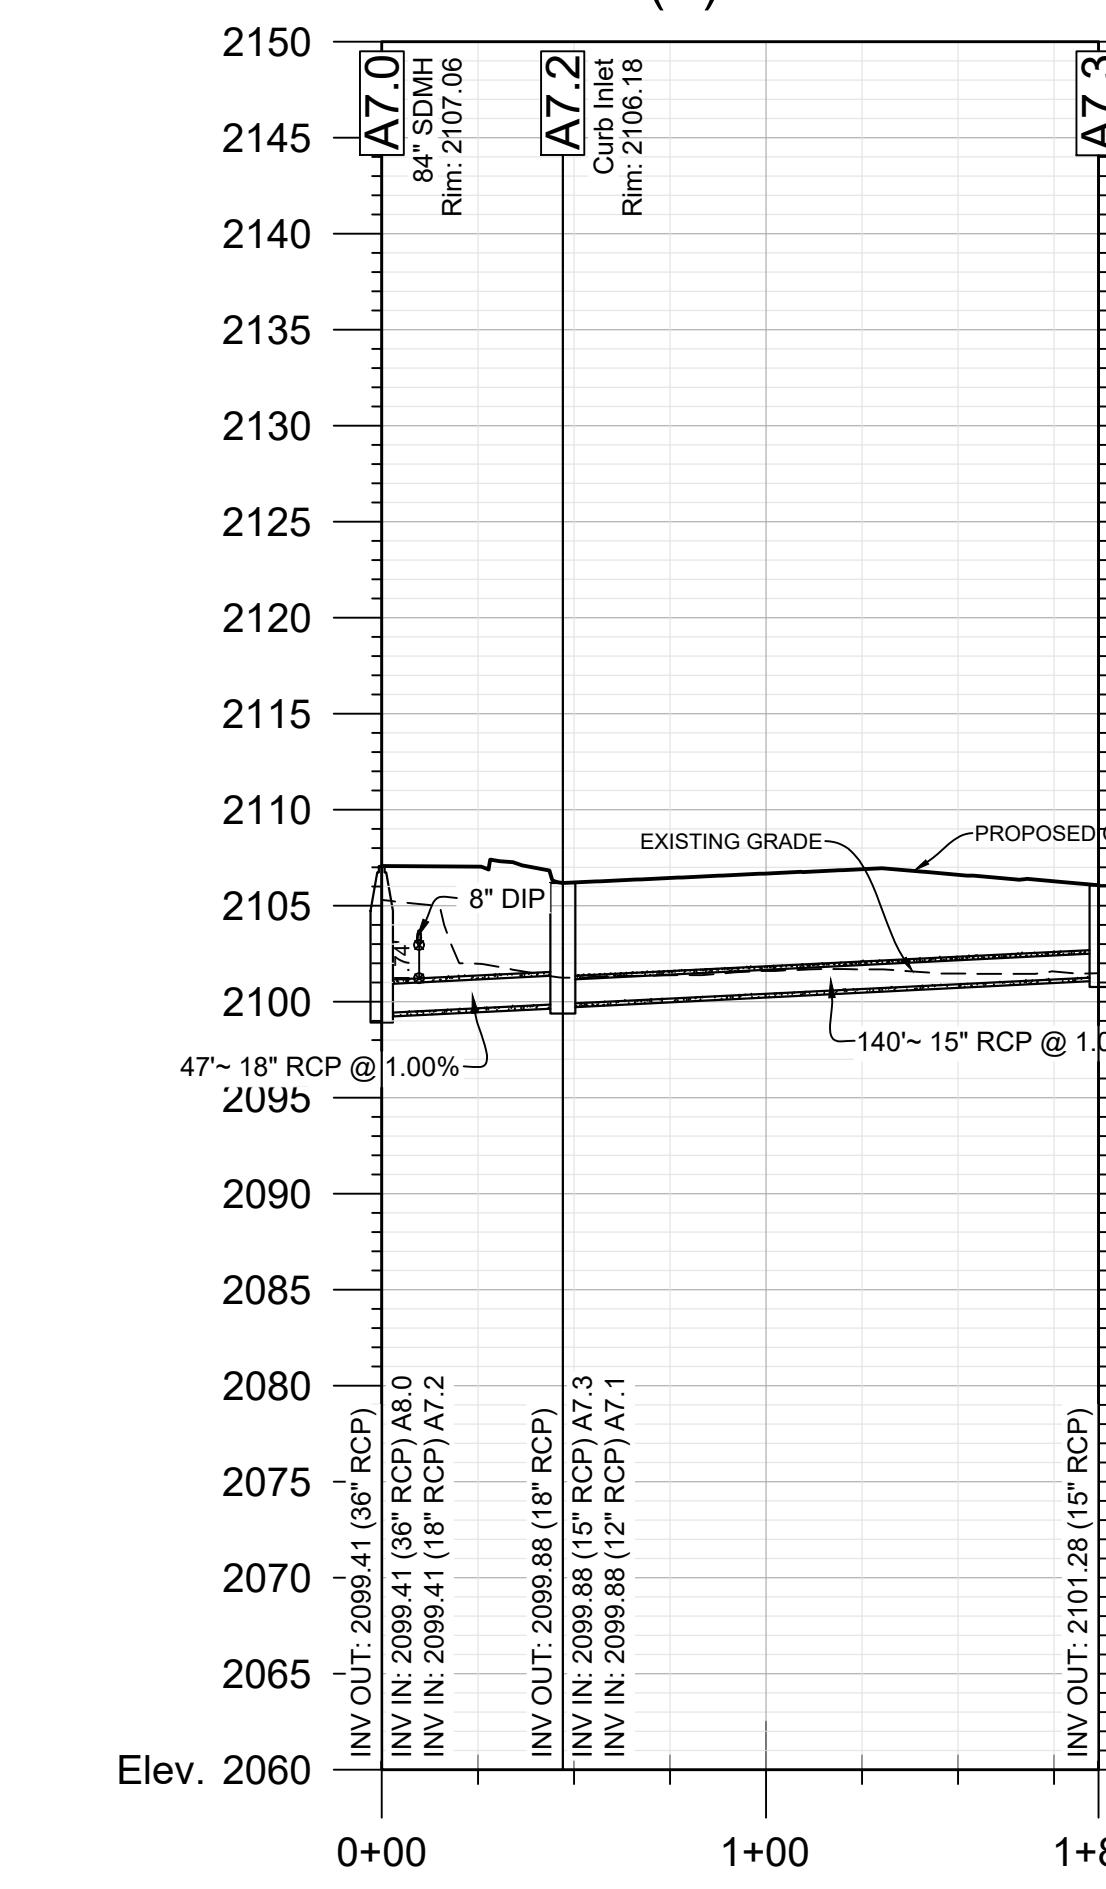

A7.0 - A7.3
Station: 0+00.00 - 1+86.58
1" = 50' (H)
1" = 10' (V)

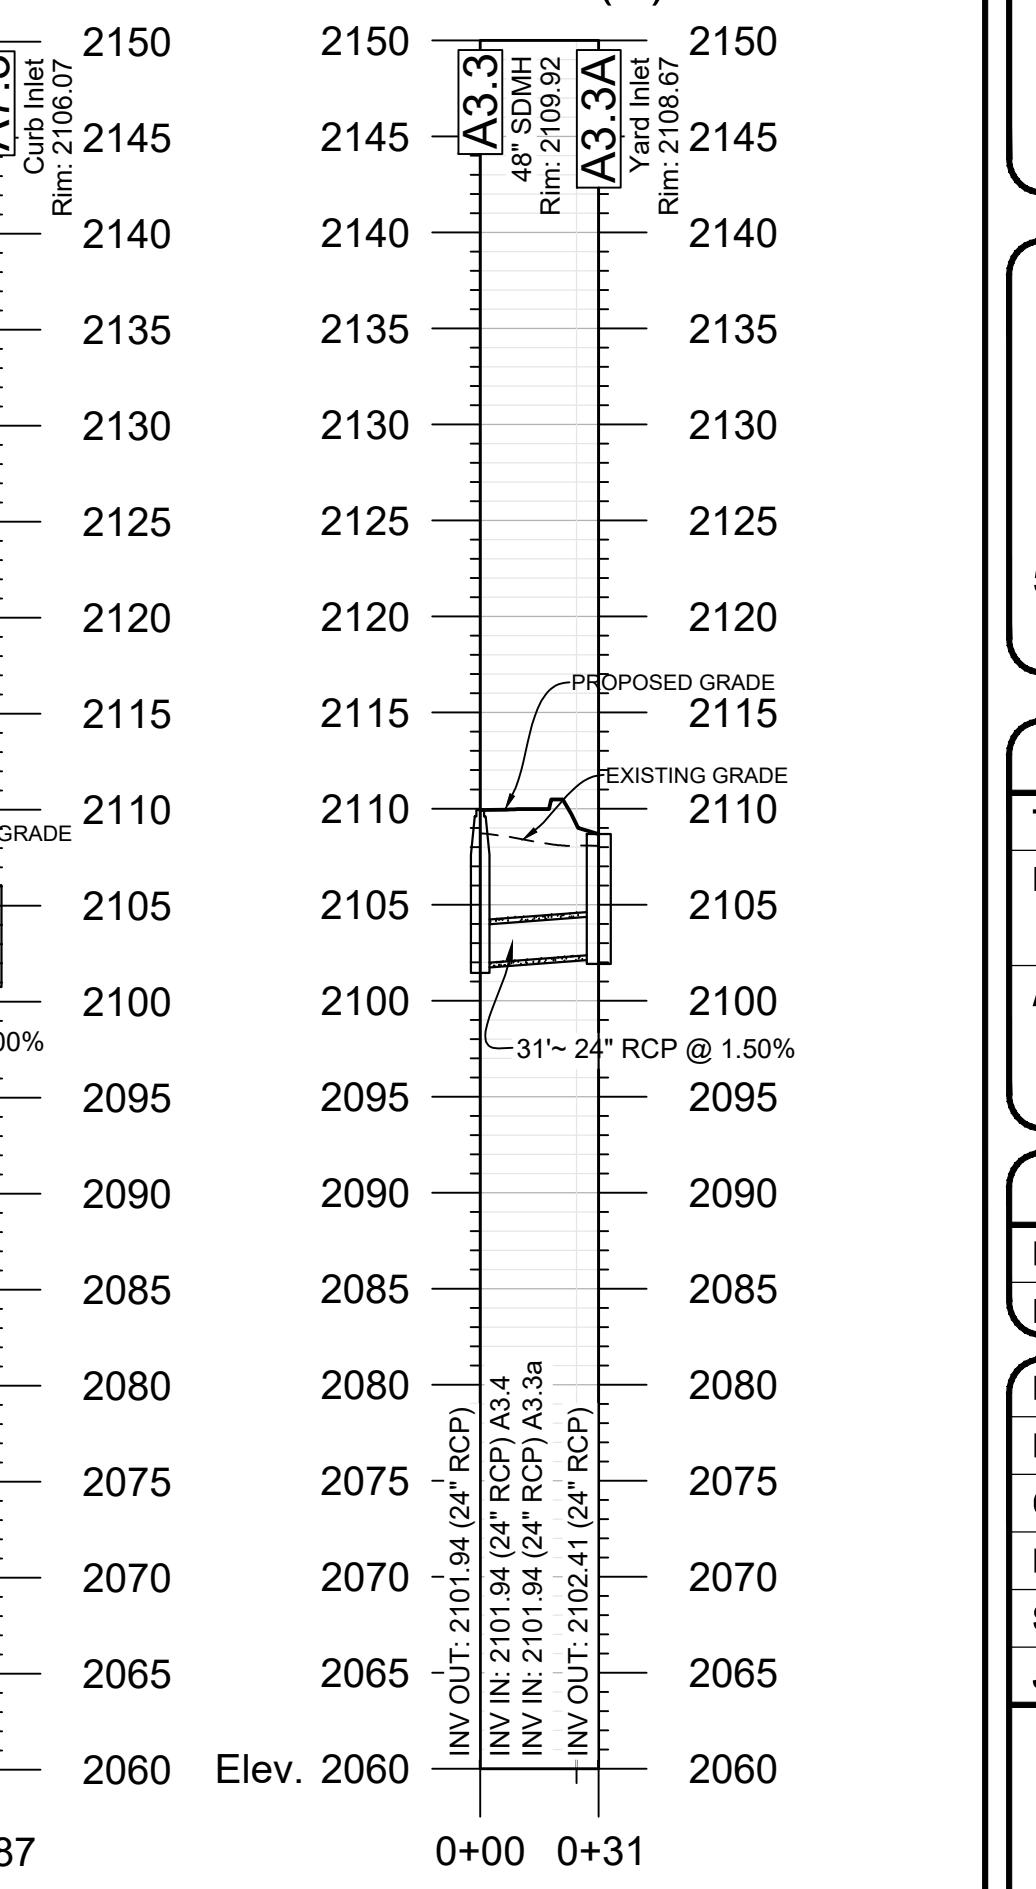


A3.3 - A3.3A
Station: 0+00.00 - 0+30.81
1" = 50' (H)
1" = 10' (V)

REVISIONS:

NO.	DATE	DESCRIPTION	BY
1	8/26/22	REVISED WATER LAYOUT AND ADDED RESTAURANT GREASE TRAP	SCW
2	6/28/23	MAJOR REVISION	PCB

SEAL:

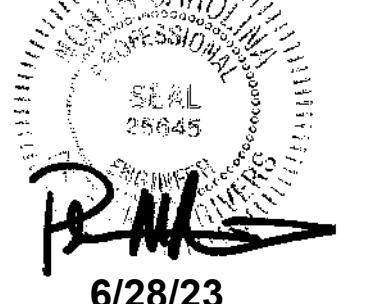

CORPORATE SEAL:



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ingles

Markets Incorporated
STORE #140
5620 HENDERSONVILLE ROAD
FLETCHER NC

PROPERTY INFORMATION:

TAX MAP NUMBER: 9652316641, 9652316277
REFERENCE D.B. & PG: DB 3396 PG 597

ADDITIONAL INFO:

9652314347
DB 3464 PG 102


ISSUE FOR CONSTRUCTION:

PERMIT DATE:
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DRAWN BY: PCB
DESIGN BY: JDC
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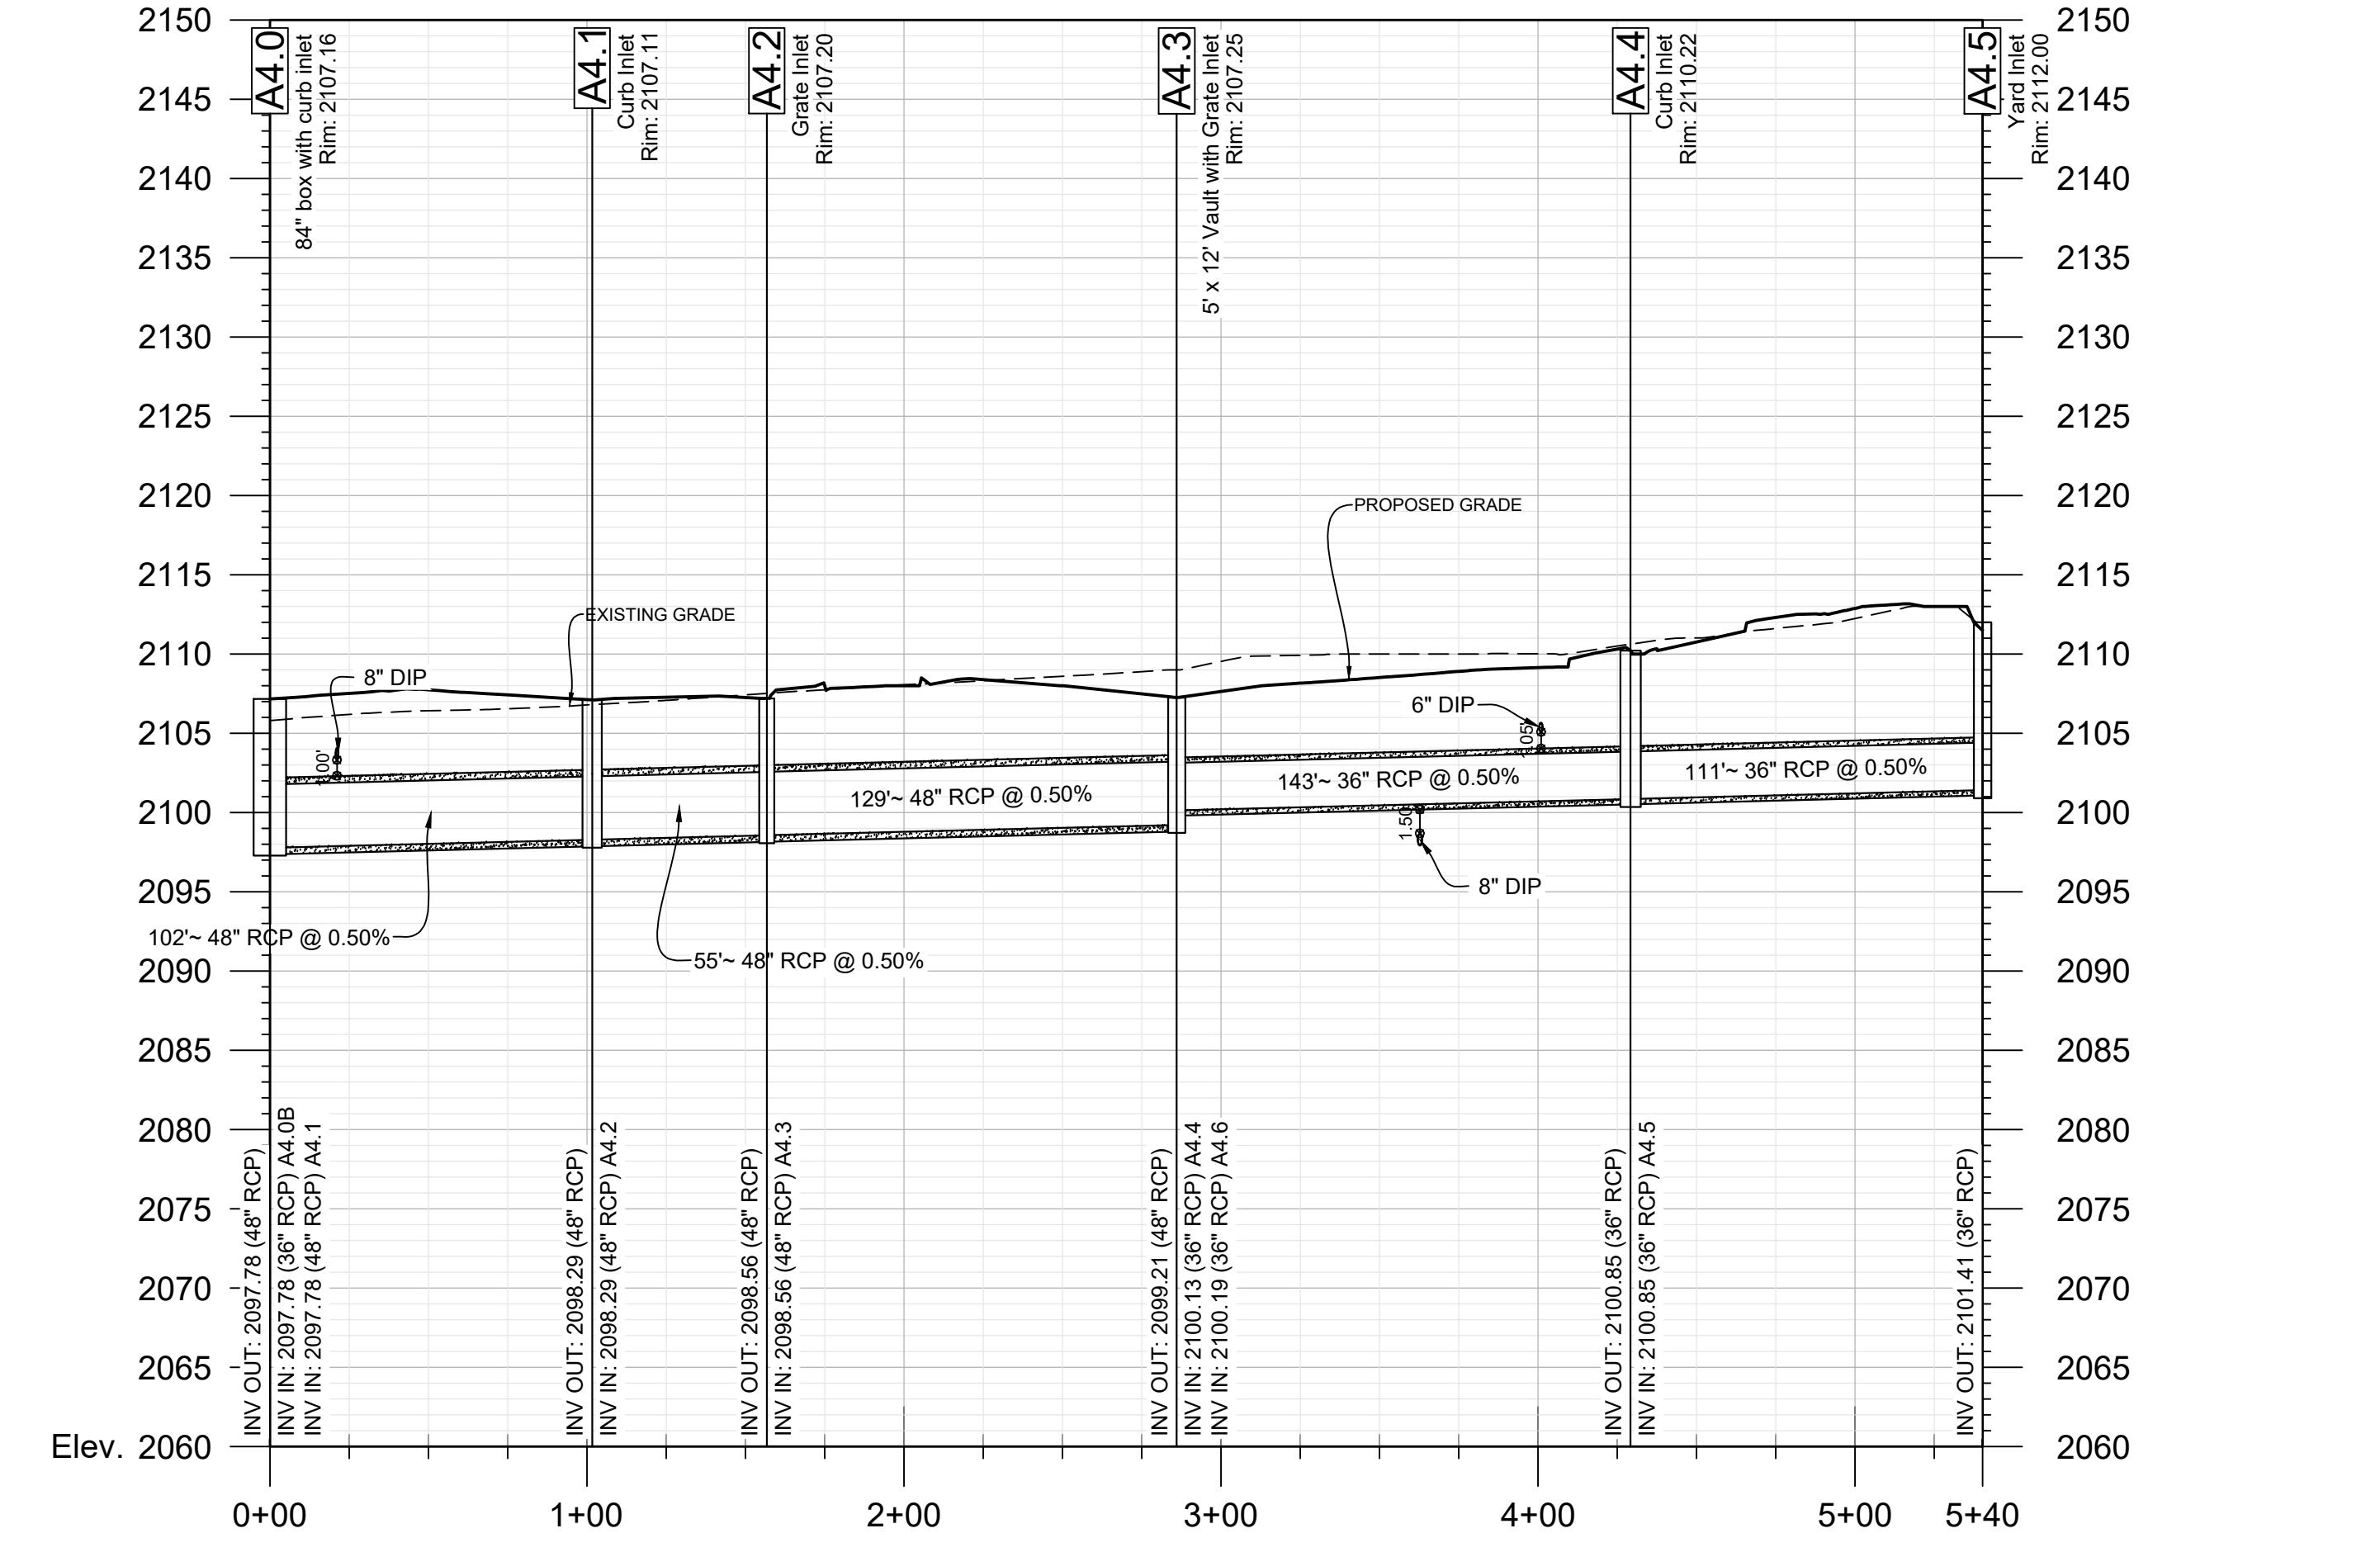
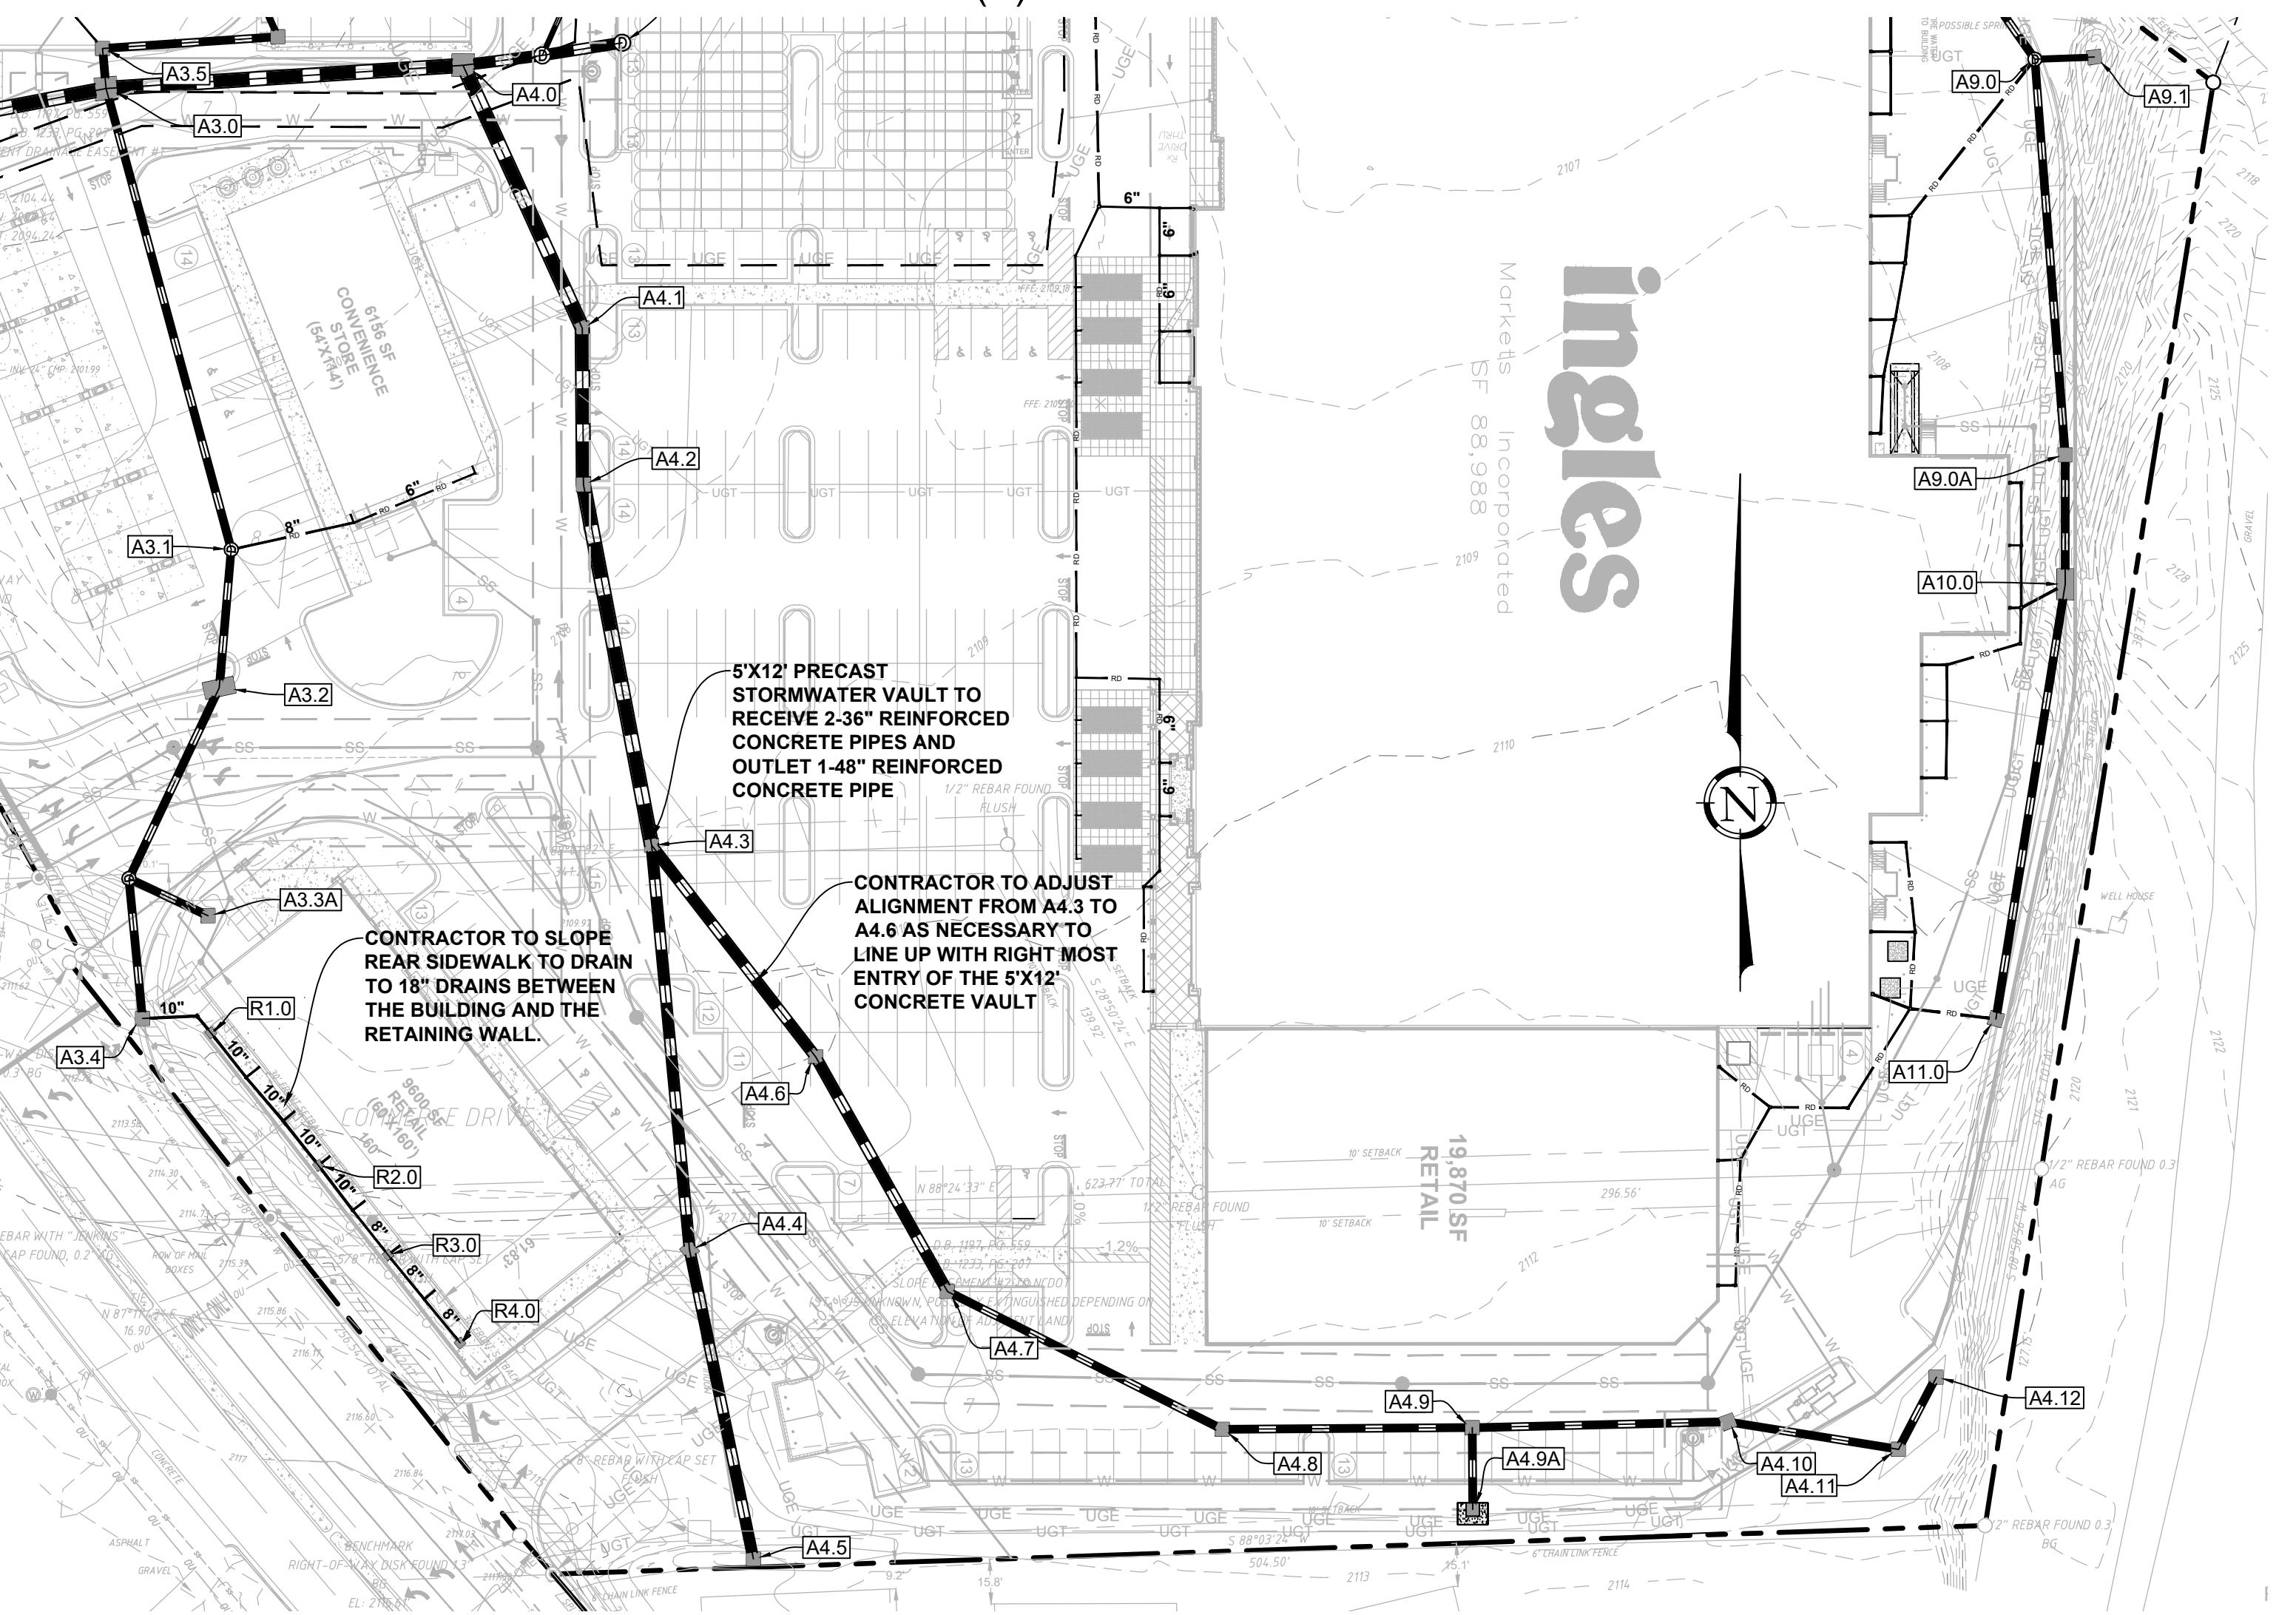
STORMWATER PLAN AND PROFILE

C-110


STORE #140
HENDERSONVILLE ROAD
FLETCHER NC

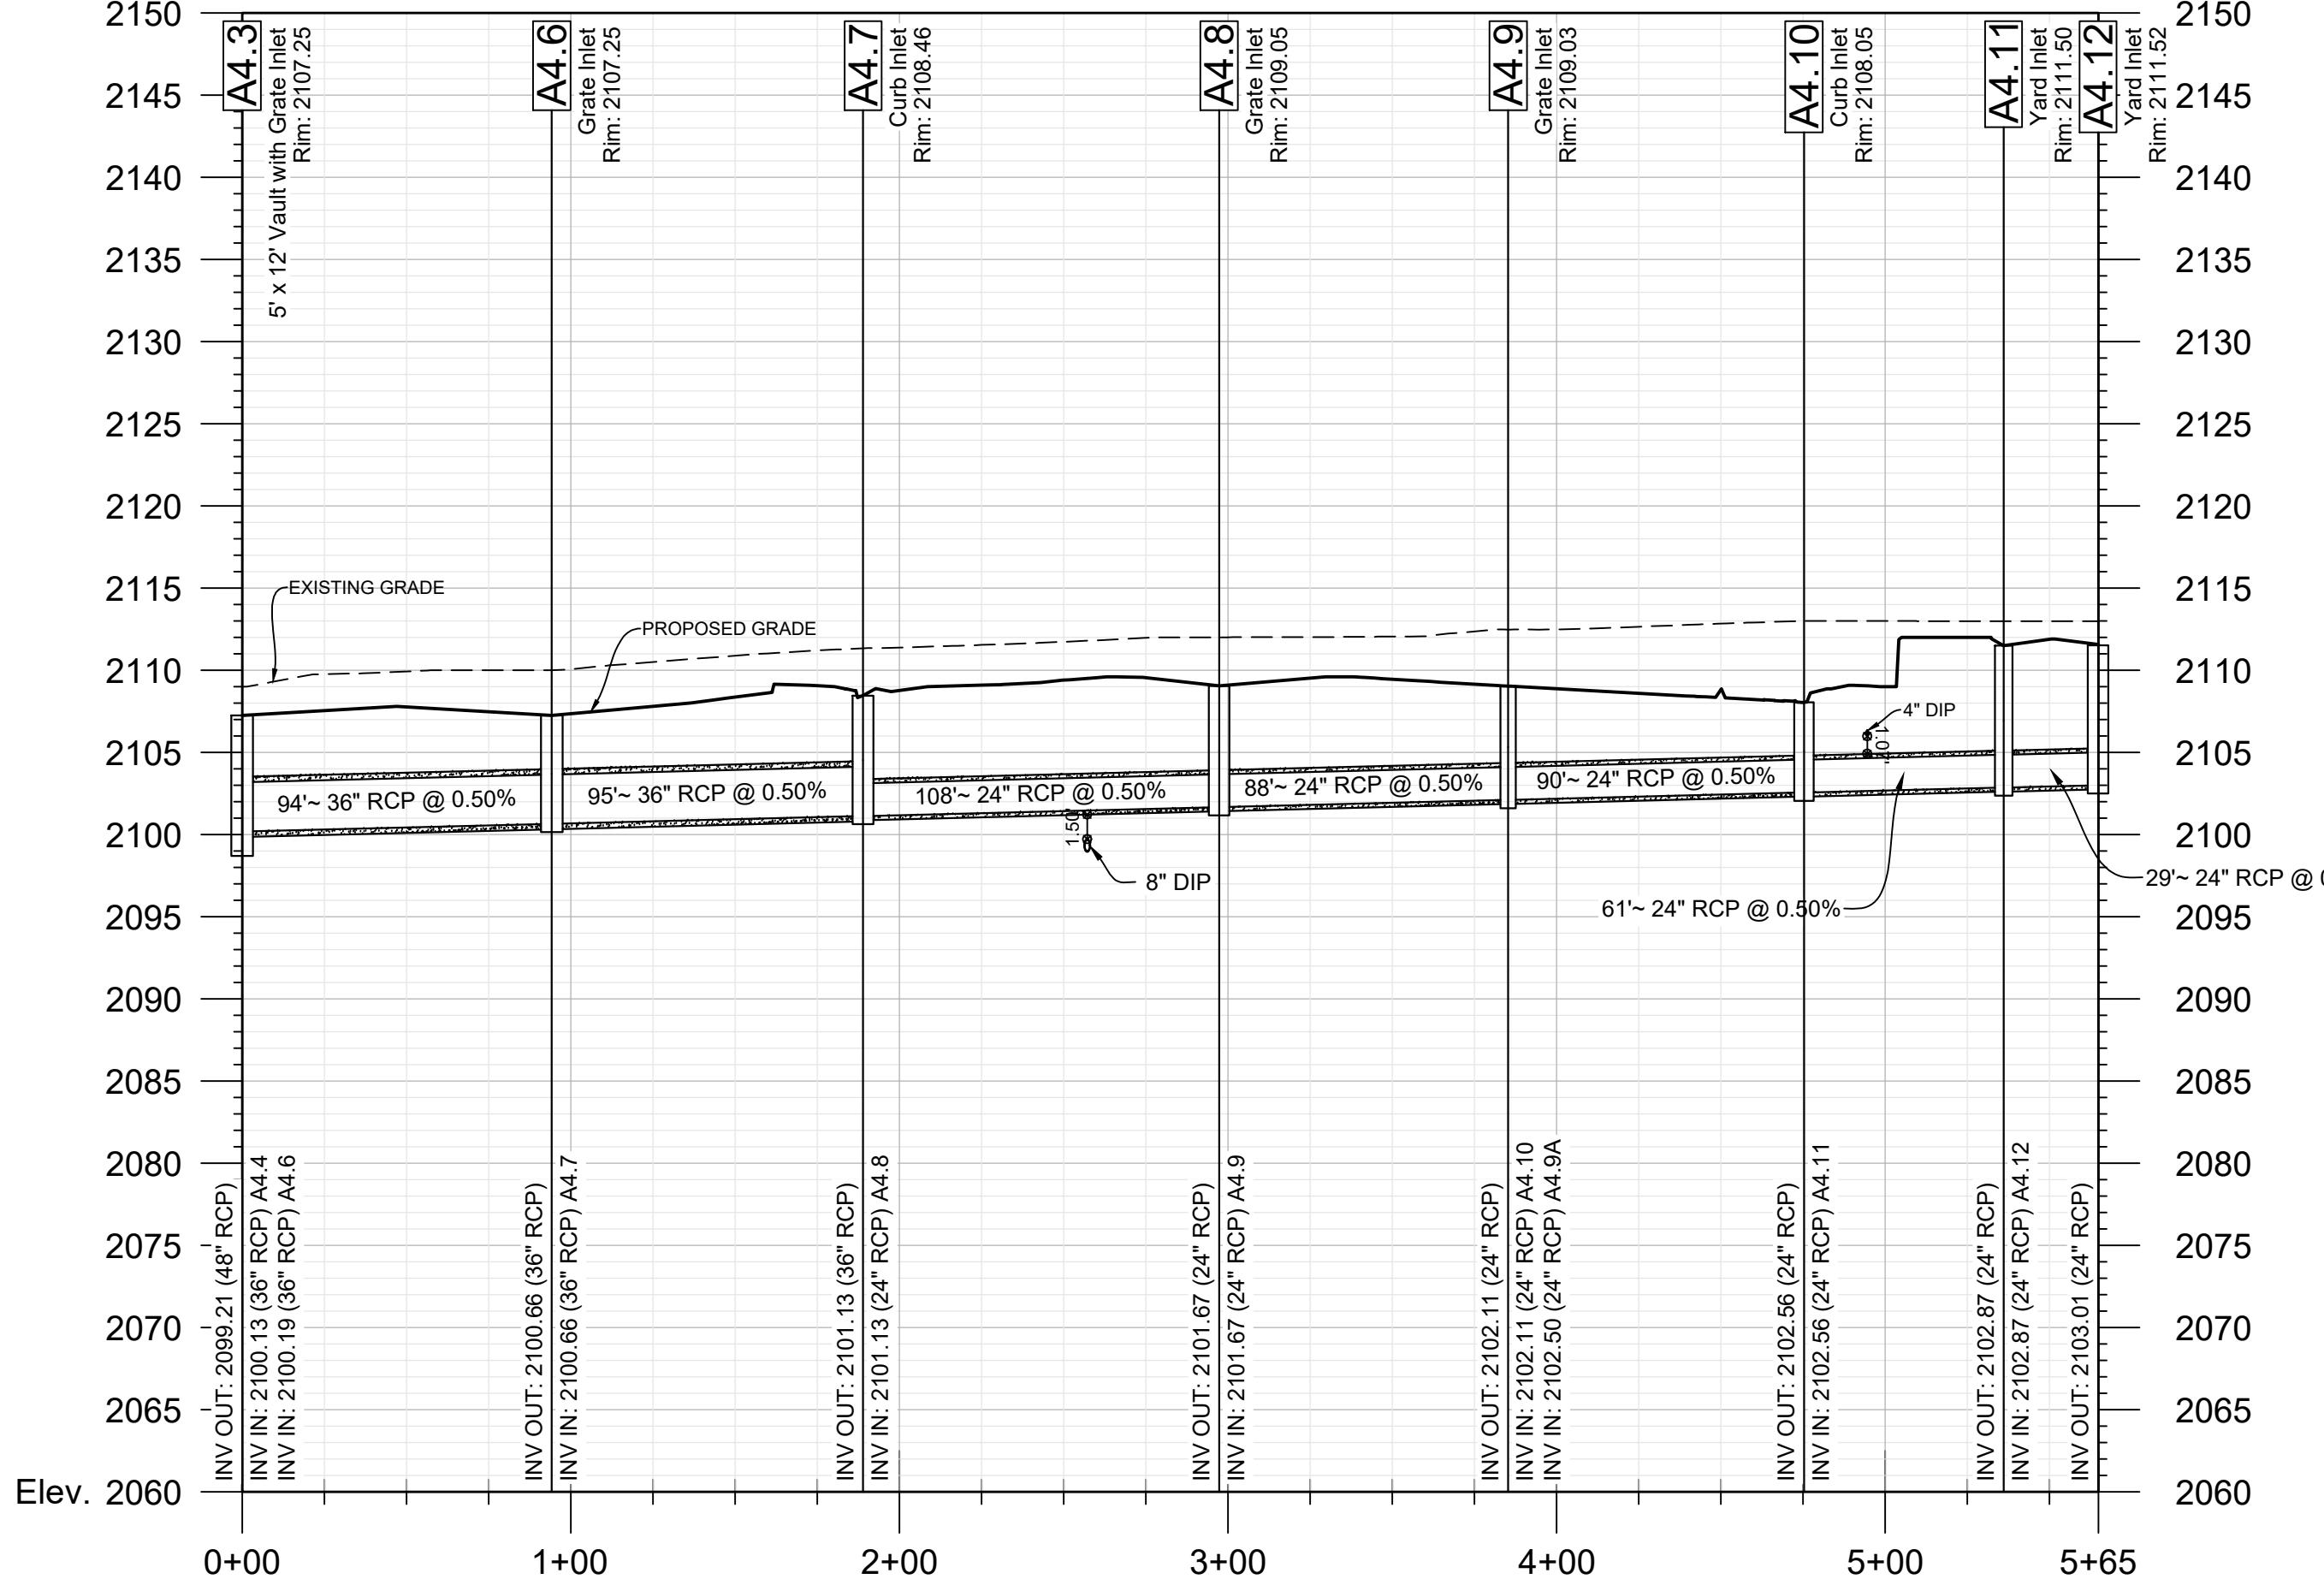

A4.3 - A4.11
Station: 0+00.00 - 5+64.87
1" = 50' (H)
1" = 10' (V)




A4.0 - A4.5
Station: 0+00.00 - 5+40.24
1" = 50' (H)
1" = 10' (V)

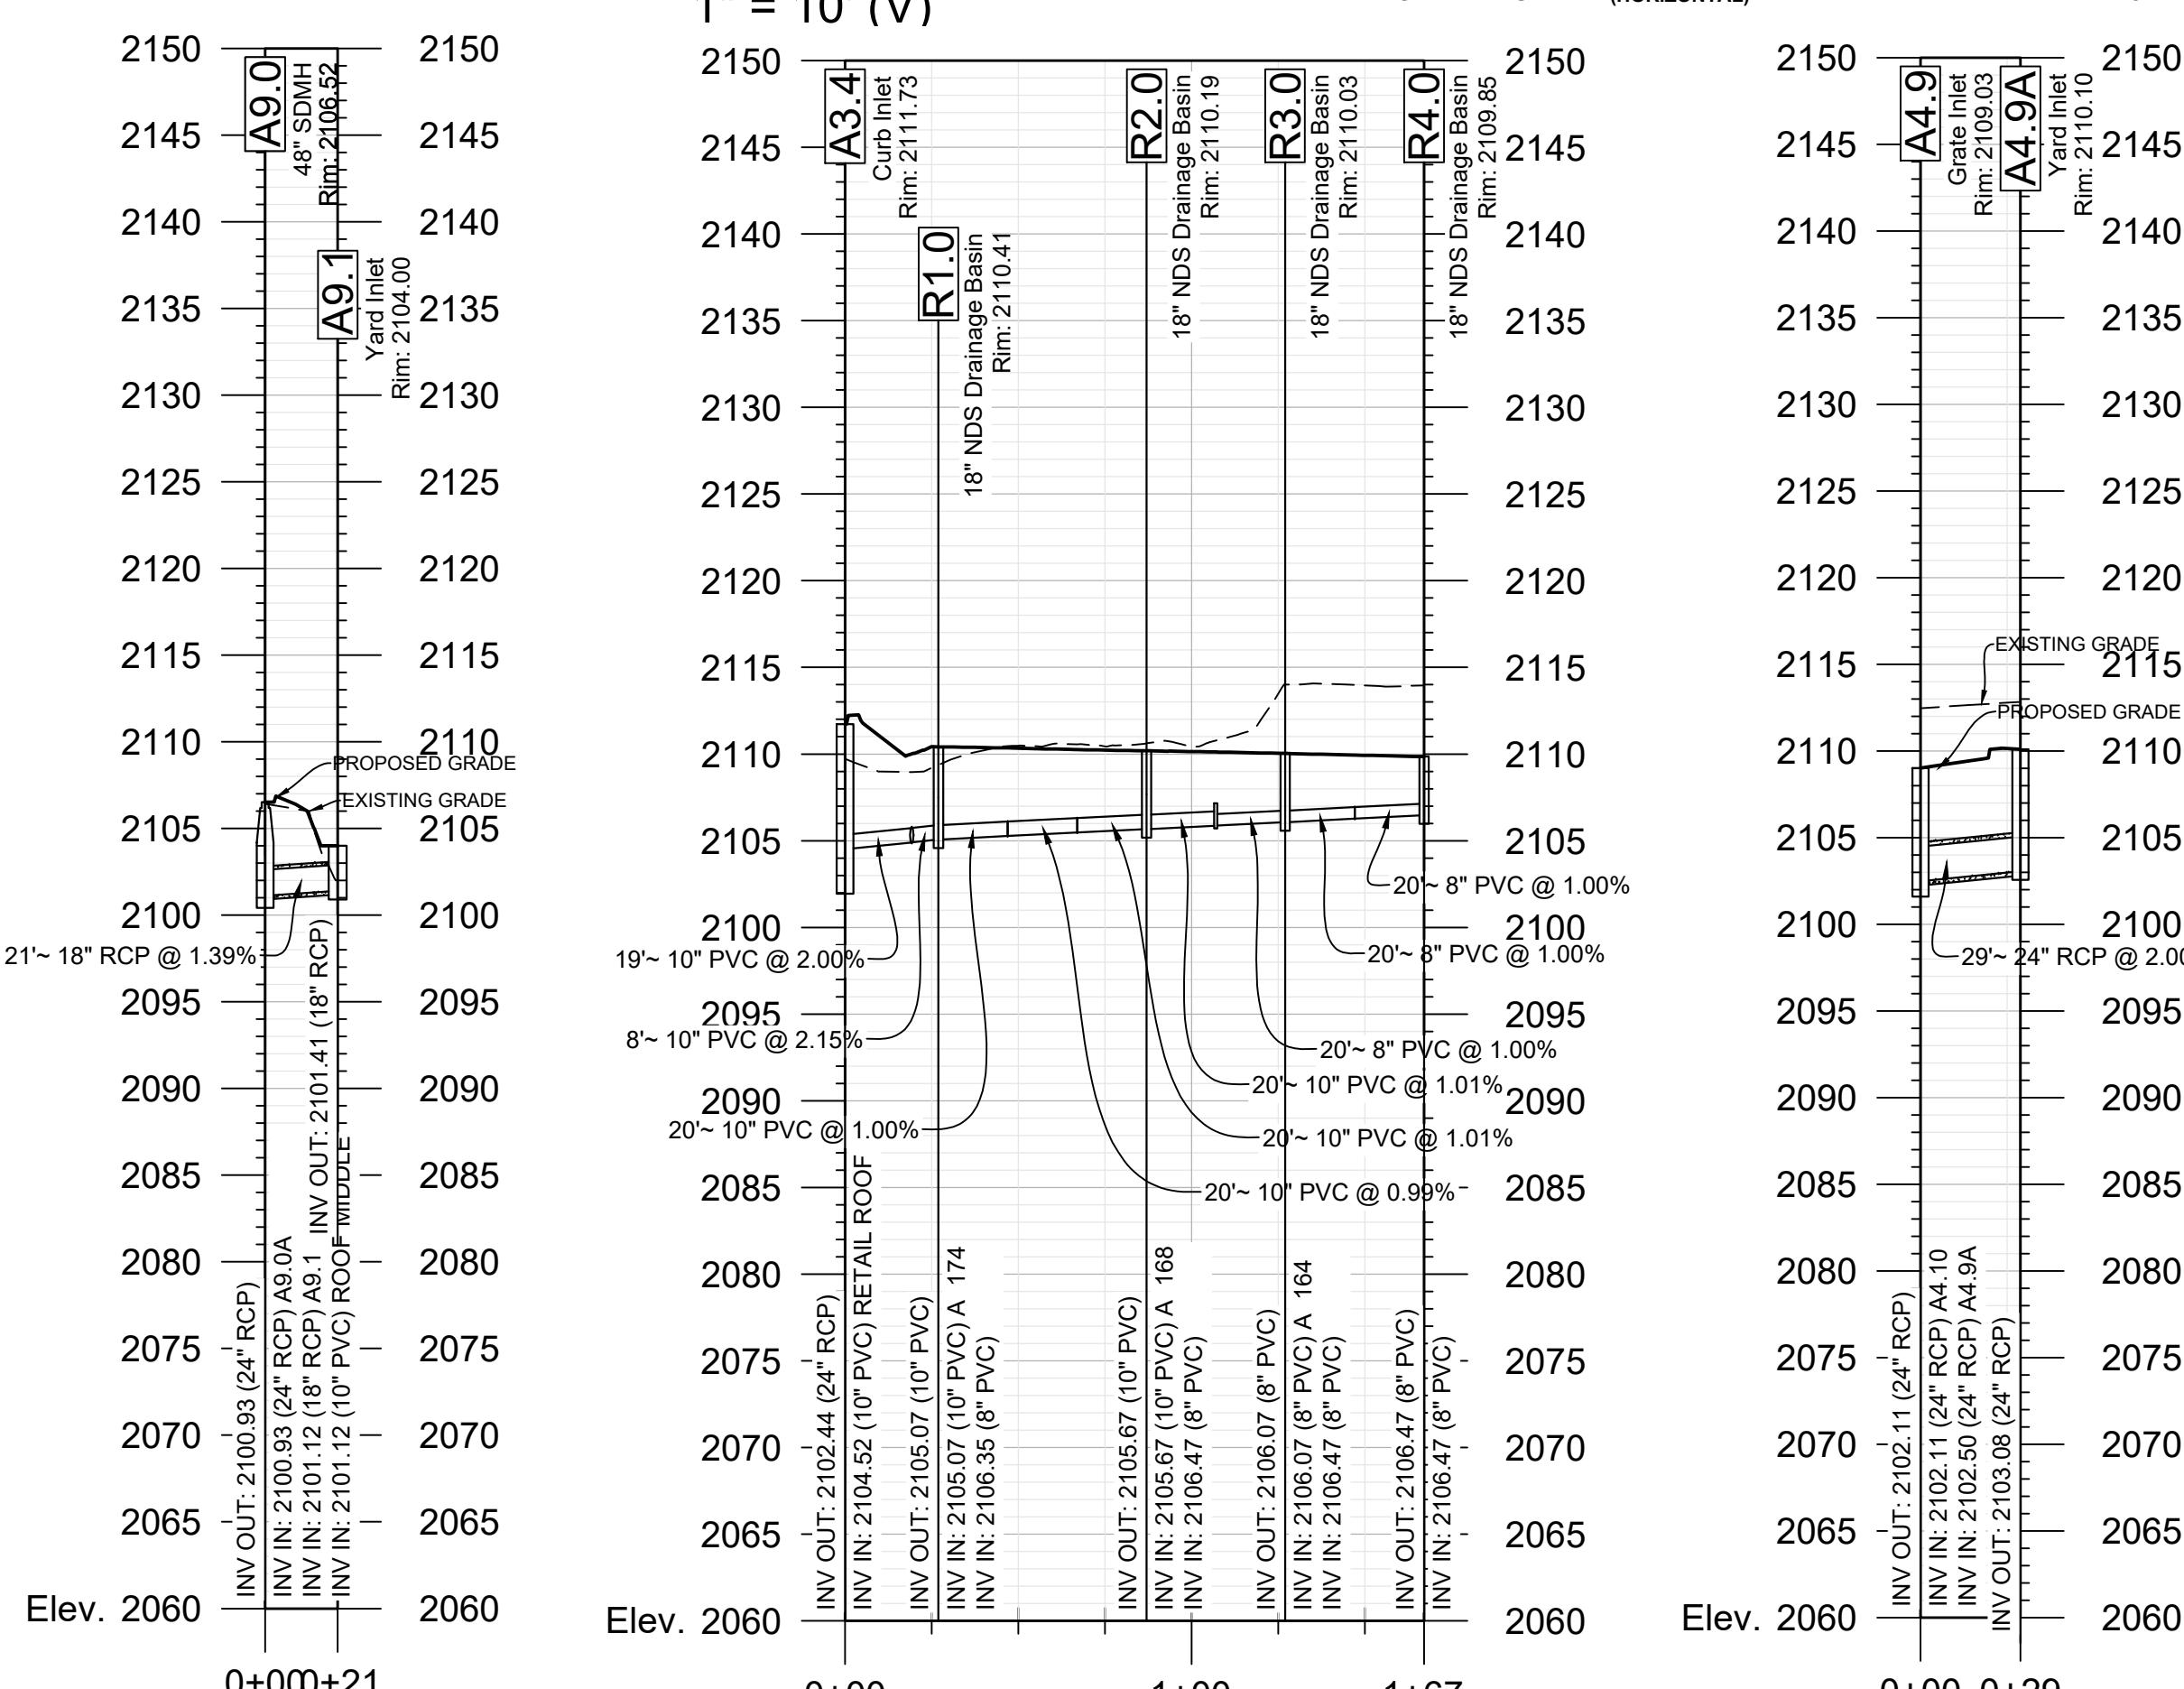

A4.9 - A4.9A
Station: 0+00.00 - 0+28.84
1" = 50' (H)
1" = 10' (V)

A3.4 - R4.0
Station: 0+00.00 - 1+67.04
1" = 50' (H)
1" = 10' (V)

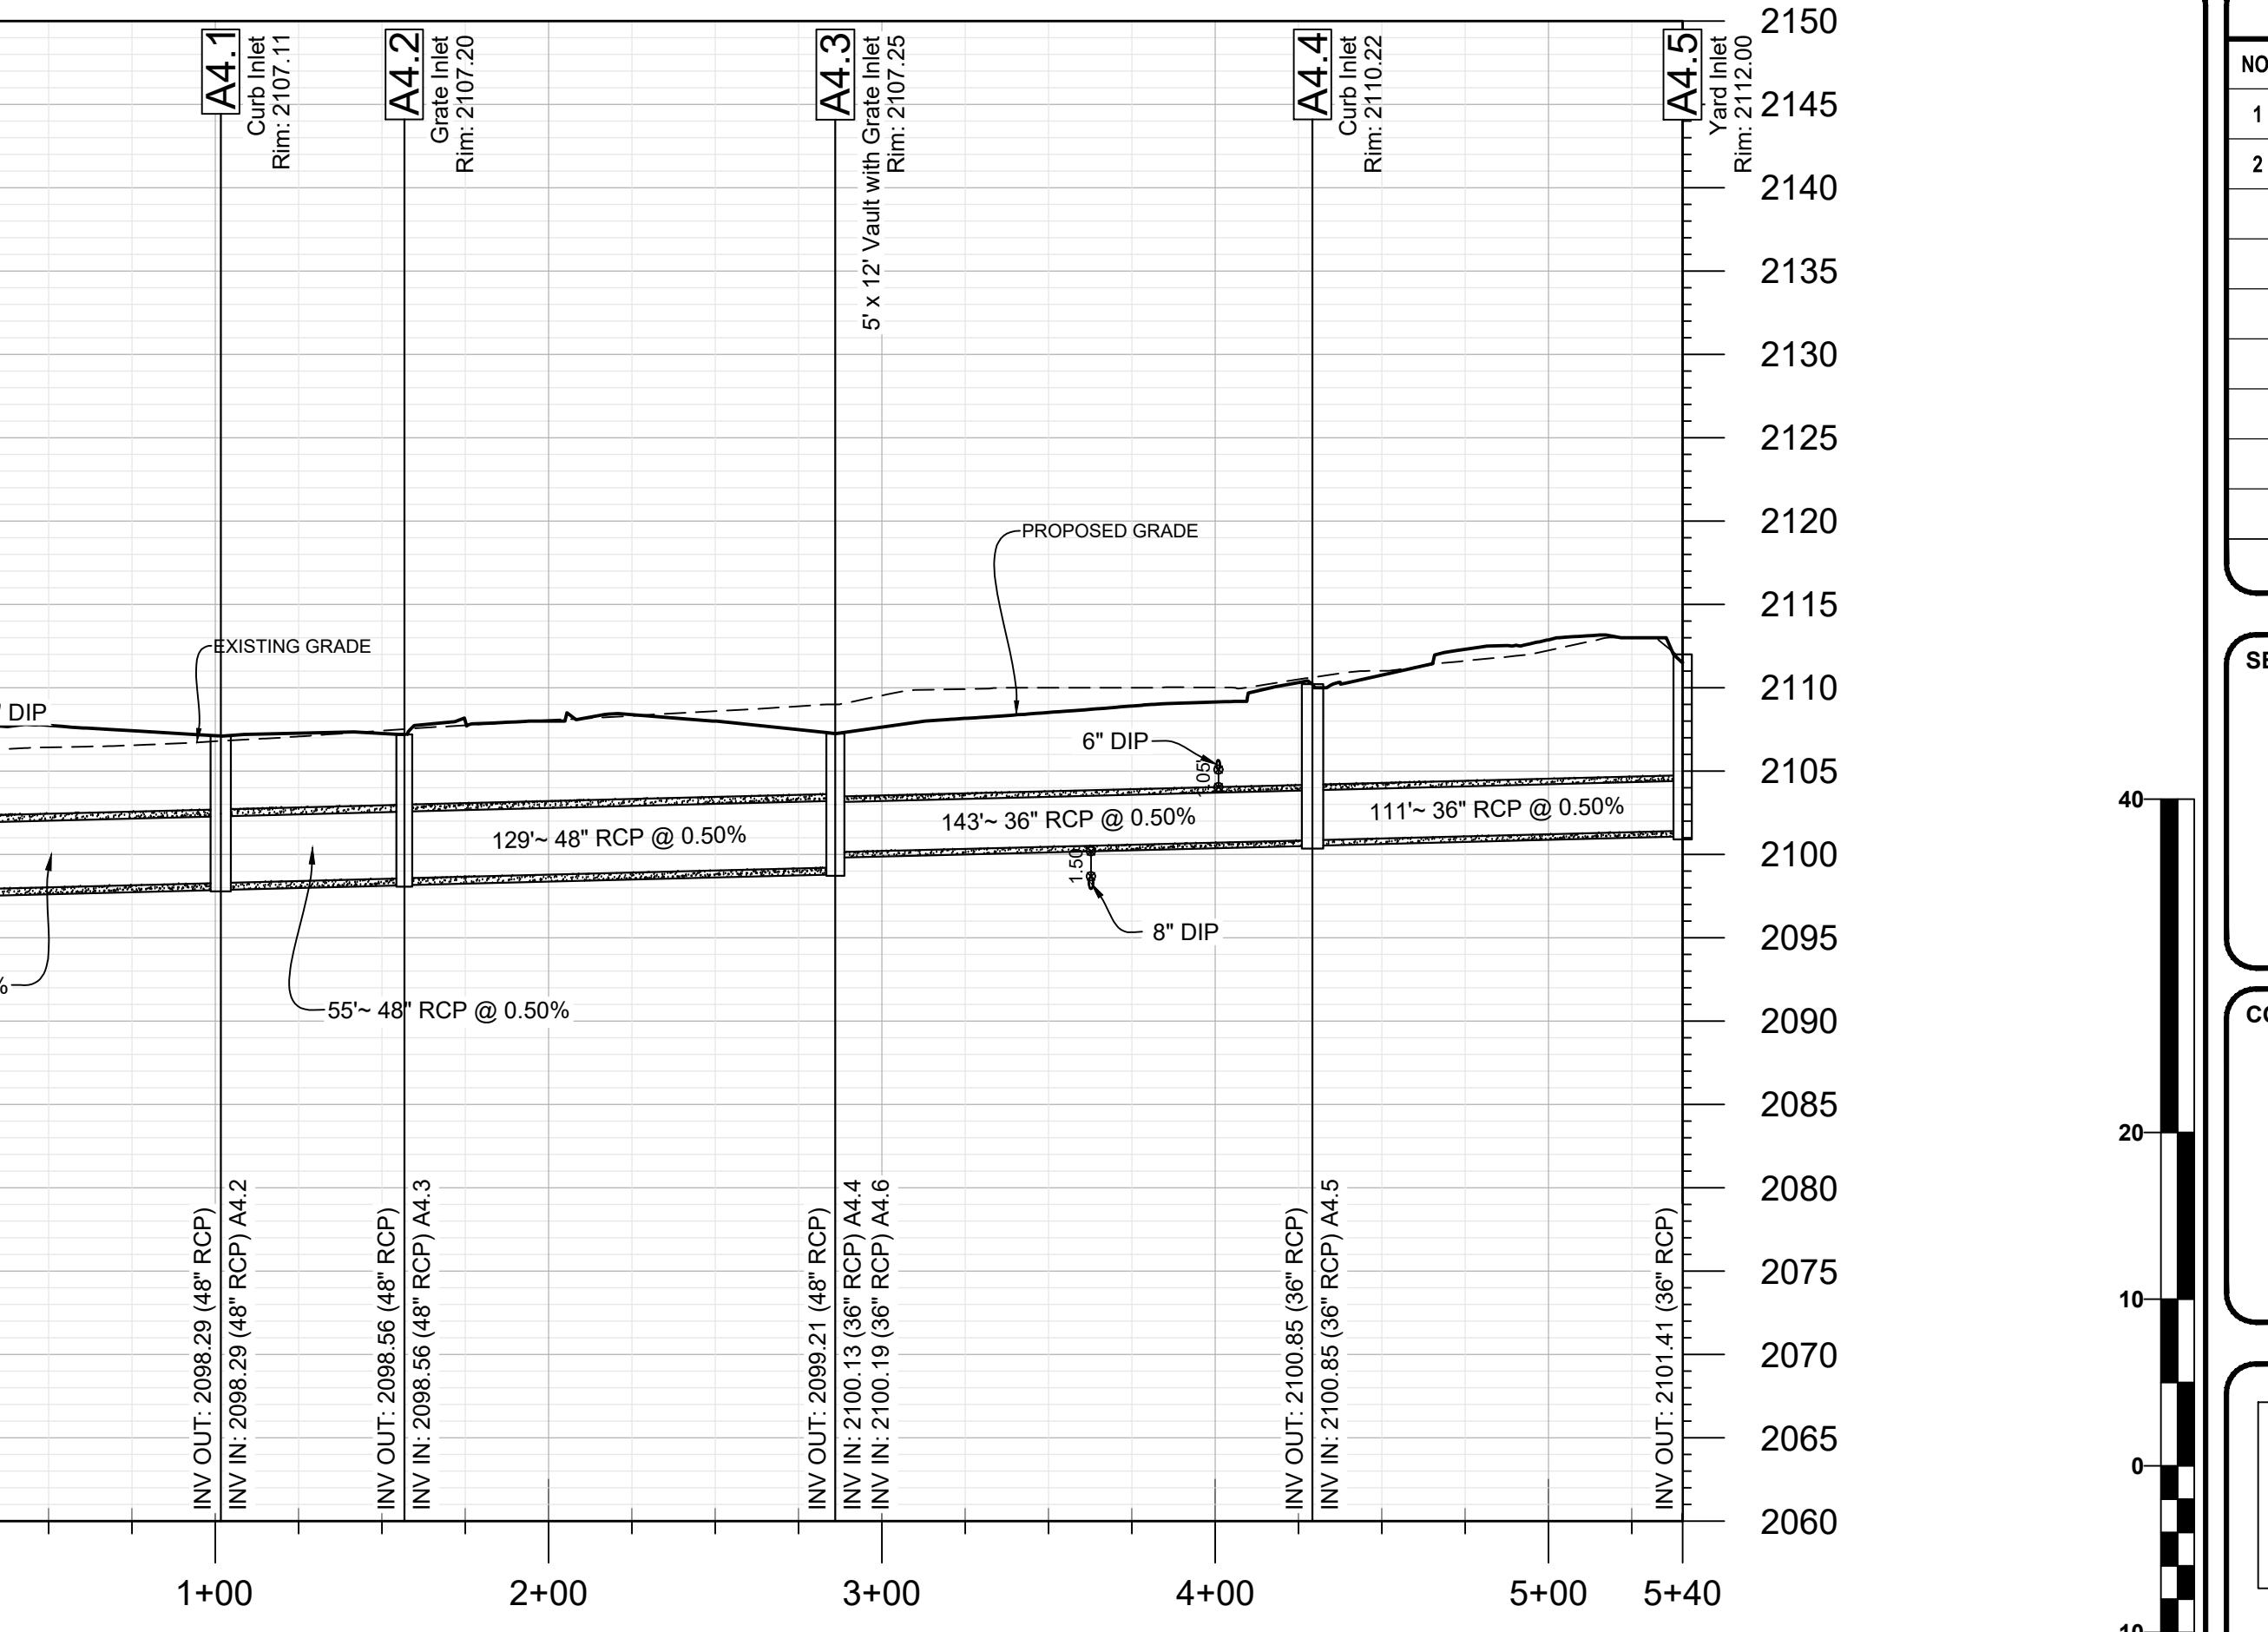


A9.0 - A9.1
Station: 0+00.00 - 0+20.92
1" = 50' (H)
1" = 10' (V)

REVISIONS:

NO.	DATE	DESCRIPTION	BY
1	8/26/22	REVISED WATER LAYOUT AND ADDED RESTAURANT GREASE TRAP	SCW
2	6/28/23	MAJOR REVISION	PCB





SEAL:

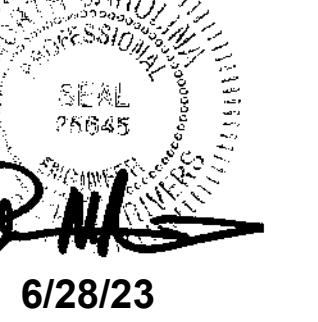

CORPORATE SEAL:



DBA
LAND PLANNING ASSOCIATES OF NC, INC.
110 WEST 1ST AVENUE - SUITE A
EASLEY, SC 29640
864.242.6072
design@pa-inc.net

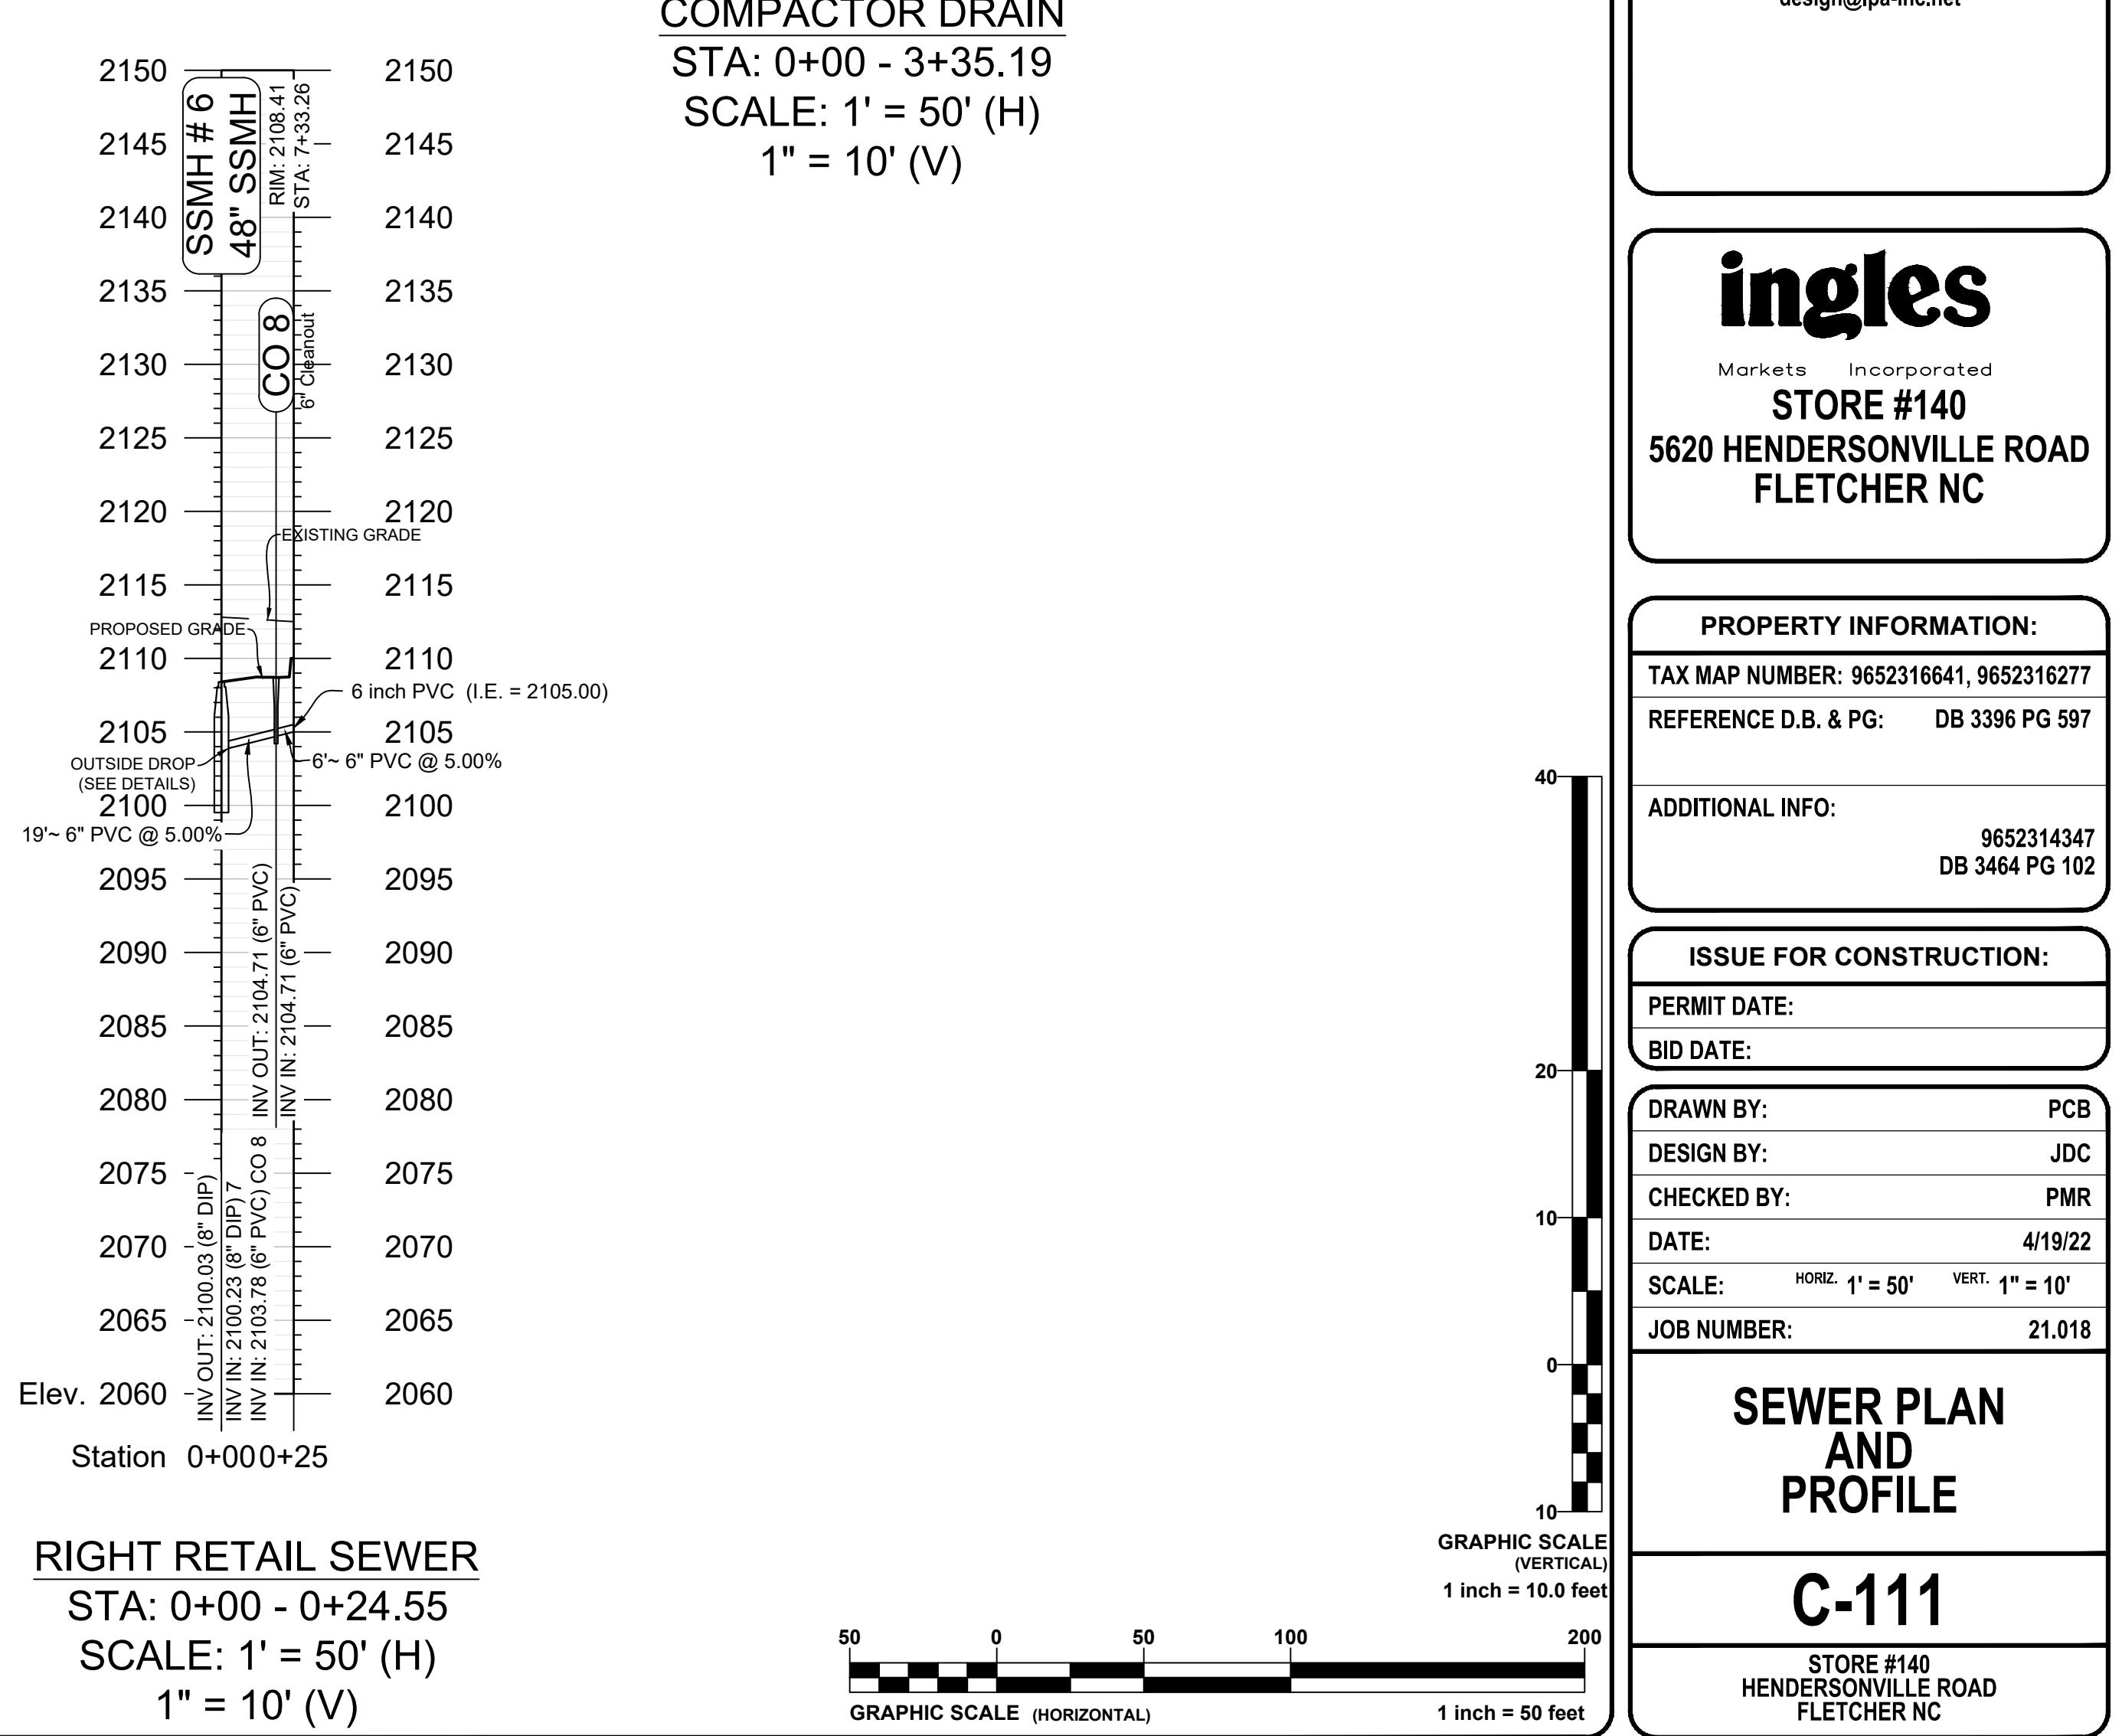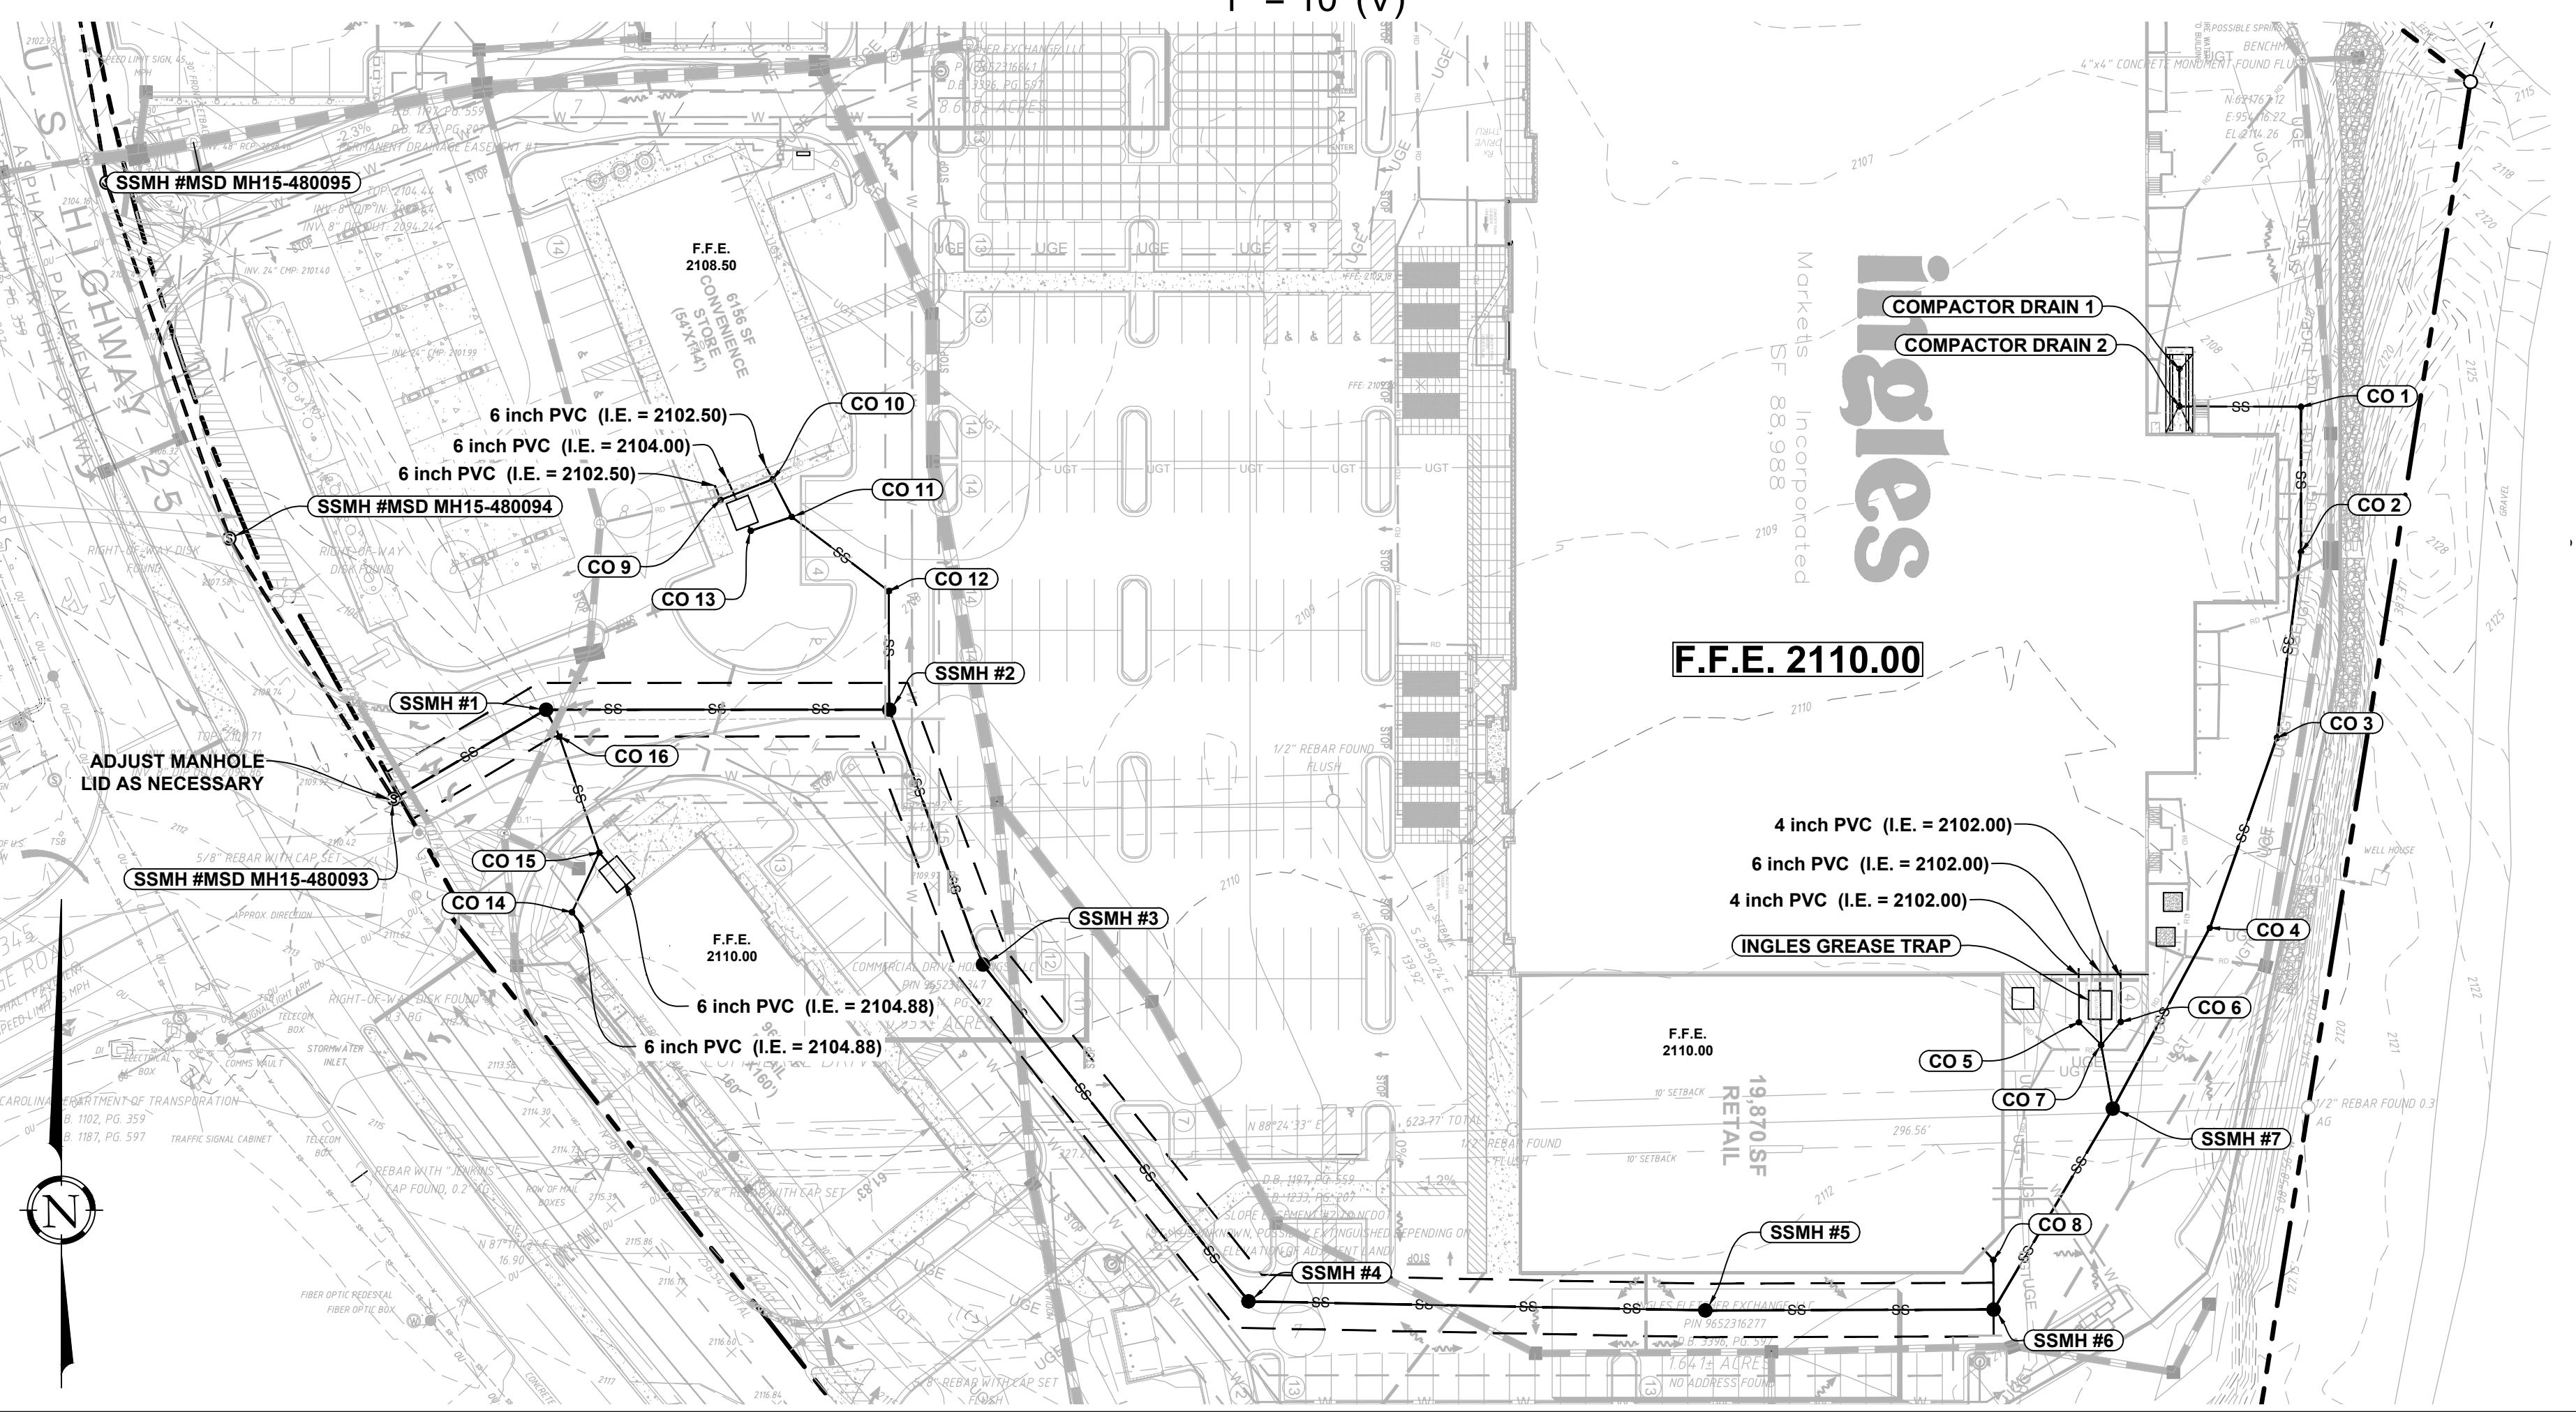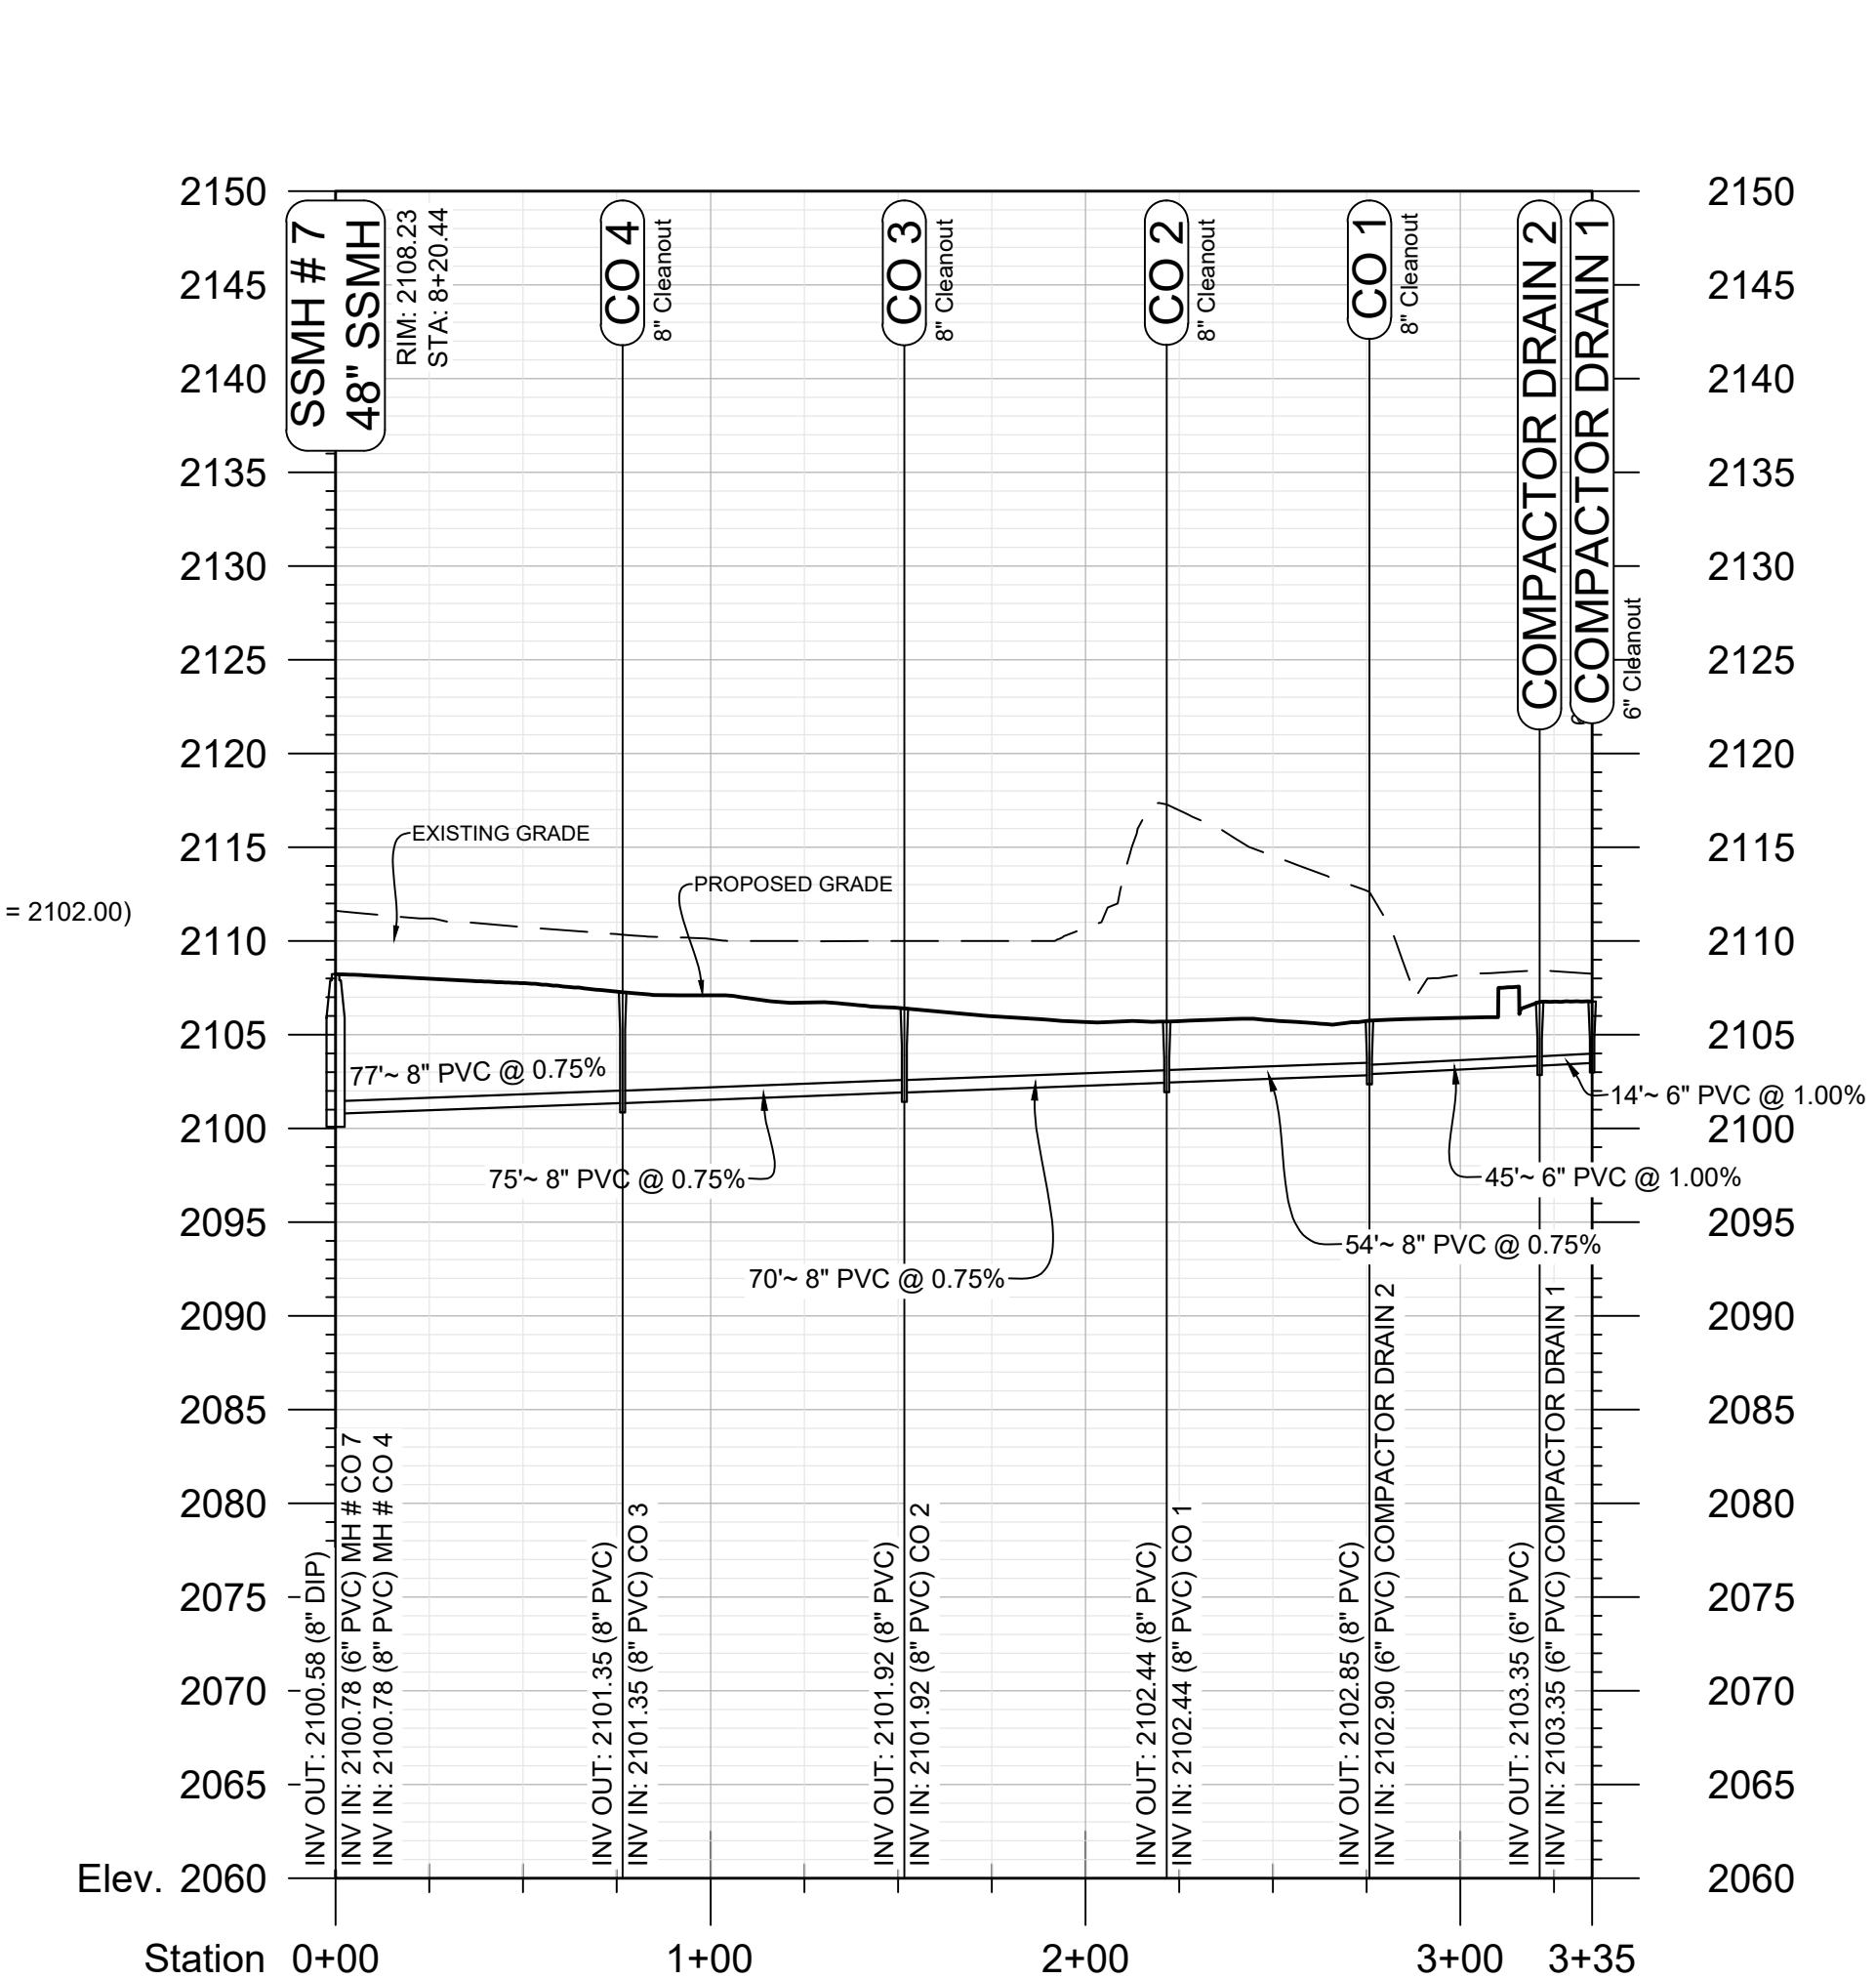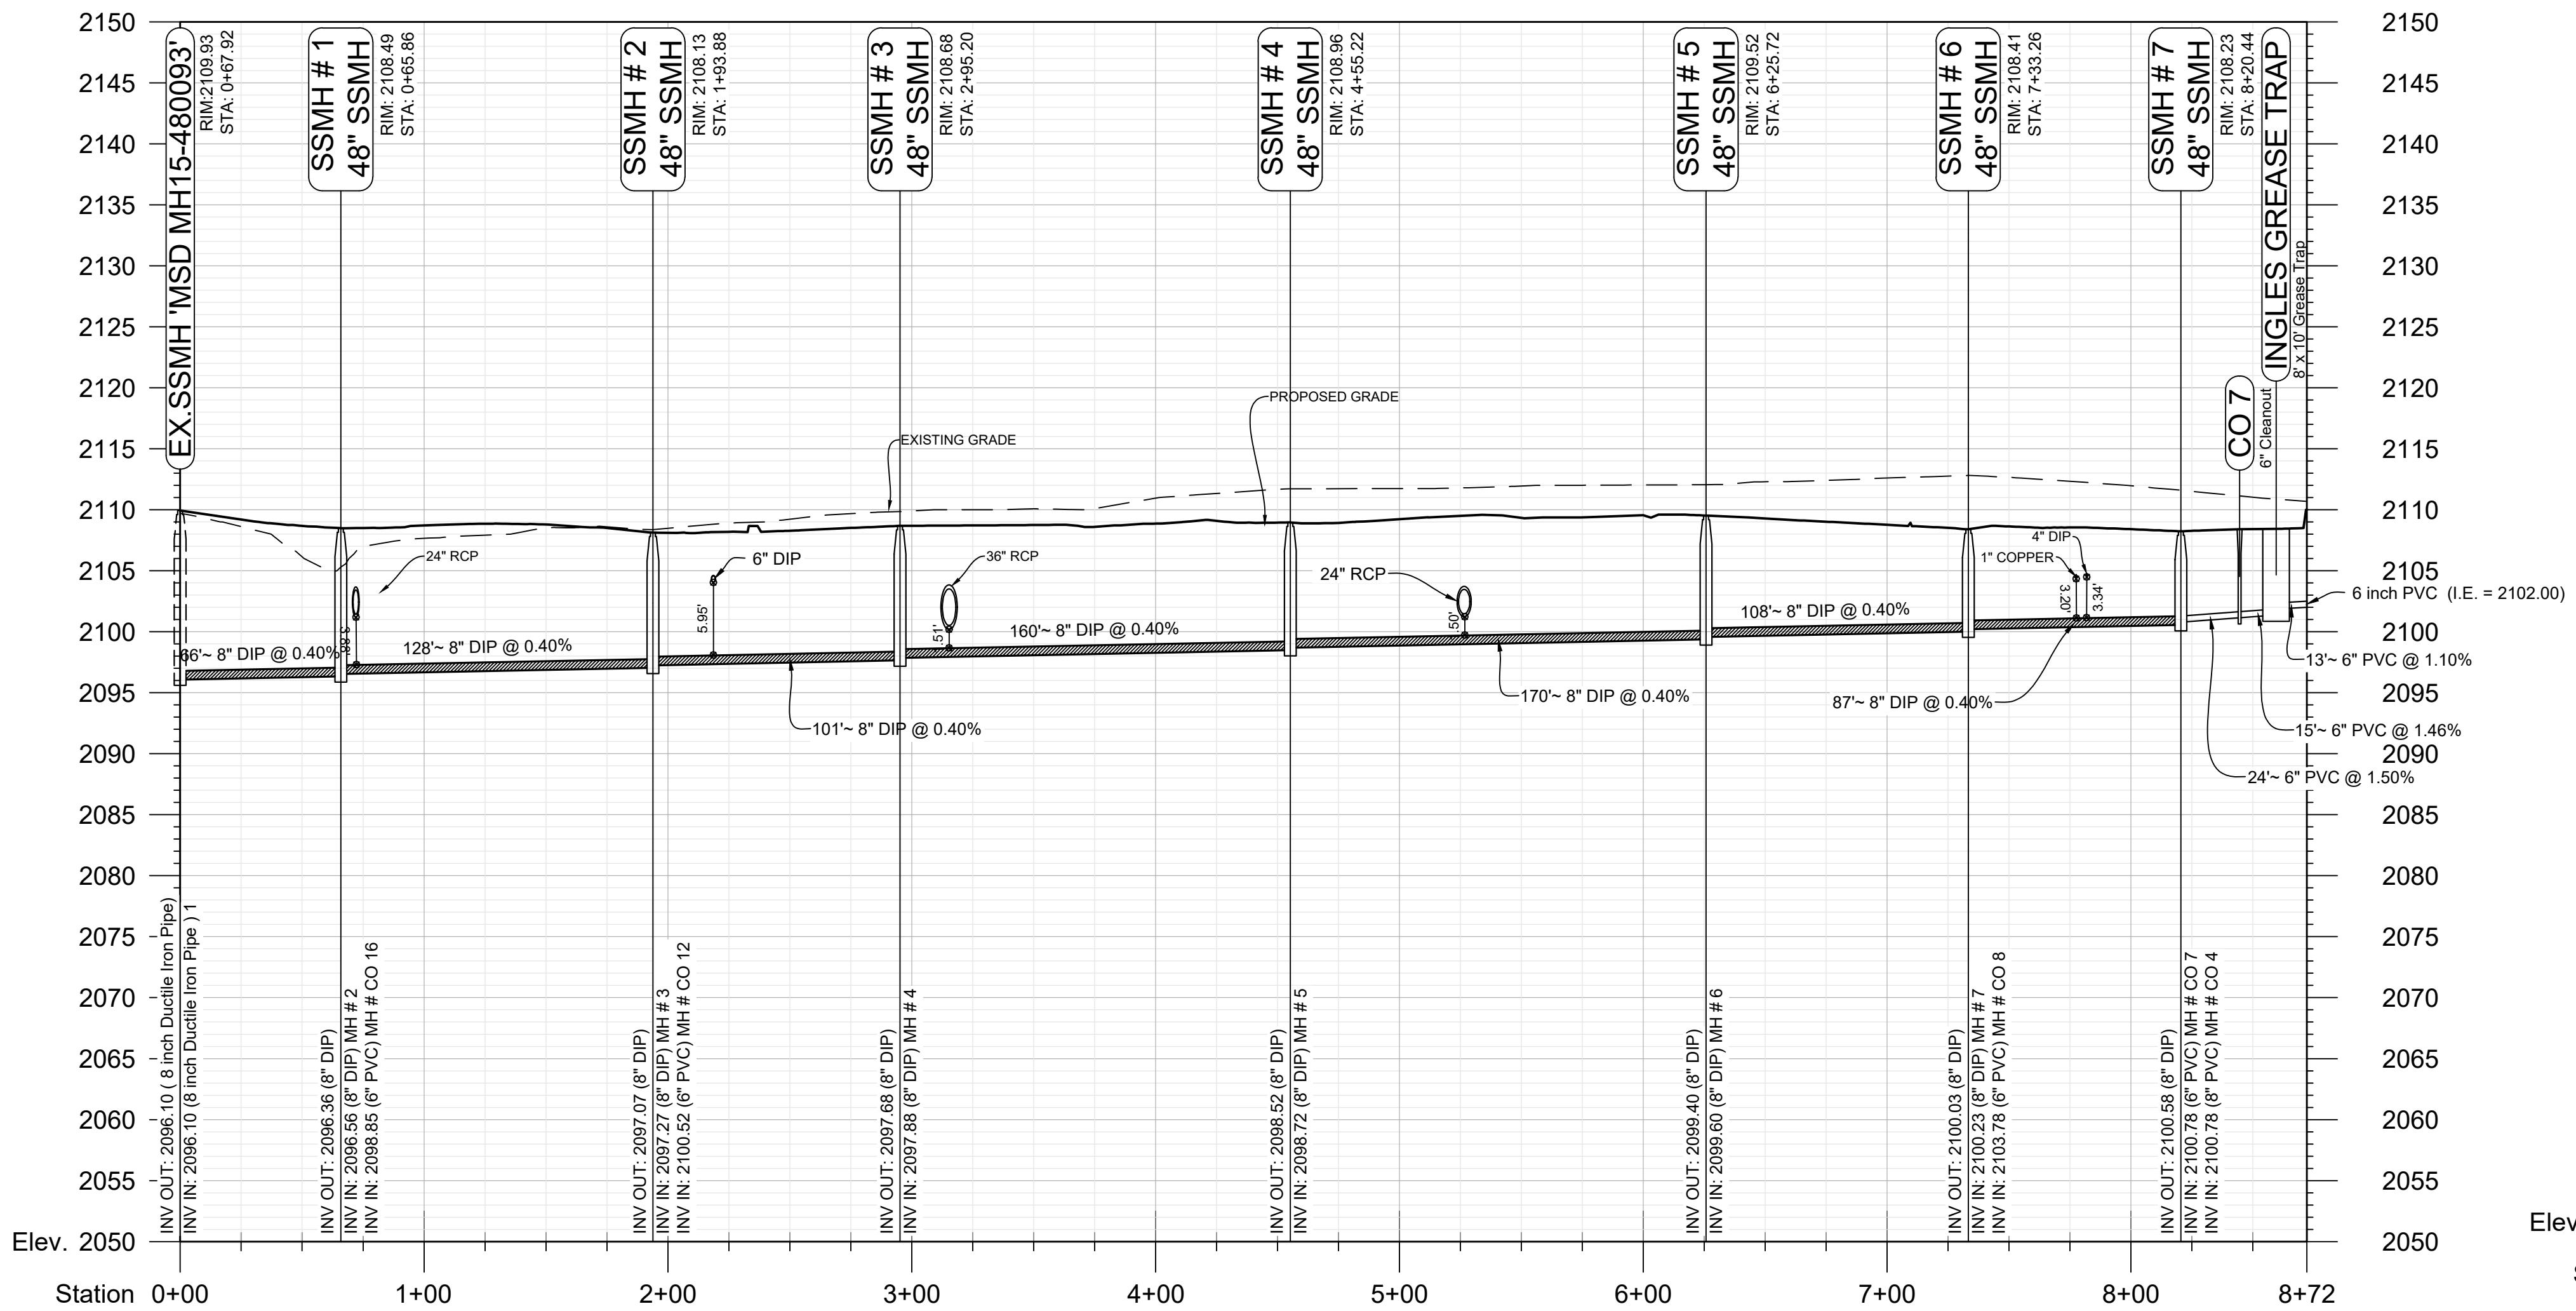

REVISIONS:

NO.	DATE	DESCRIPTION	BY
1	8/26/22	REVISED WATER LAYOUT AND ADDED RESTAURANT GREASE TRAP	SCW
2	6/28/23	MAJOR REVISION	PCB

SEAL:

6/28/23

CORPORATE SEAL:



DBA
LAND PLANNING ASSOCIATES OF NC, INC.
110 WEST 1ST AVENUE - SUITE A
EASLEY, SC 29640
864.242.6072
design@pa-inc.net

ingles

Markets Incorporated
STORE #140
5620 HENDERSONVILLE ROAD
FLETCHER NC

PROPERTY INFORMATION:
TAX MAP NUMBER: 9652316641, 9652316277
REFERENCE D.B. & PG: DB 3396 PG 597

ADDITIONAL INFO:
9652314347
DB 3464 PG 102



ISSUE FOR CONSTRUCTION:
PERMIT DATE:
BID DATE:

DRAWN BY: PCB
DESIGN BY: JDC
CHECKED BY: PMR
DATE: 4/19/22
SCALE: HORIZ. 1' = 50' VERT. 1' = 10'
JOB NUMBER: 21.018


**SEWER PLAN
AND
PROFILE**

C-112


STORE #140
HENDERSONVILLE ROAD
FLETCHER NC

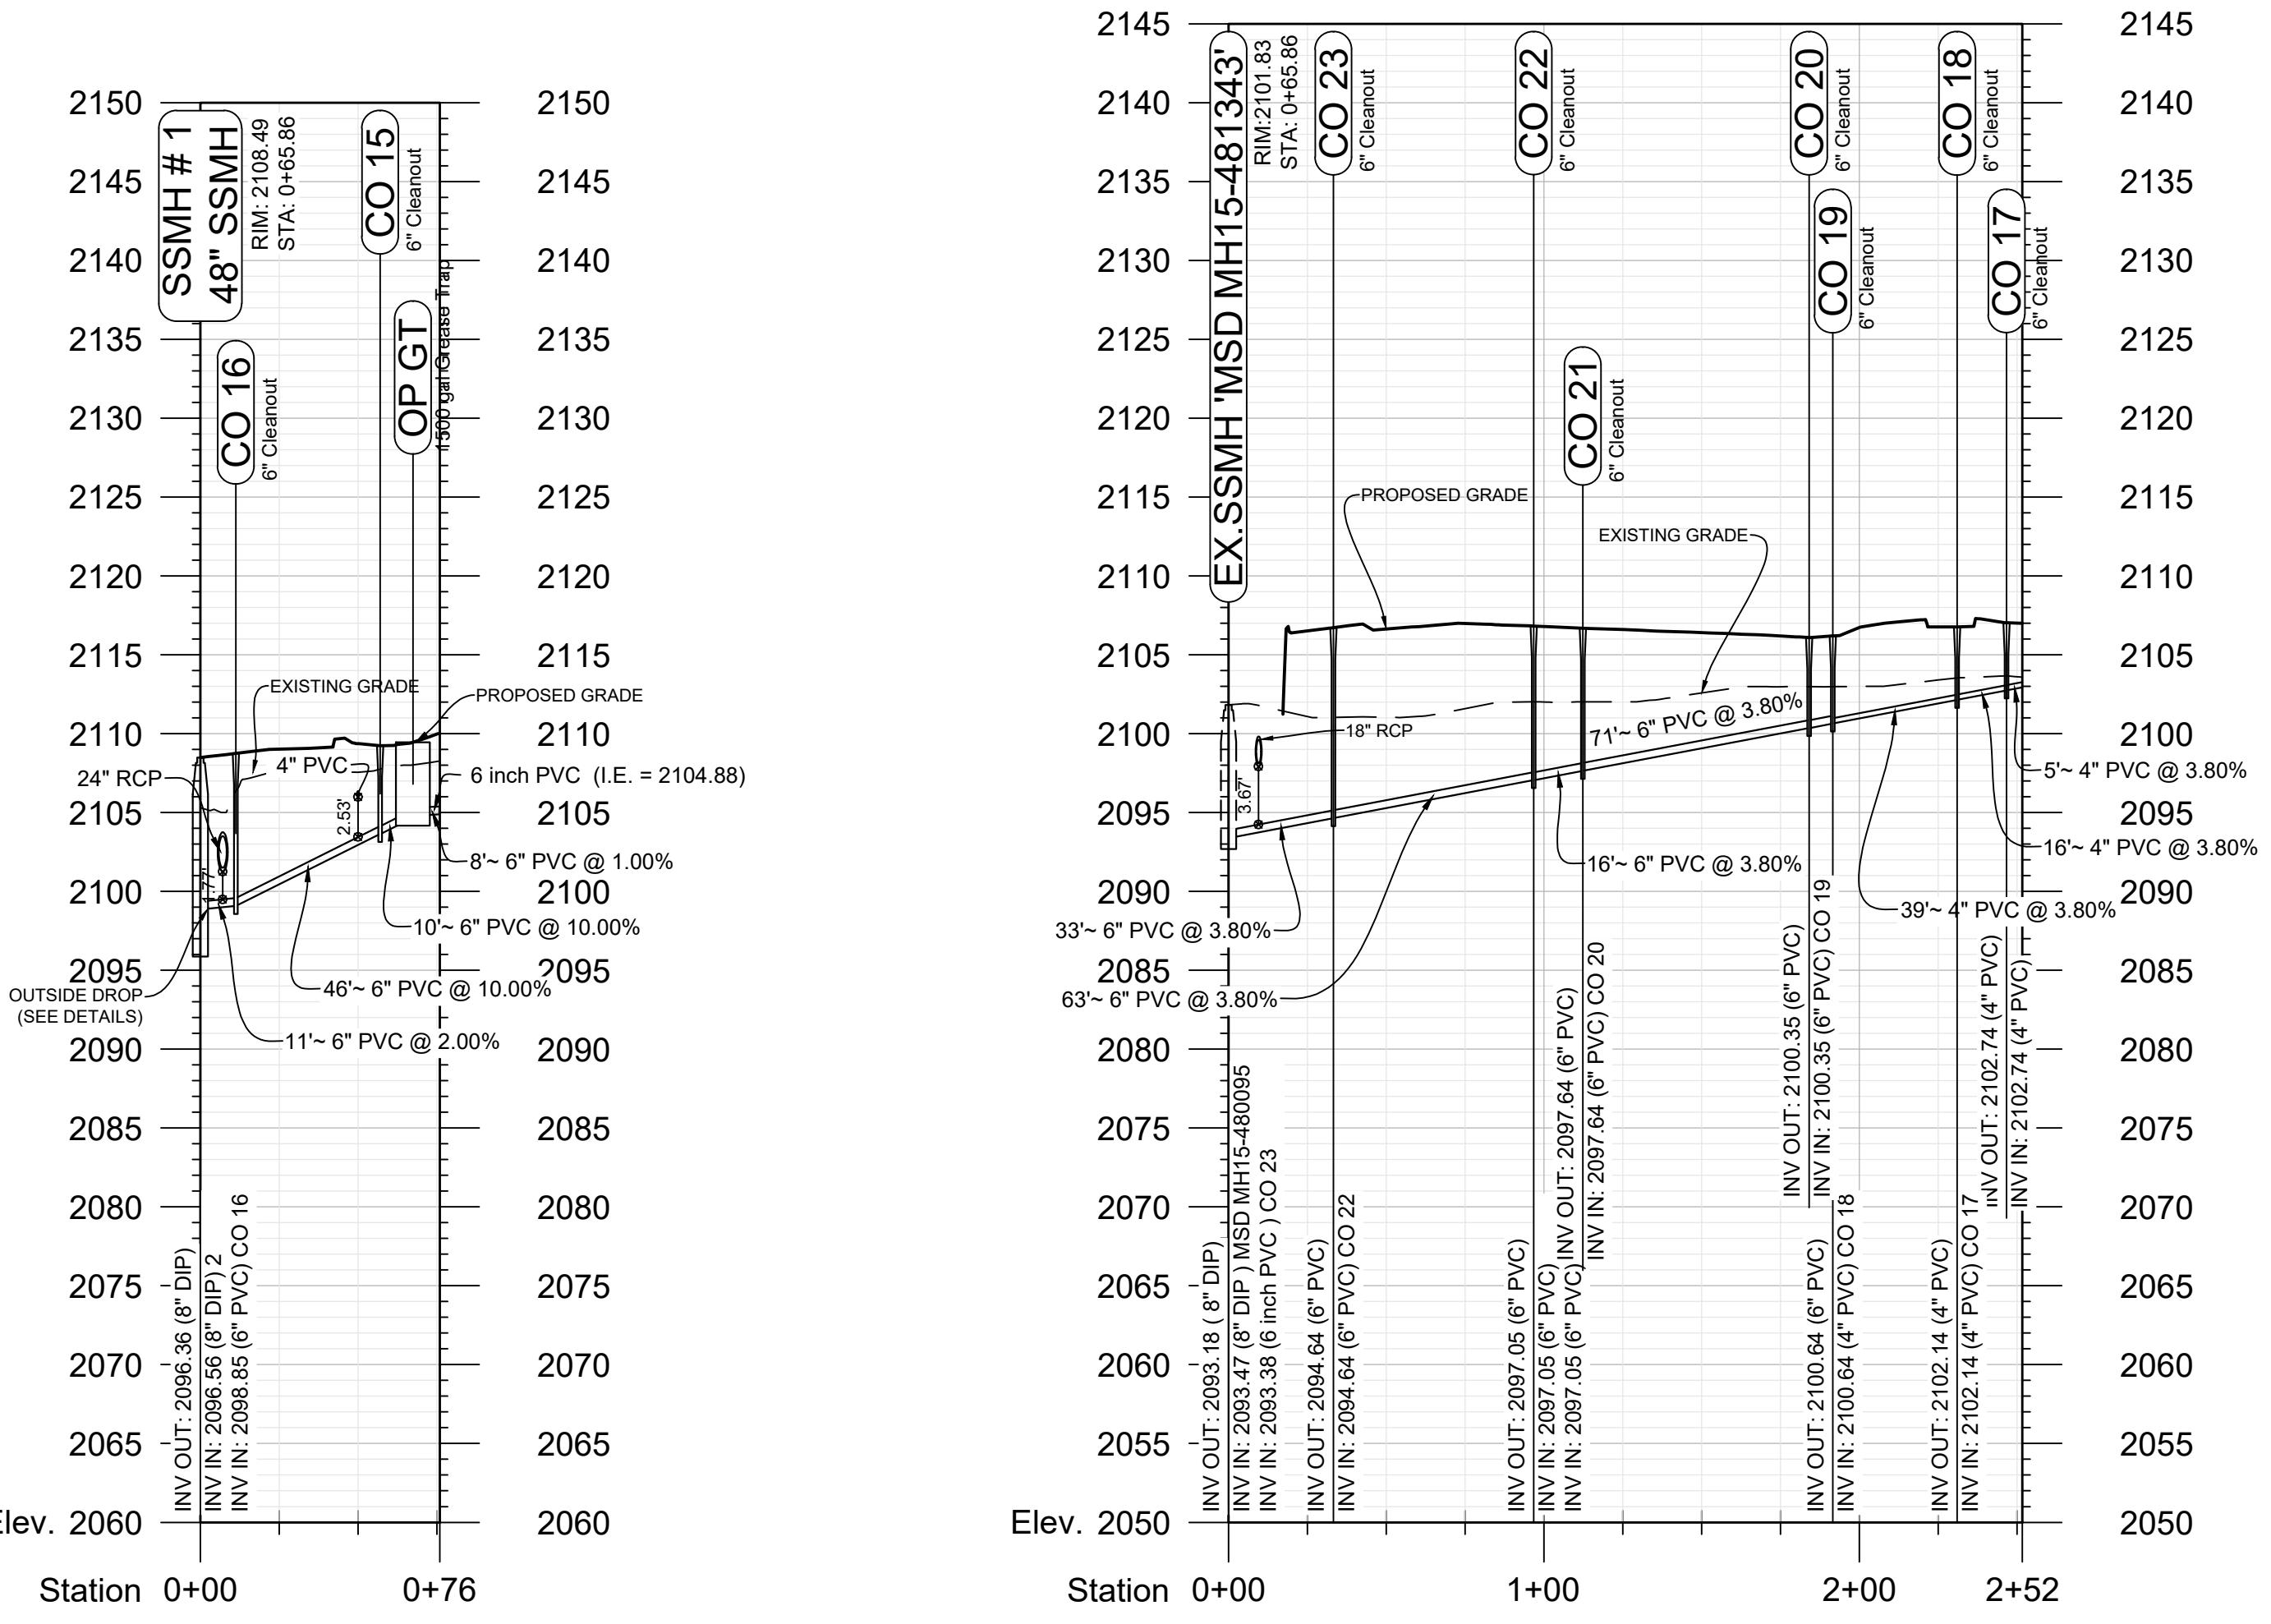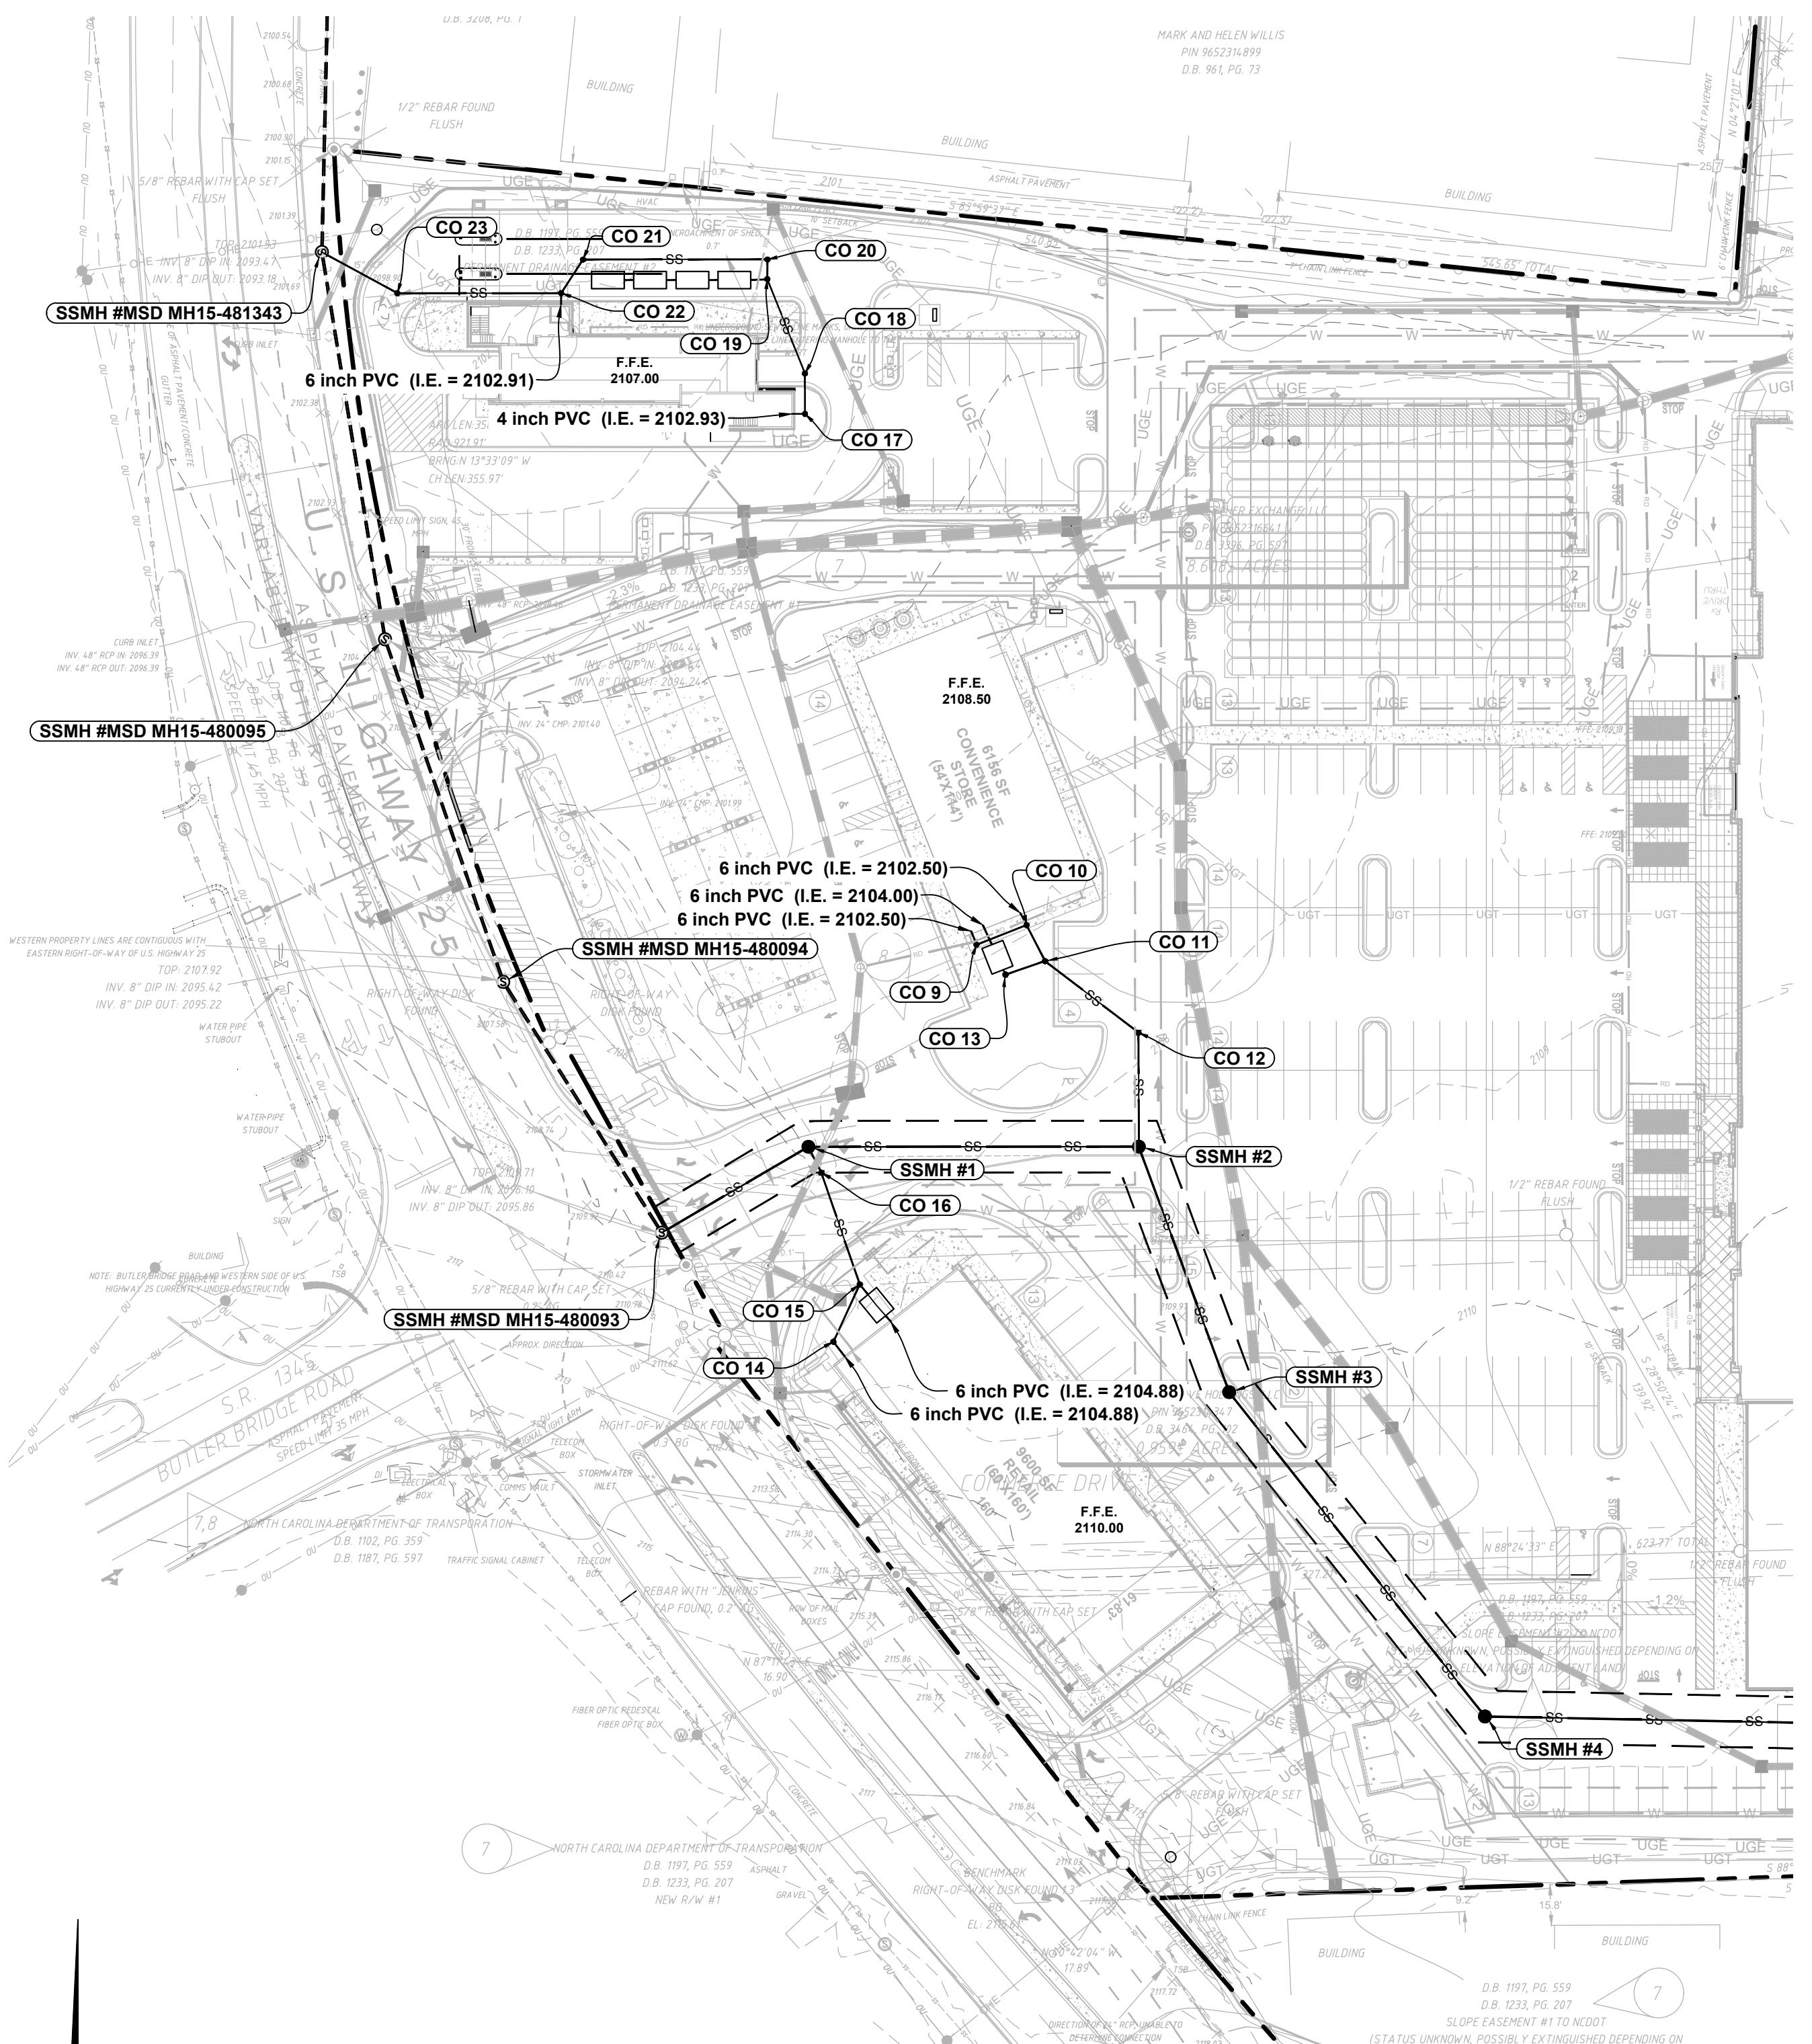

OUTPARCEL RETAIL SEWER
STA: 0+00 - 0+75.88
SCALE: 1' = 50' (H)
1" = 10' (V)

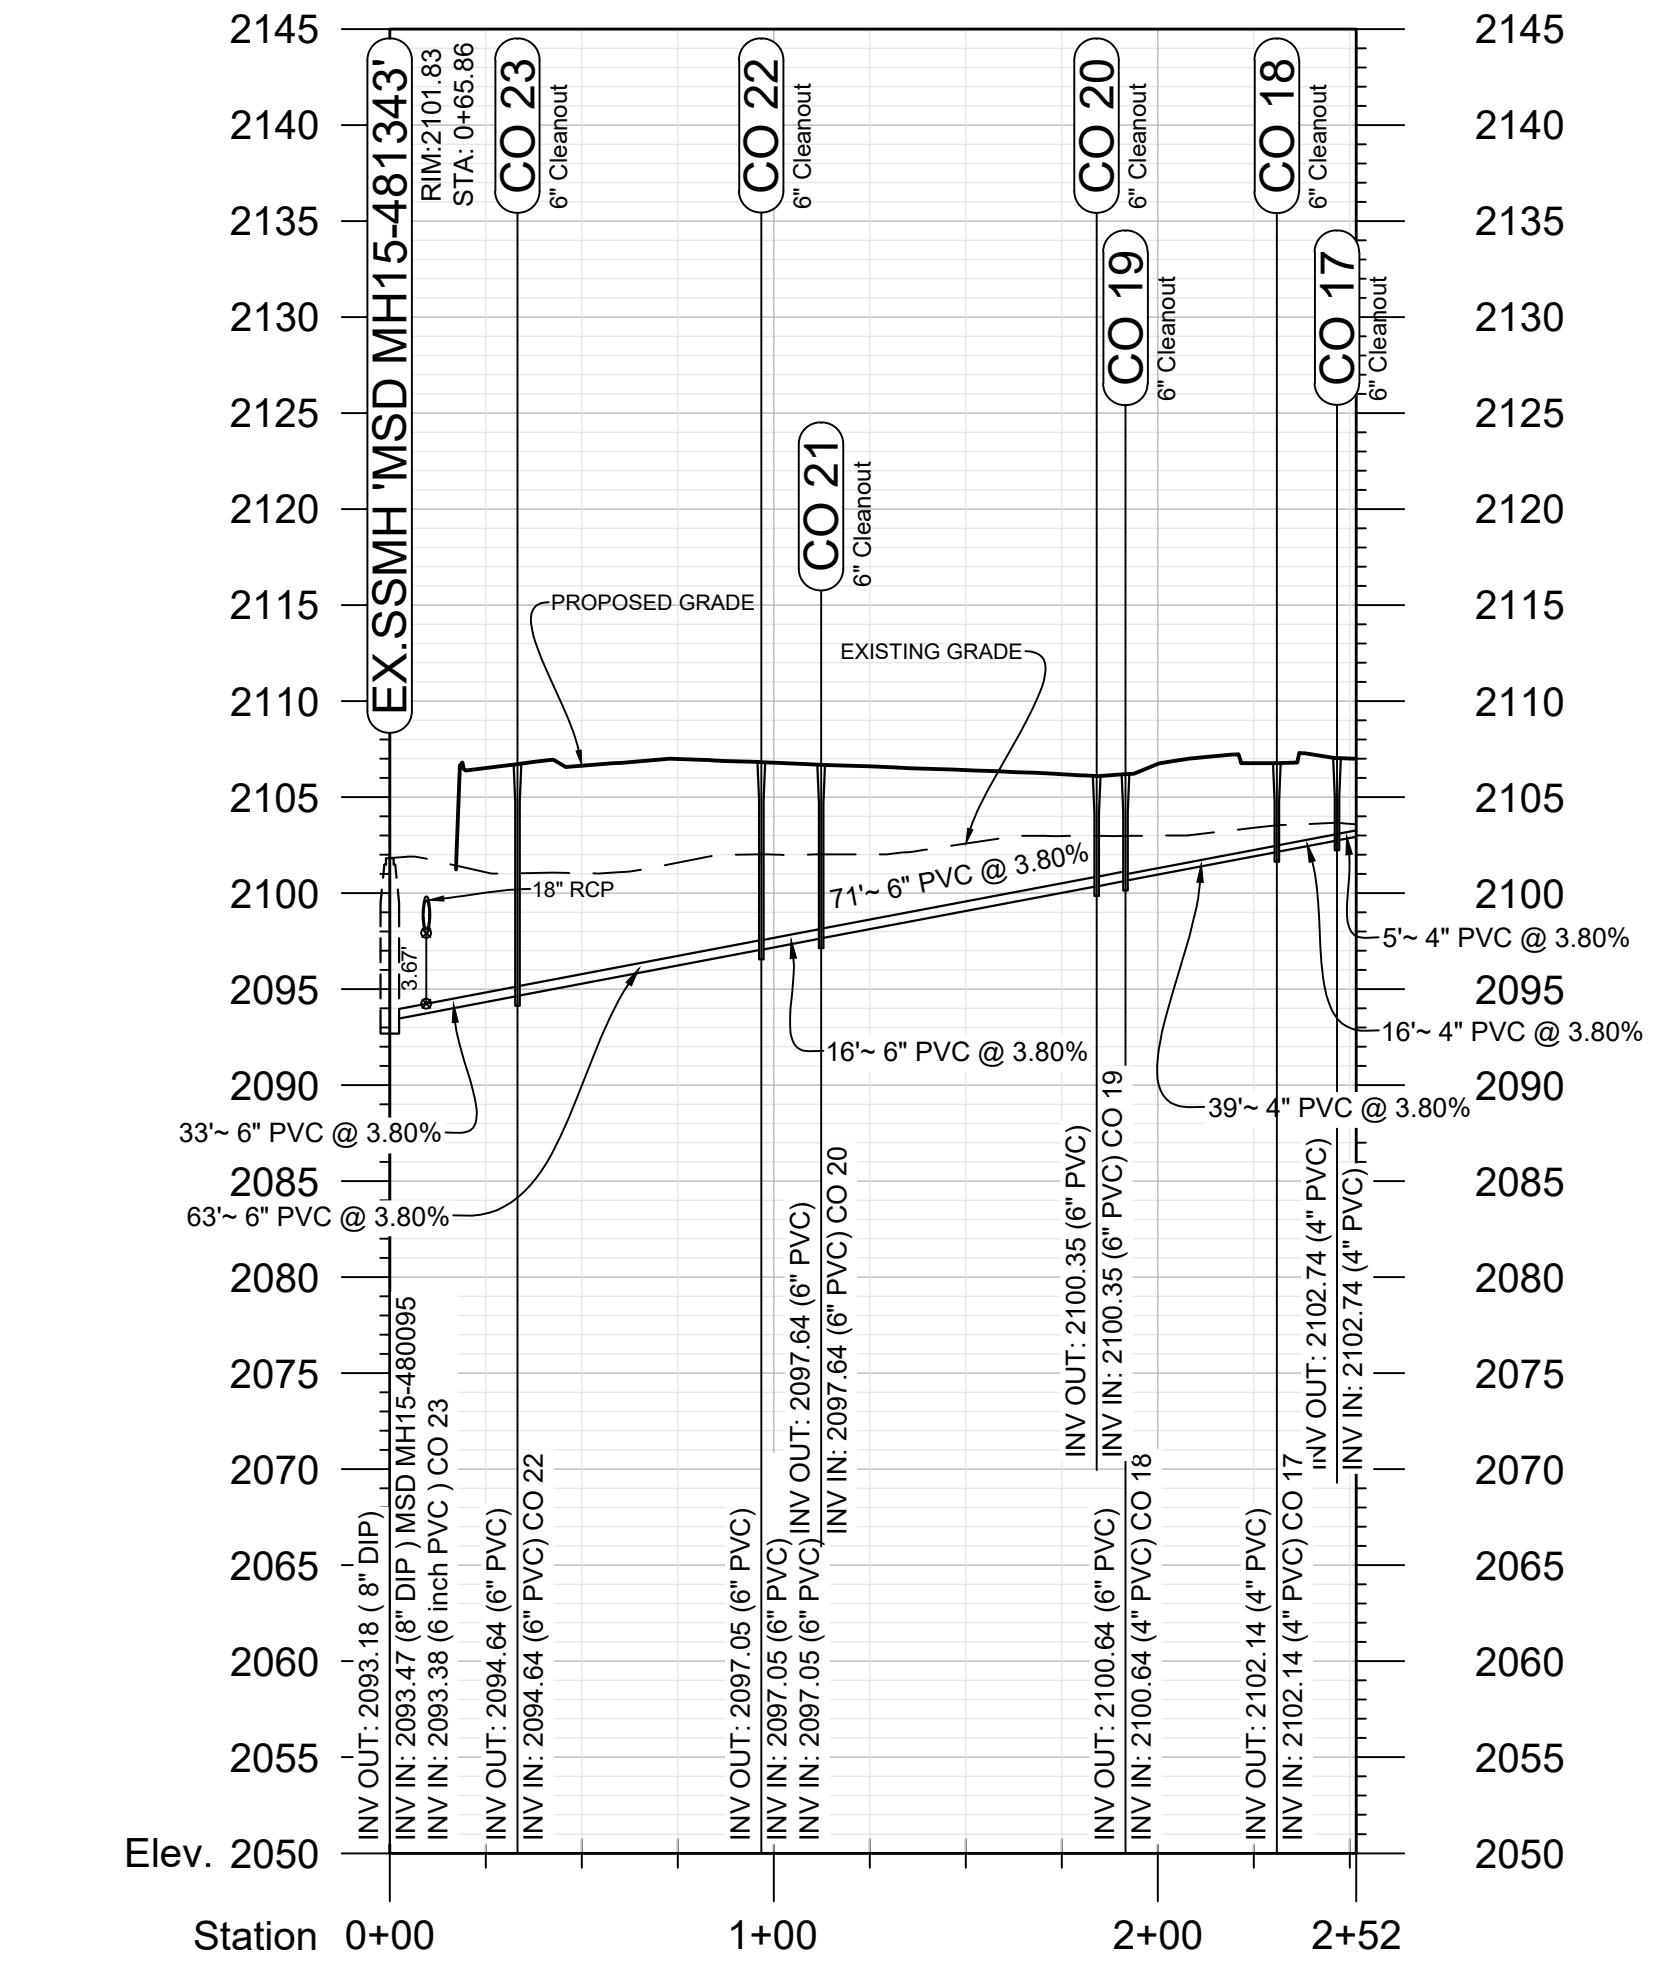


ZIPS SEWER
STA: 0+00 - 2+51.70
SCALE: 1' = 50' (H)
1" = 10' (V)

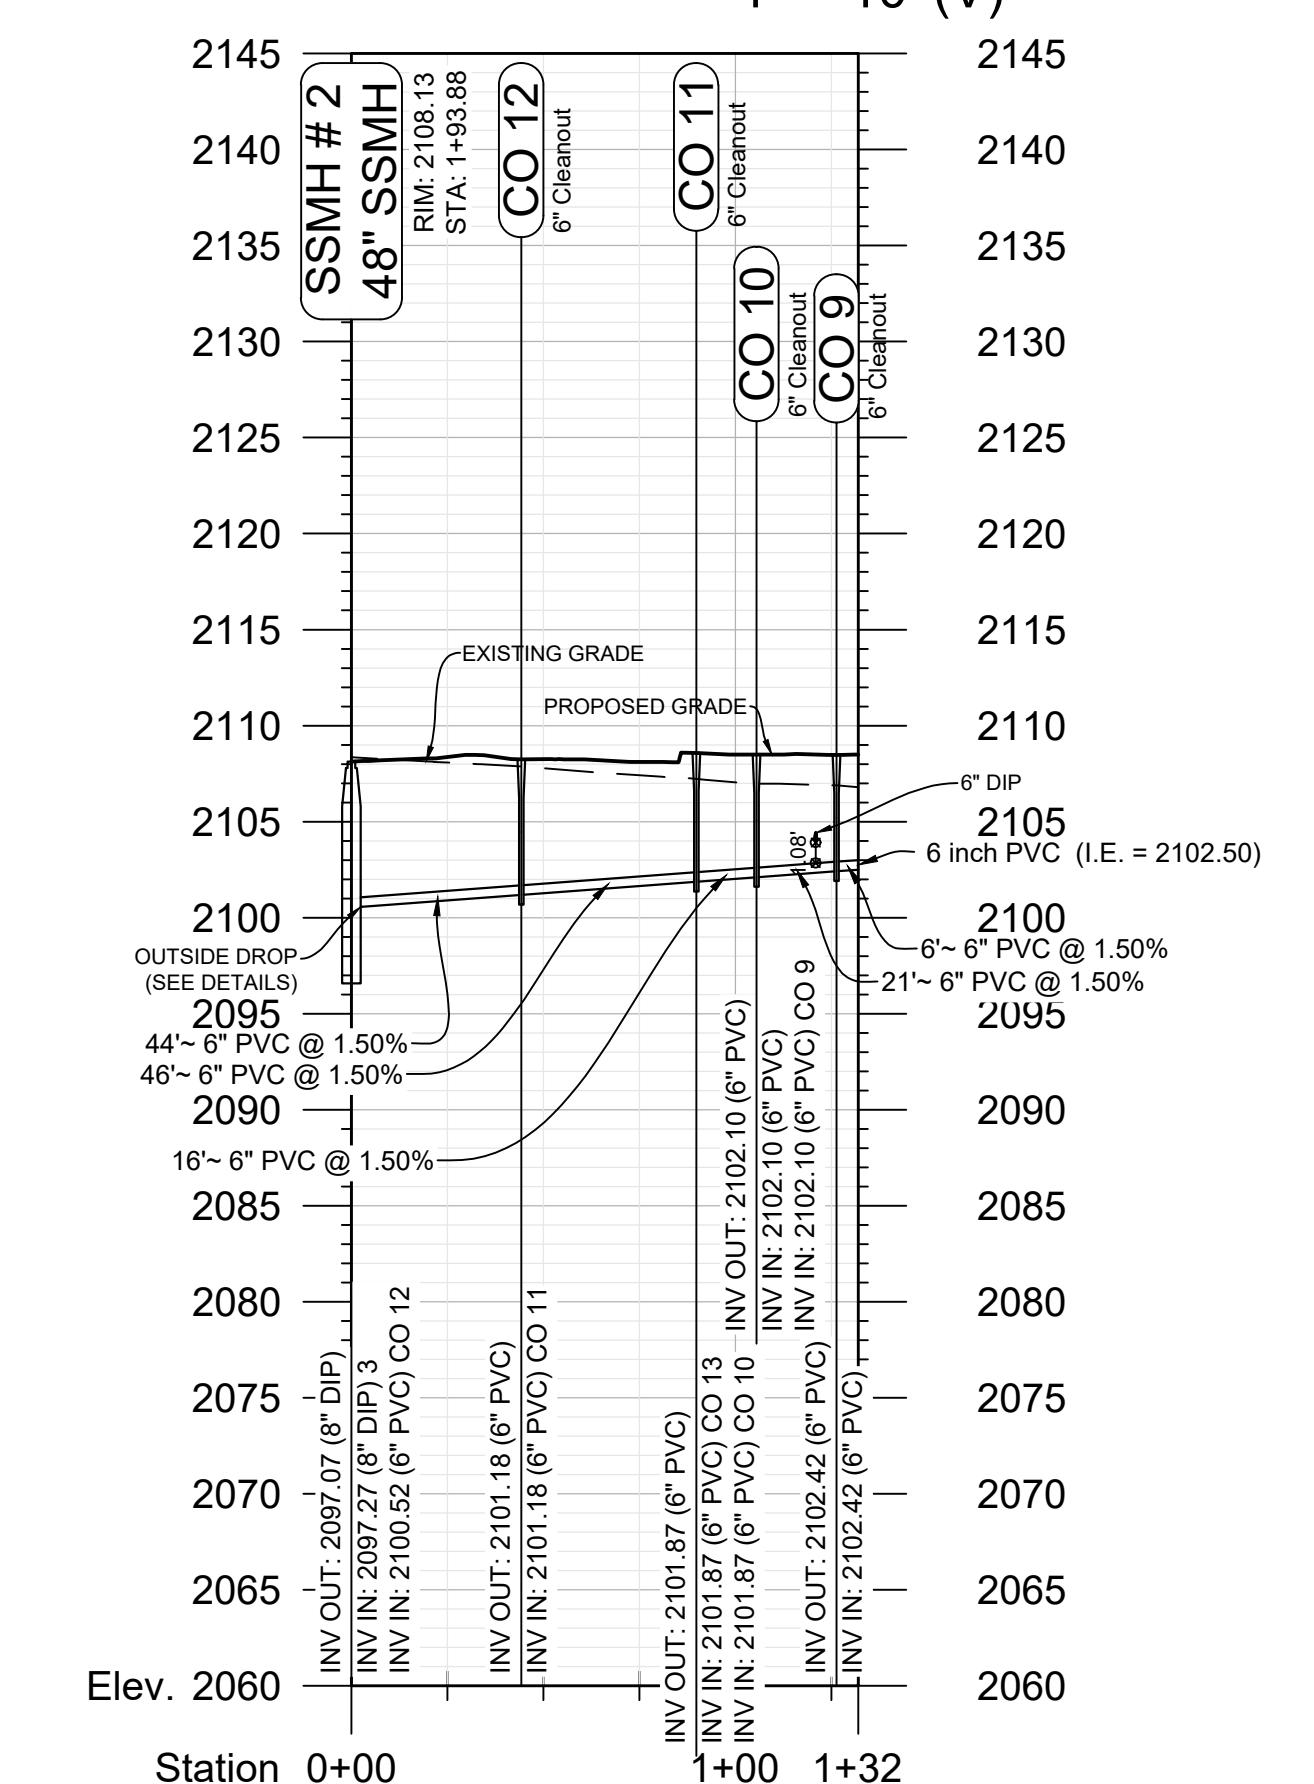

C-STORE SEWER
STA: 0+00 - 1+31.95
SCALE: 1' = 50' (H)
1" = 10' (V)

REVISIONS:

NO.	DATE	DESCRIPTION	BY
1	6/28/23	REVISED DETAILS PER INGLES	JDC

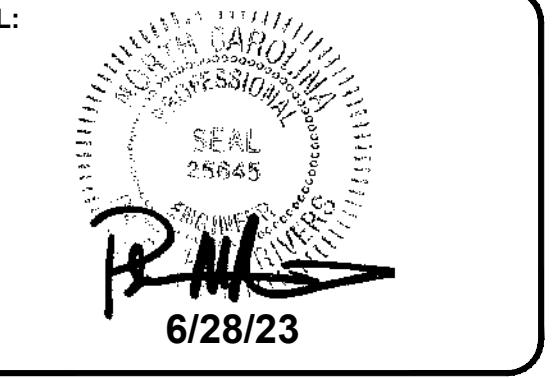

CORPORATE SEAL:



DBA
LAND PLANNING ASSOCIATES OF NC, INC.
110 WEST 1ST AVENUE - SUITE A
EASLEY, SC 29640
864.242.6072 FAX 208.730.8214
design@pa-inc.net





PROPERTY INFORMATION:
TAX MAP NUMBER: 9652316641, 9652316277
REFERENCE D.B. & PG: DB 3396 PG 597


ADDITIONAL INFO:
9652314347
DB 3464 PG 102

ISSUE FOR CONSTRUCTION:
PERMIT DATE:
BID DATE:
DRAWN BY: PCB
DESIGN BY: JDC
CHECKED BY: JDC
DATE: 4/19/22
SCALE: HORZ. VERT.
JOB NUMBER: 21.018

SITE DETAILS
C-113
STORE #140
HENDERSONVILLE RD
FLETCHER NC

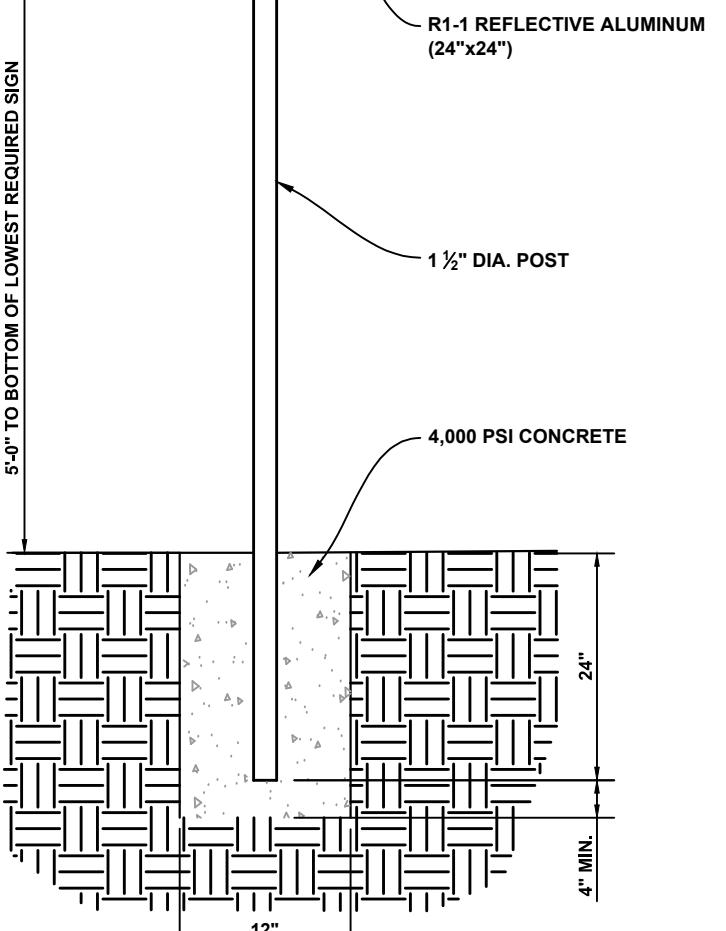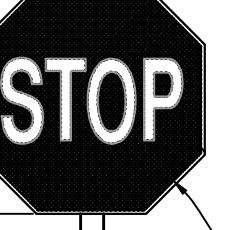


STOP SIGN DETAIL

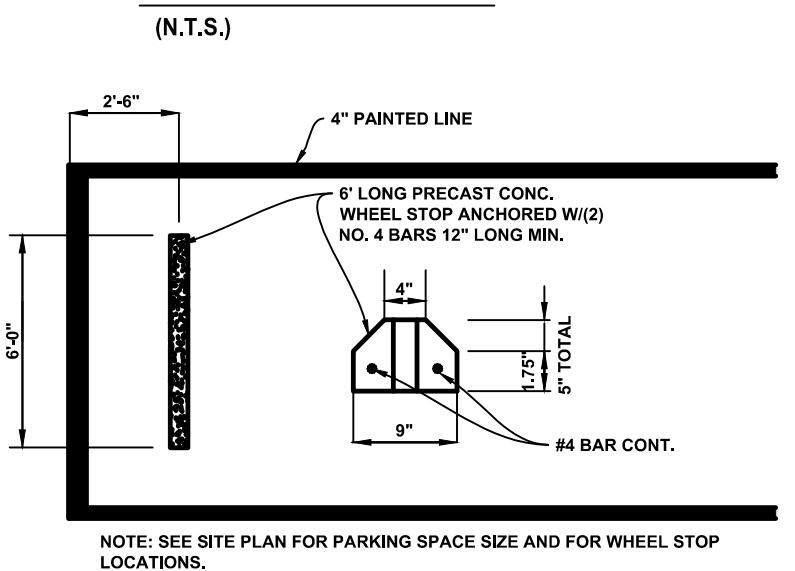


CONCRETE WHEEL STOP


NOTE: 1. #4 GRADE 60 REBAR
2. CONCRETE MINIMUM 6000PSI @28 DAYS
3. TOTAL WEIGHT 210 LBS MINIMUM

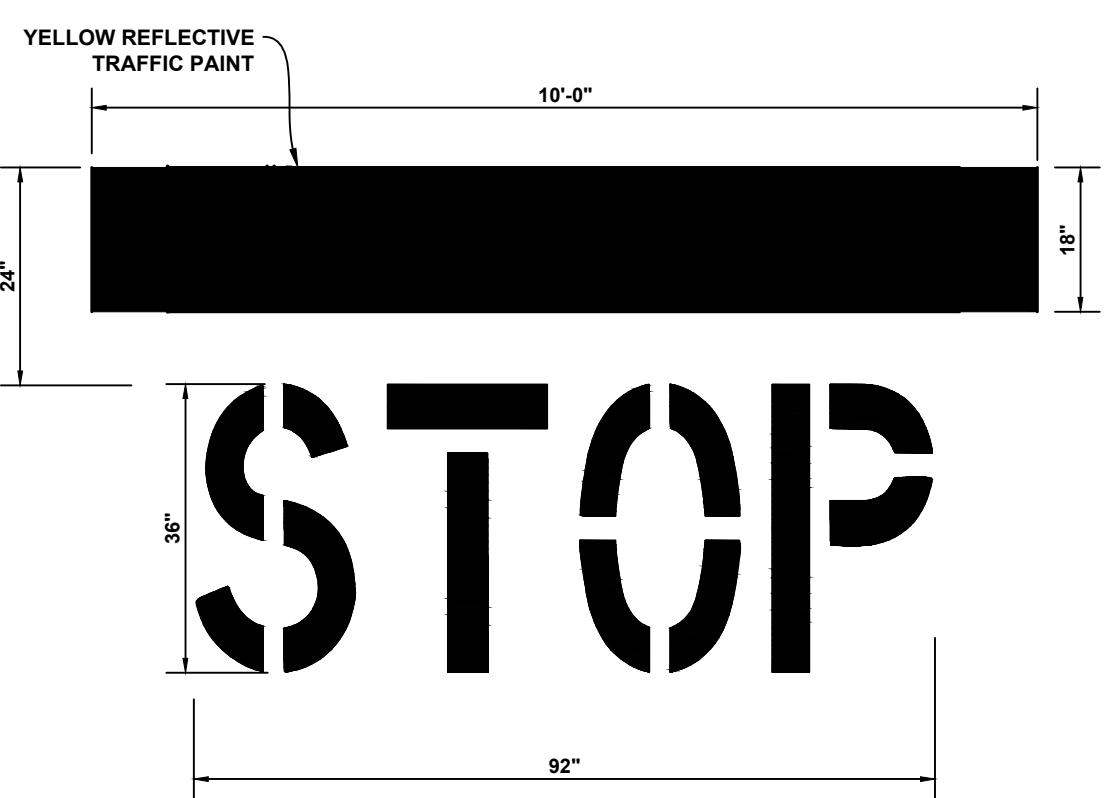

TYPICAL STOP BAR PAVEMENT MARKINGS

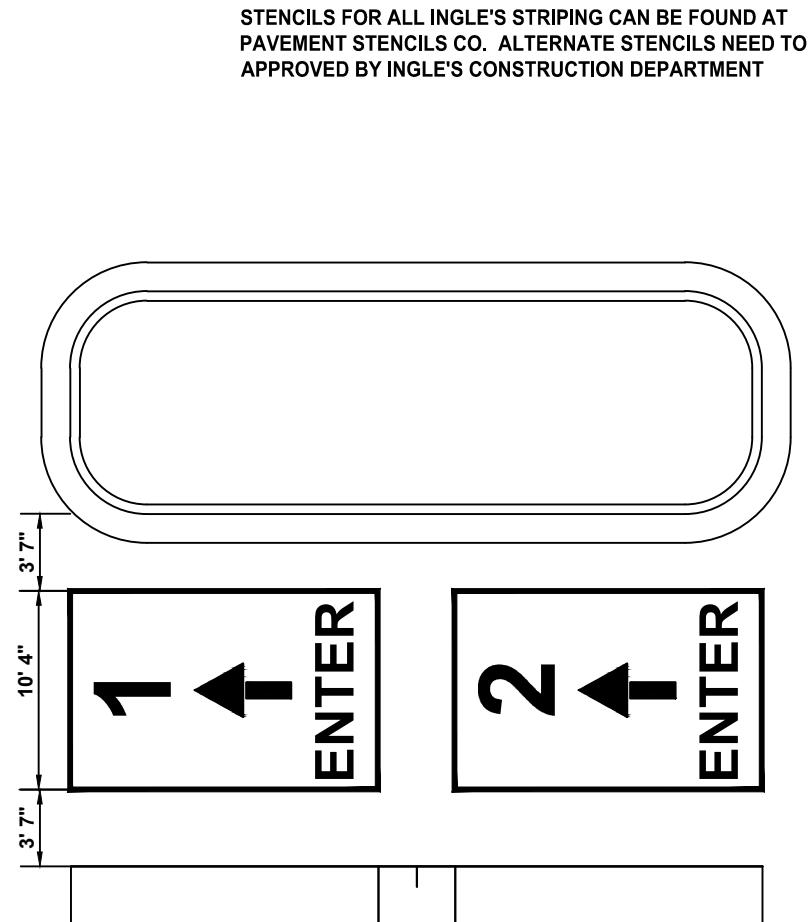


CUSTOMER PICKUP

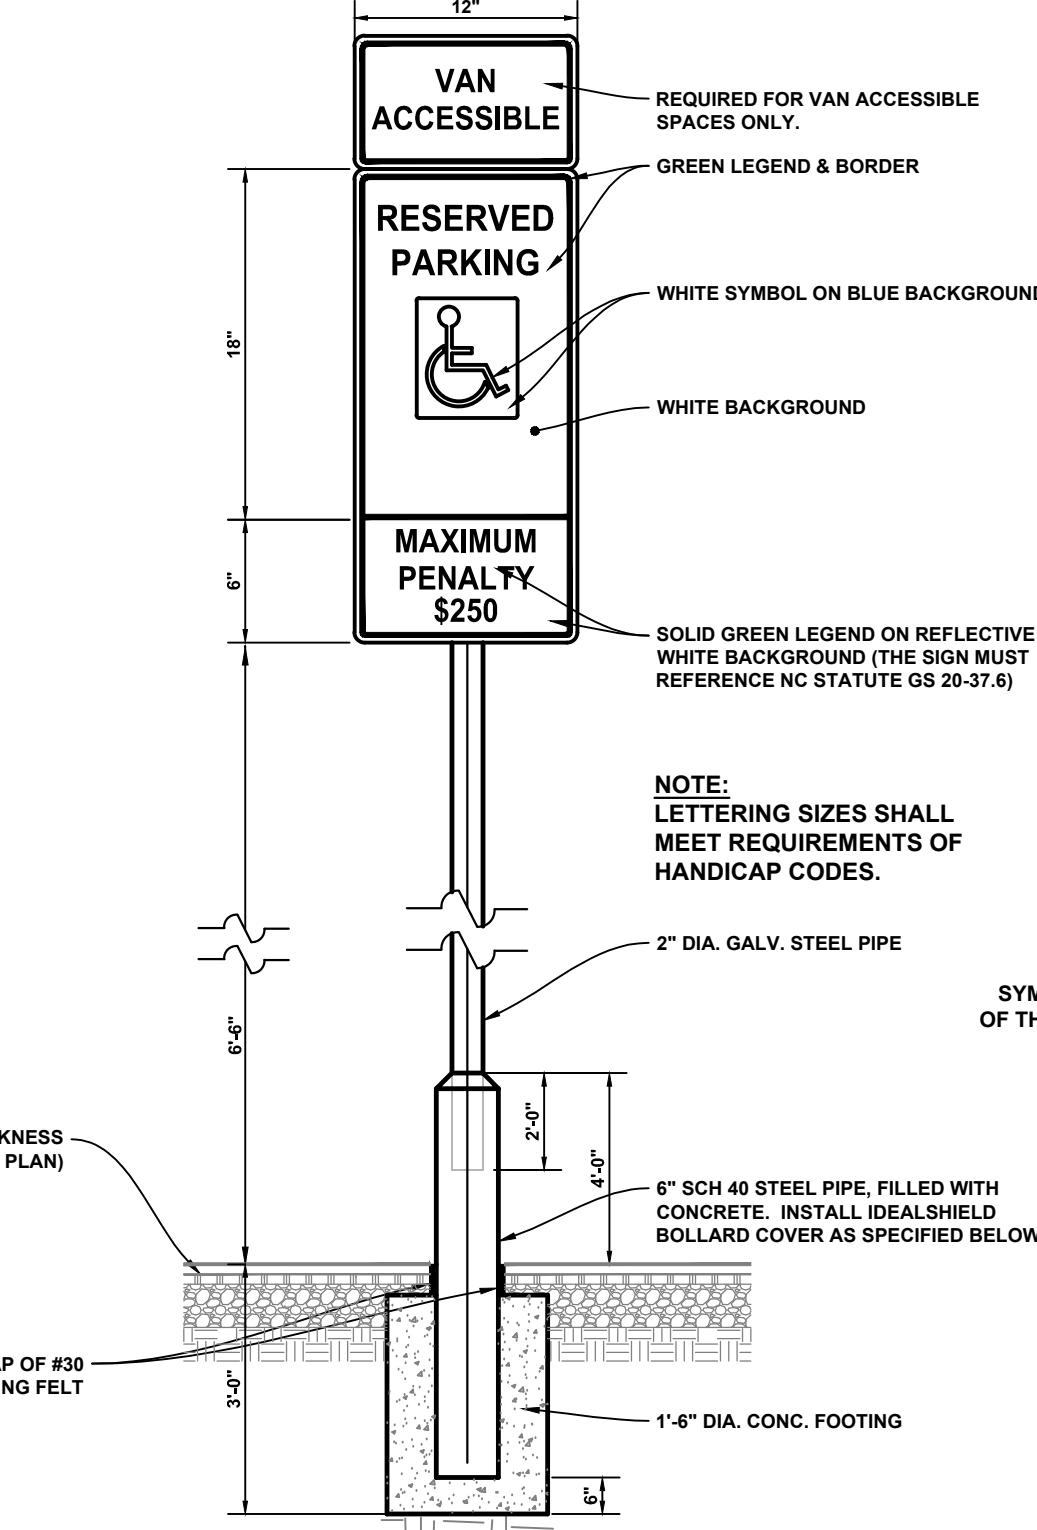


HANDICAP SIGN

NOTE: SIGN MUST MEET MUTCD R7-8 REQUIREMENTS
IDEAL SHIELD BOLLARD COVER NOTES:
• USE 1/4" NOMINAL THICK LOW-DENSITY POLYETHYLENE THERMOPLASTIC(LDPE)
• 6" DIAMETER BOLLARD COVER
• CUT CUSTOM HEIGHT TO 48"
• USE CUSTOM COLOR "ARCH BROWN- G79-2361-M" PART # BPD-06-052-S(50")
• BPD-CC-04-052-S(32")
• CONTACT: ANTONIO RIVER (WORK:239-368-7976)

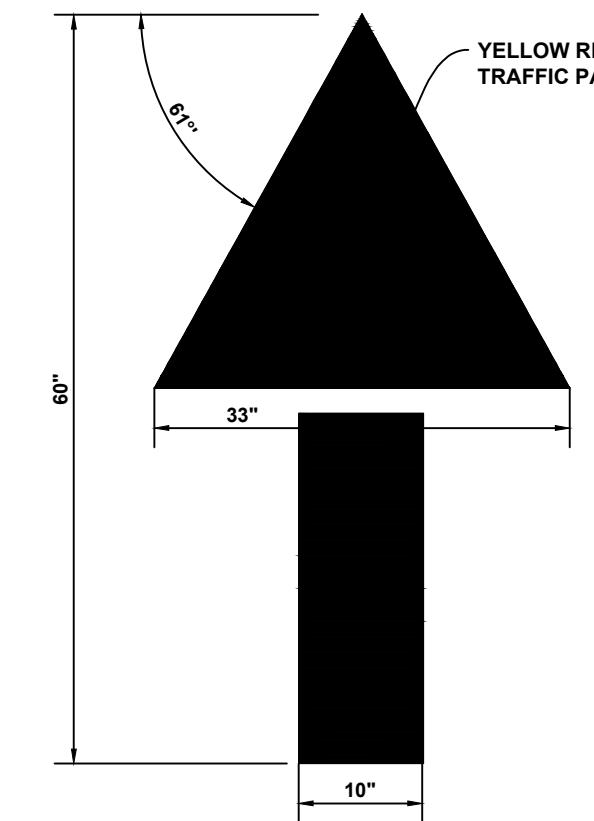


TRAFFIC ARROW

NOTE: STENCILS FOR ALL INGLE'S STRIPING CAN BE FOUND AT PAVEMENT STENCILS CO. ALTERNATE STENCILS NEED TO BE APPROVED BY INGLE'S CONSTRUCTION DEPARTMENT

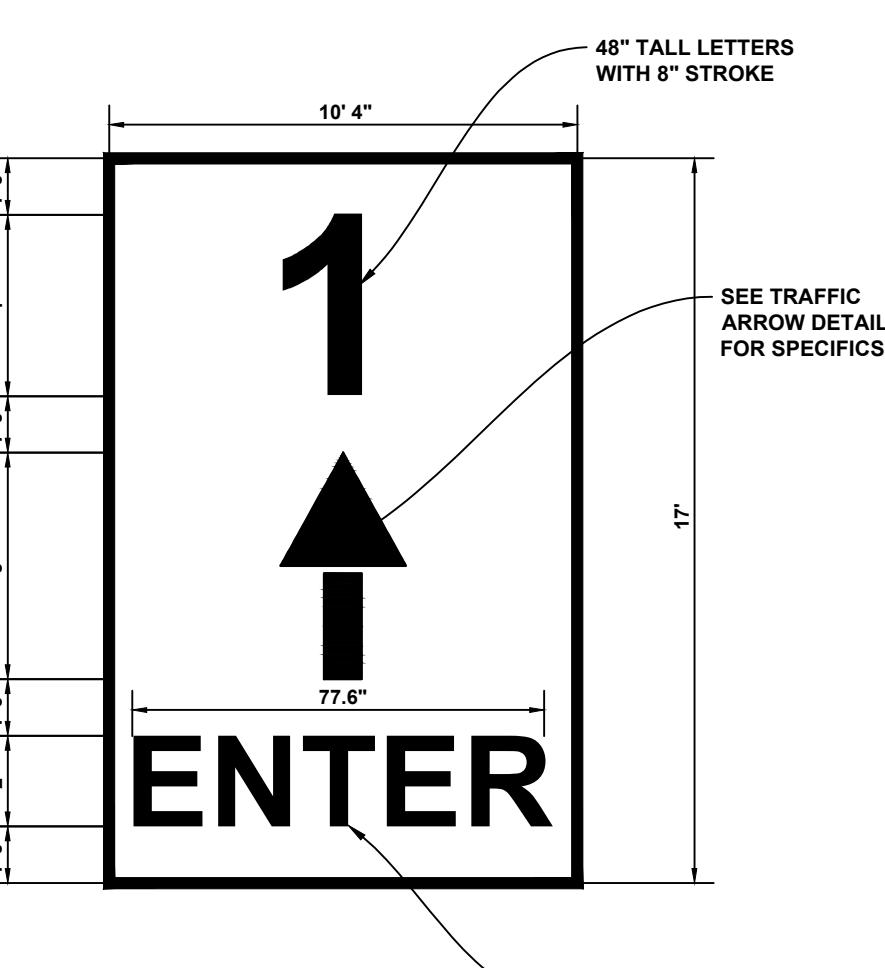


CUSTOMER PICKUP

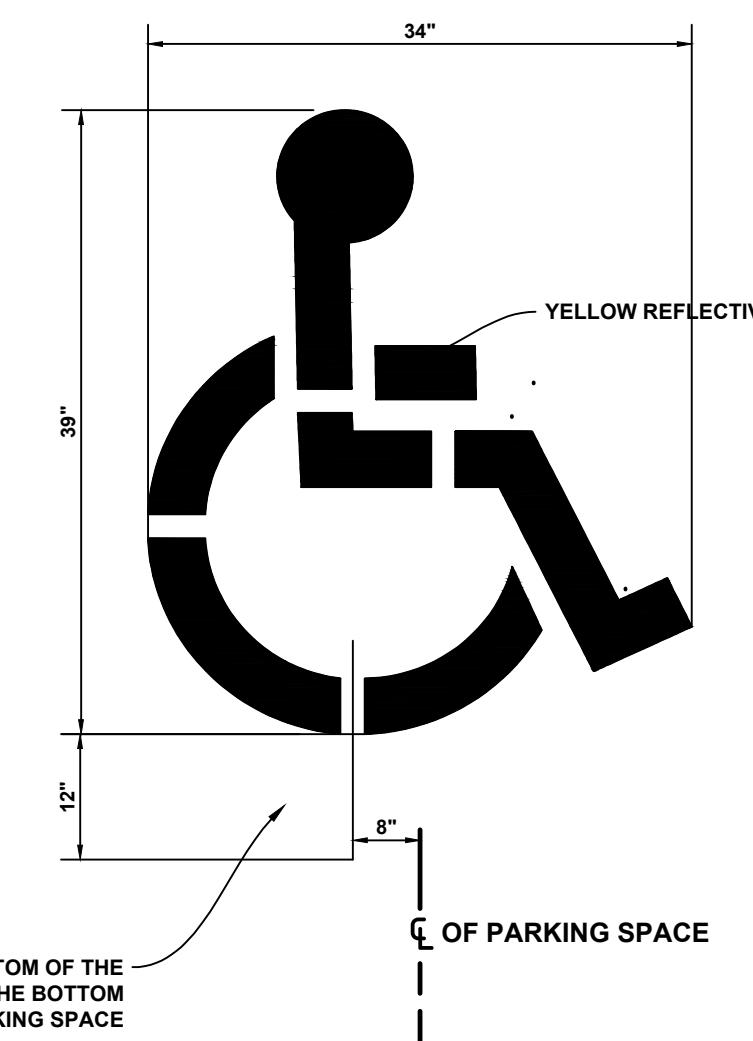

HANDICAP SYMBOL

(N.T.S.)


NOTE: STENCILS FOR ALL INGLE'S STRIPING CAN BE FOUND AT PAVEMENT STENCILS CO. ALTERNATE STENCILS NEED TO BE APPROVED BY INGLE'S CONSTRUCTION DEPARTMENT

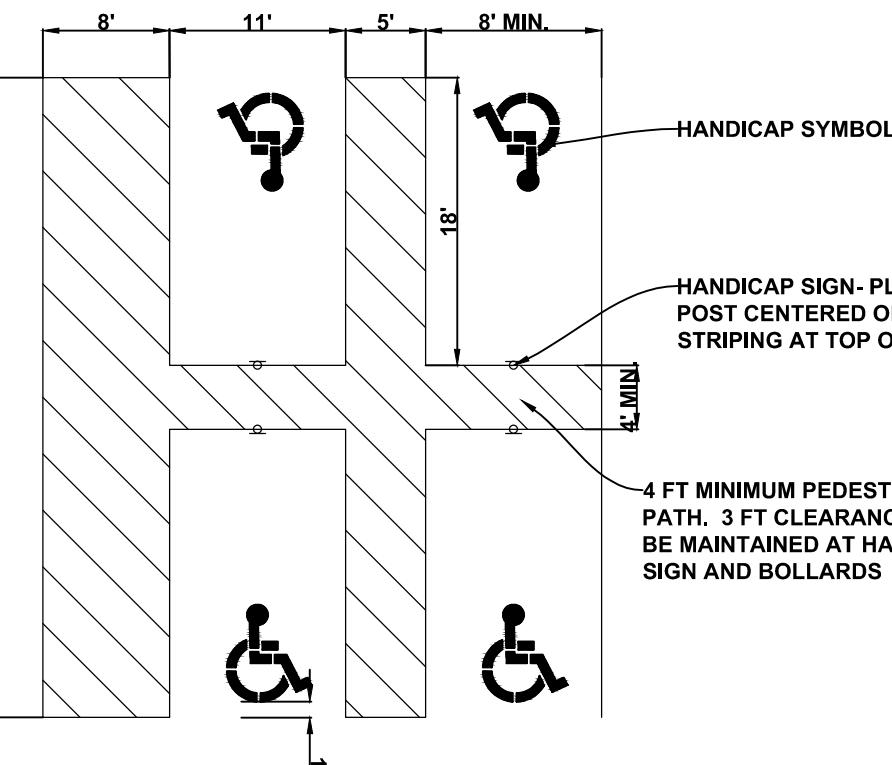

HANDICAP PARKING DETAIL

(N.T.S.)


NOTE: THIS DETAIL IS A TYPICAL AND WILL VARY FROM SITE TO SITE. REFER TO SITE PLAN FOR EXACT LAYOUT

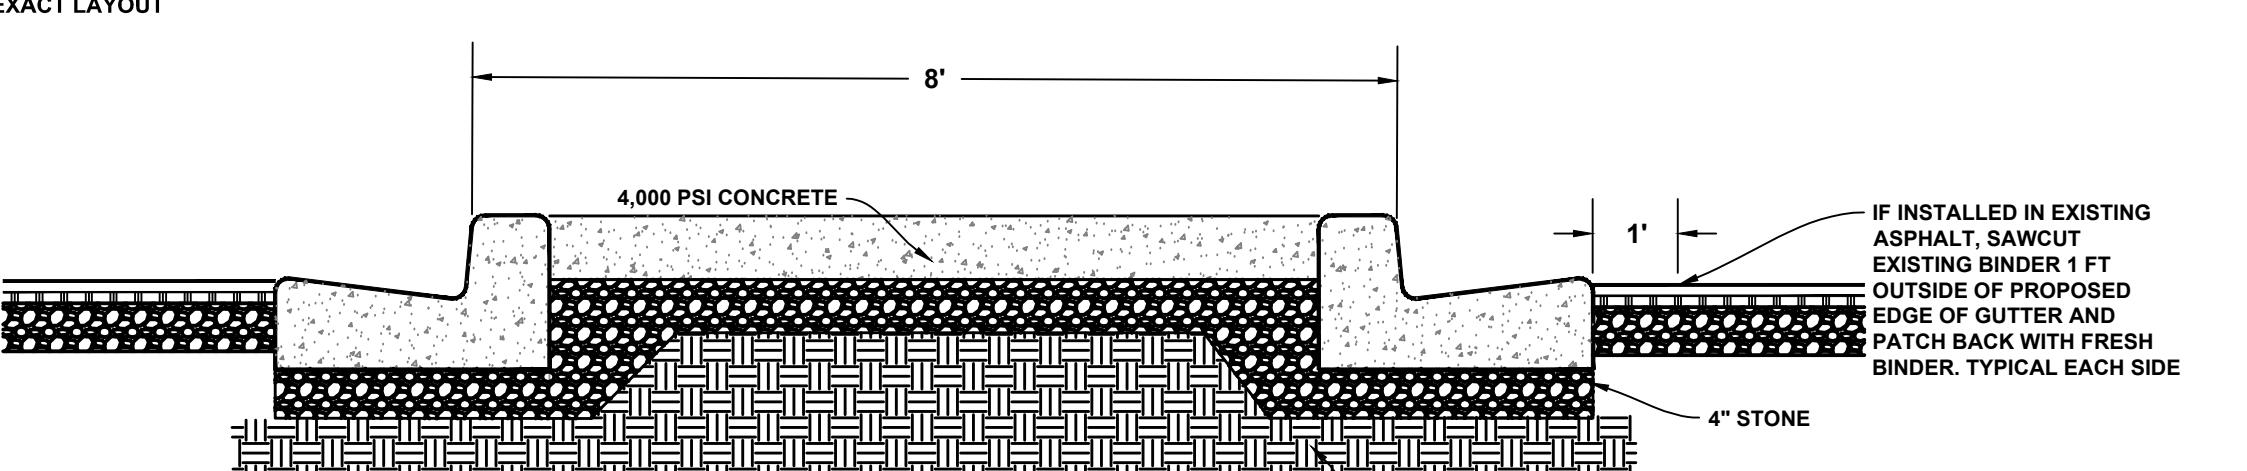

SIDWALK ISLAND DETAIL


(N.T.S.)

MAXIMUM DISTANCE BETWEEN EXPANSION JOINTS= 40' O/C
EXPANSION JOINTS REQUIRED AT ALL STRUCTURES AND CURB RETURNS

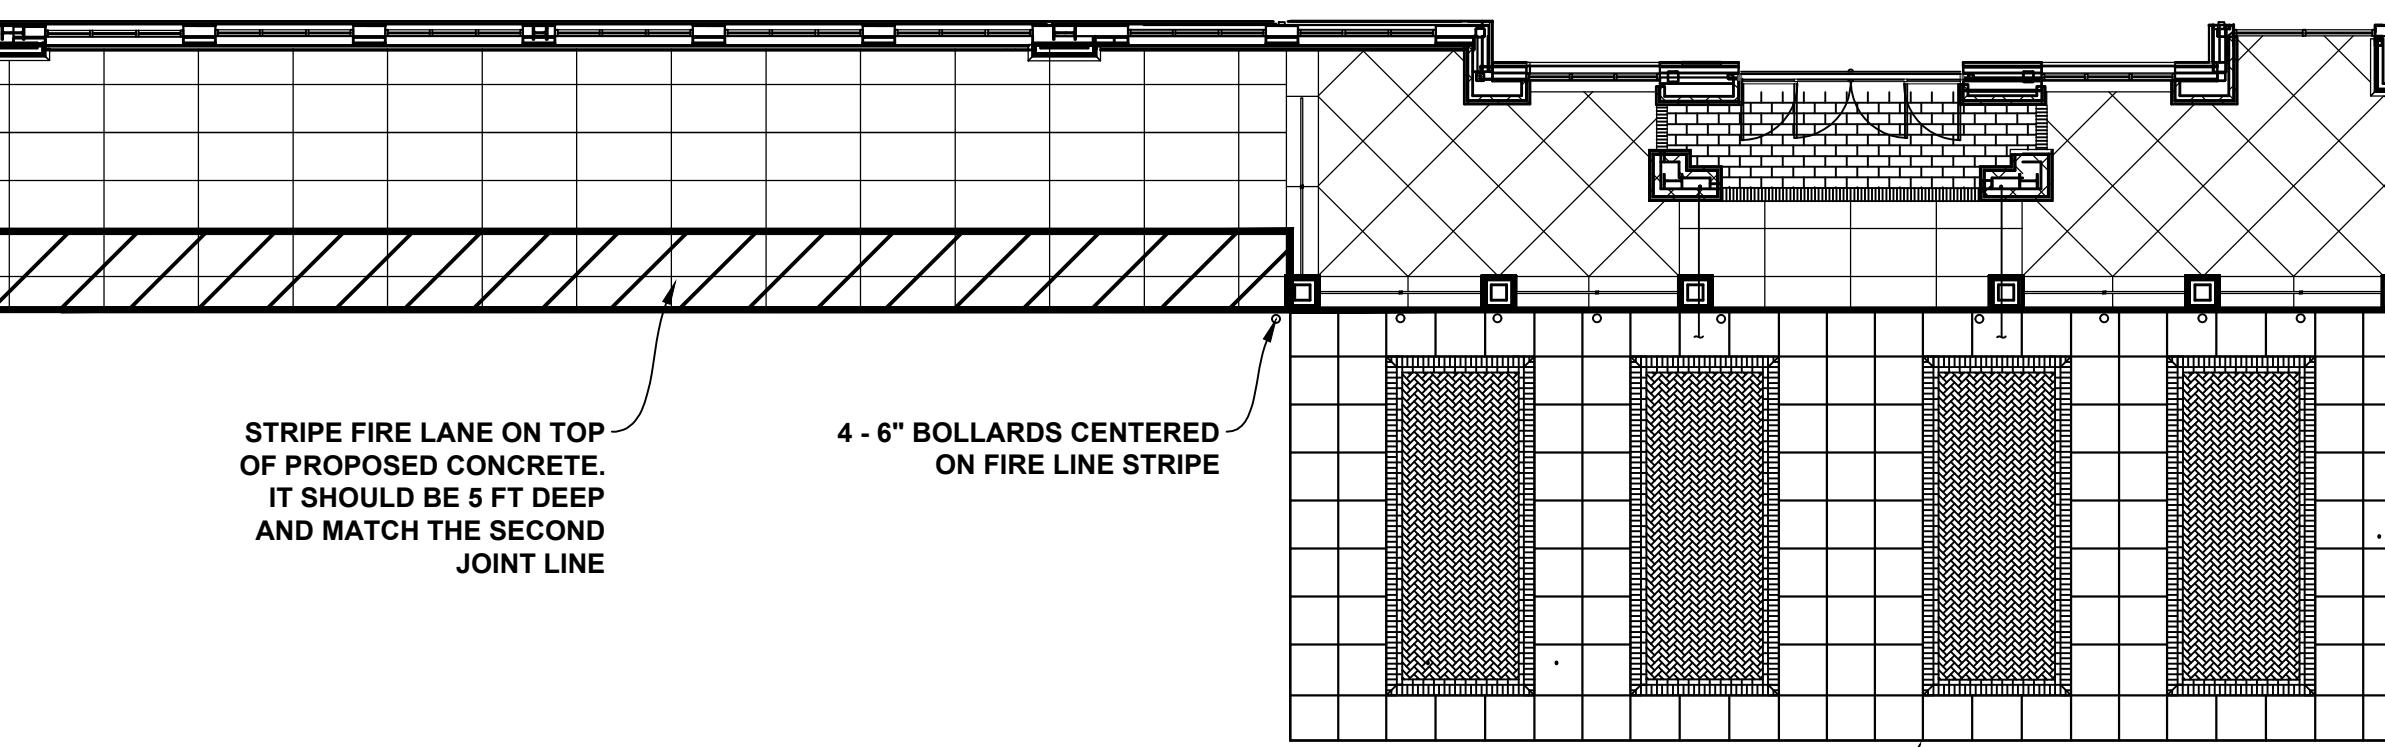


STANDARD STRIPING DETAIL

(N.T.S.)

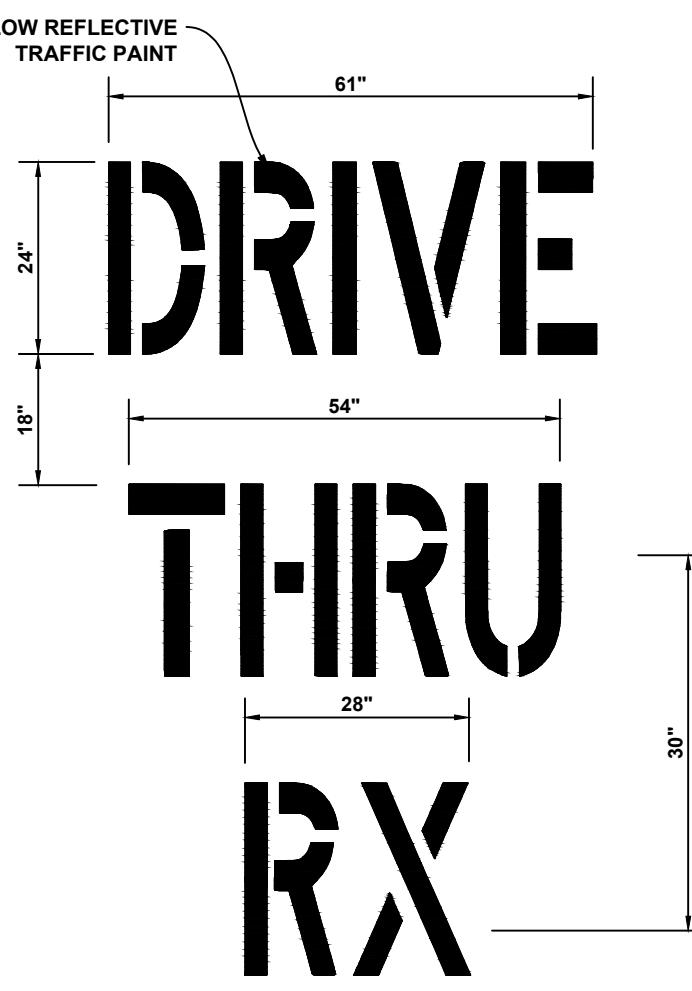PHARMACY DRIVE THRU
PAVEMENT MARKINGS

(N.T.S.)

NOTE: STENCILS FOR ALL INGLE'S STRIPING CAN BE FOUND AT PAVEMENT STENCILS CO. ALTERNATE STENCILS NEED TO BE APPROVED BY INGLE'S CONSTRUCTION DEPARTMENT

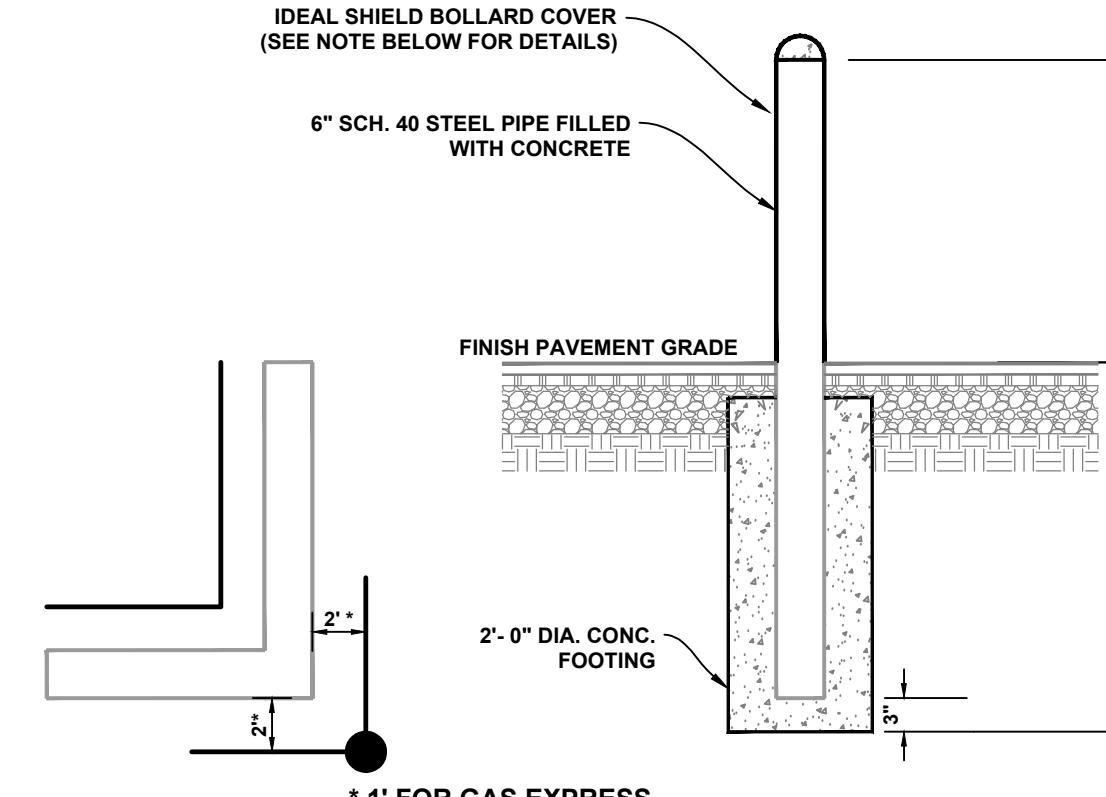


PLAN SECTION

TYPICAL BOLLARD DETAIL

(N.T.S.)

IDEAL SHIELD BOLLARD COVER NOTES:
• USE 1/4" NOMINAL THICK LOW-DENSITY POLYETHYLENE THERMOPLASTIC(LDPE)
• 6" DIAMETER BOLLARD COVER
• CUT CUSTOM HEIGHT TO 48"
• USE CUSTOM COLOR "ARCH BROWN- G79-2361-M" PART # BPD-06-052-S(50")
• BPD-CC-04-052-S(32")
• CONTACT: ANTONIO RIVER (WORK:239-368-7976)

SHIP MARK	ASS'M MARK	NO. PCS.	SECTION	LENGTH F. I.	REMARKS	UNIT WT.	TOTAL WT.
M1	45	TS 7x5x3/16	2 8	S1E			1743.60
	po	45	TS 3/16x4x3/4	0 6 1/4			76.71
	oo	90	L3x3x1/4	0 3			110.25
					TOTAL WEIGHT		1930.56
M2	14	TS 8x2x3/8	24 0				7516.32
M3	3	TS 8x2x3/8	26 0				1744.86
					FIELD BOLTS	-0-	

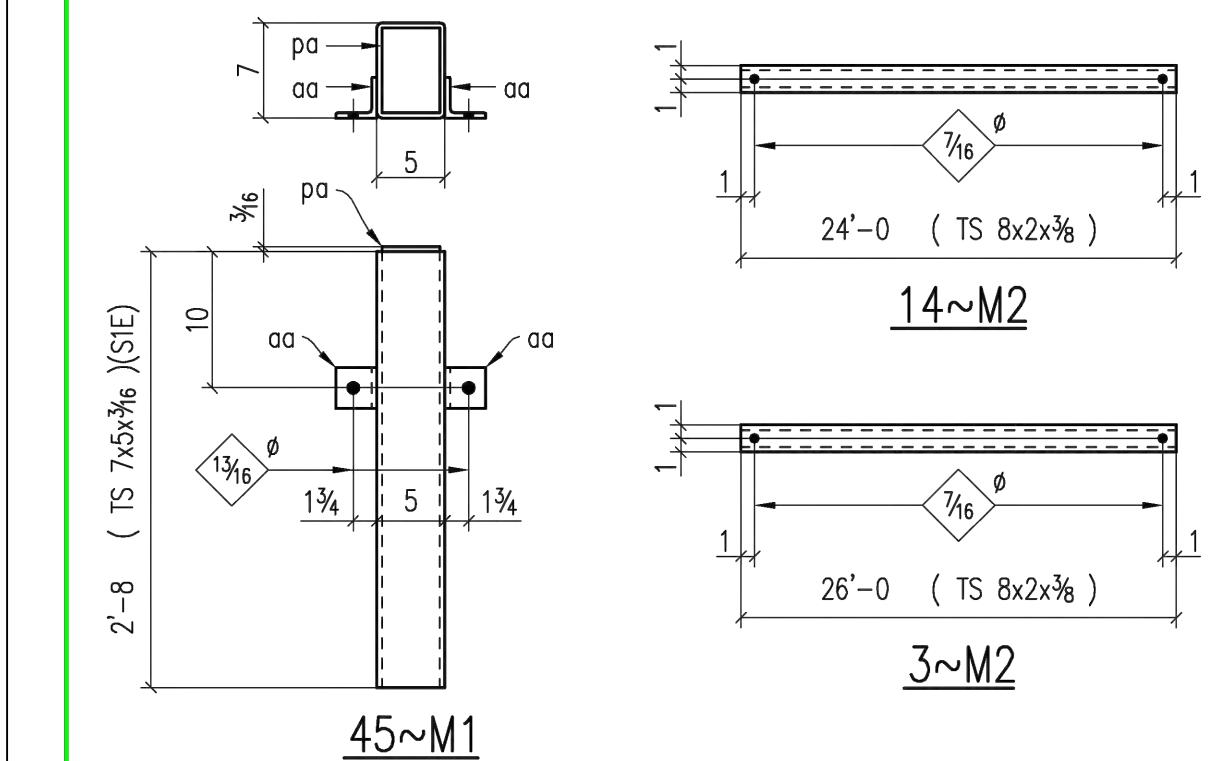


FABRICRAFT

21 THIRD ST. BRISTOL, TN 37620

CUSTOMER: JAMES R. VANNOY & SONS
PROJECT: MERRIMON AVE.
INIGLES/#3 ASHEVILLE, NC
DRAWN: R.B. 2-14
CHECKED: Q28-019
SHEET: SK1

TUBULAR STEEL GUARDRAIL


(N.T.S.)

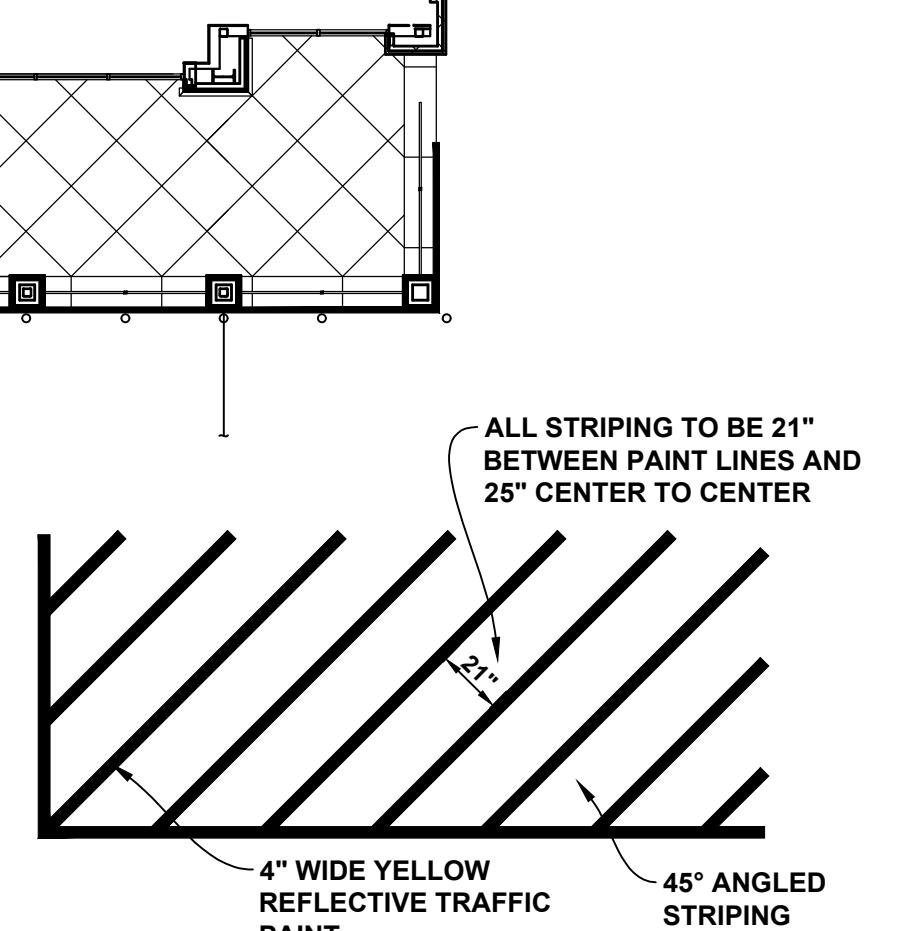

REVISIONS:

NO.	DATE	DESCRIPTION	BY
1	6/28/23	REVISED DETAILS PER INGLES	JDC

SEAL:

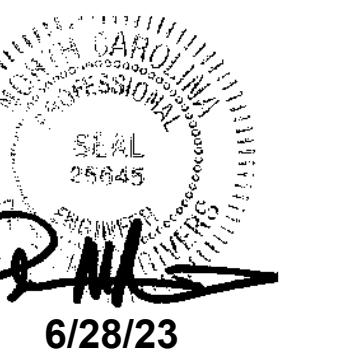

6/28/23

CORPORATE SEAL:



DBA
LAND PLANNING ASSOCIATES OF NC, INC.
110 WEST 1ST AVENUE - SUITE A
EASLEY, SC 29640
864.242.6072 FAX 205.730.8214
design@pa-inc.net

ingles
Markets Incorporated
STORE #140
5620 HENDERSONVILLE ROAD
FLETCHER NC

PROPERTY INFORMATION:
TAX MAP NUMBER: 9652316641, 9652316277
REFERENCE D.B. & PG: DB 3396 PG 597






ADDITIONAL INFO:
9652314347
DB 3464 PG 102

ISSUE FOR CONSTRUCTION:
PERMIT DATE:
BID DATE:


DRAWN BY: PCB
DESIGN BY: JDC
CHECKED BY: JDC
DATE: 4/19/22
SCALE: HORZ. VERT.
JOB NUMBER: 21.018

SITE AND UTILITY DETAILS
C-114



STORE #140
HENDERSONVILLE RD
FLETCHER NC

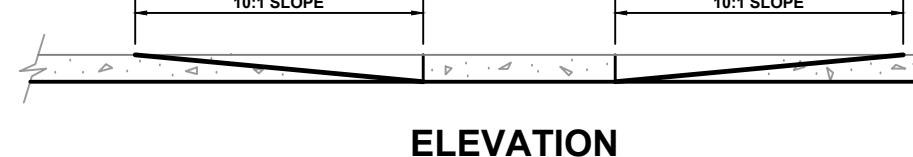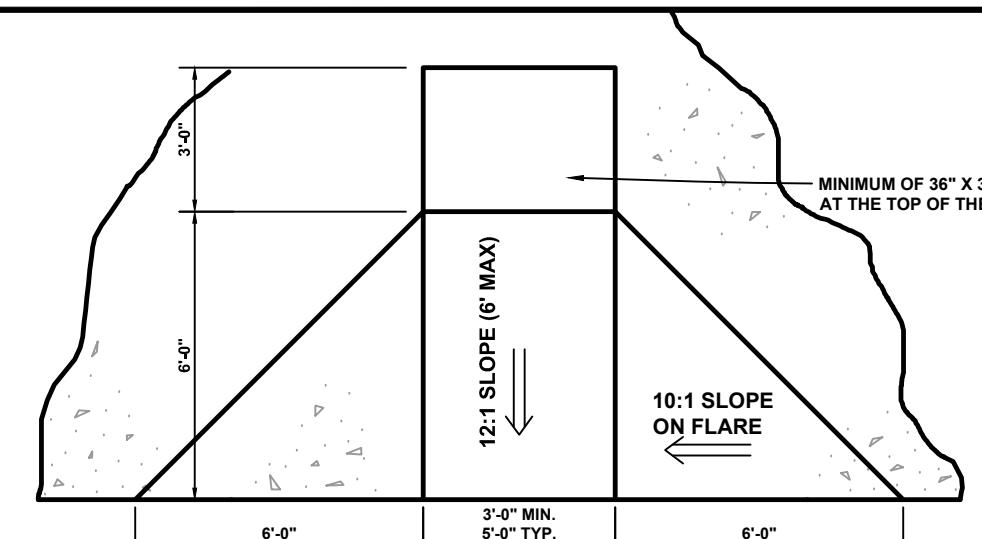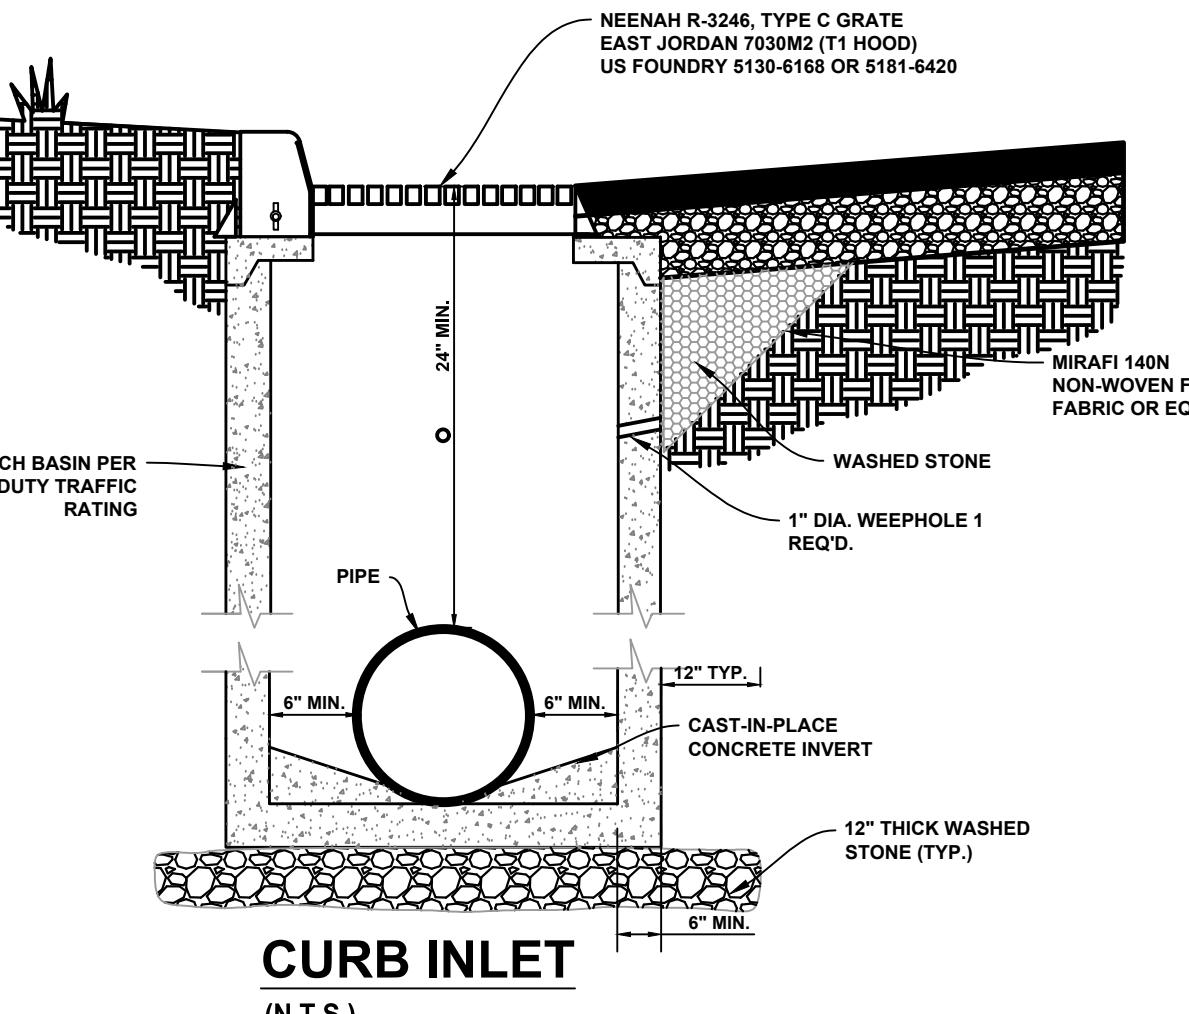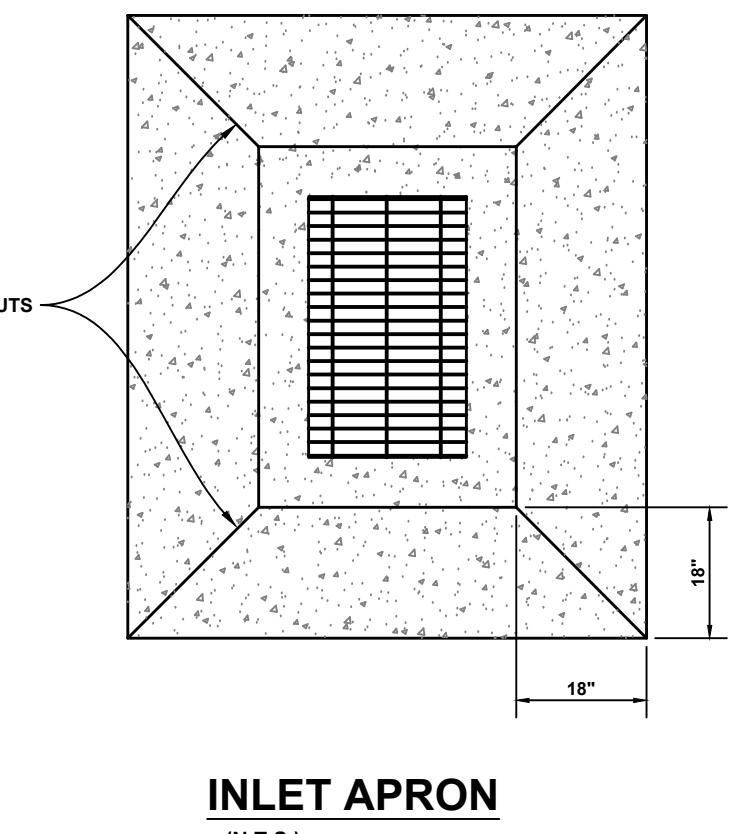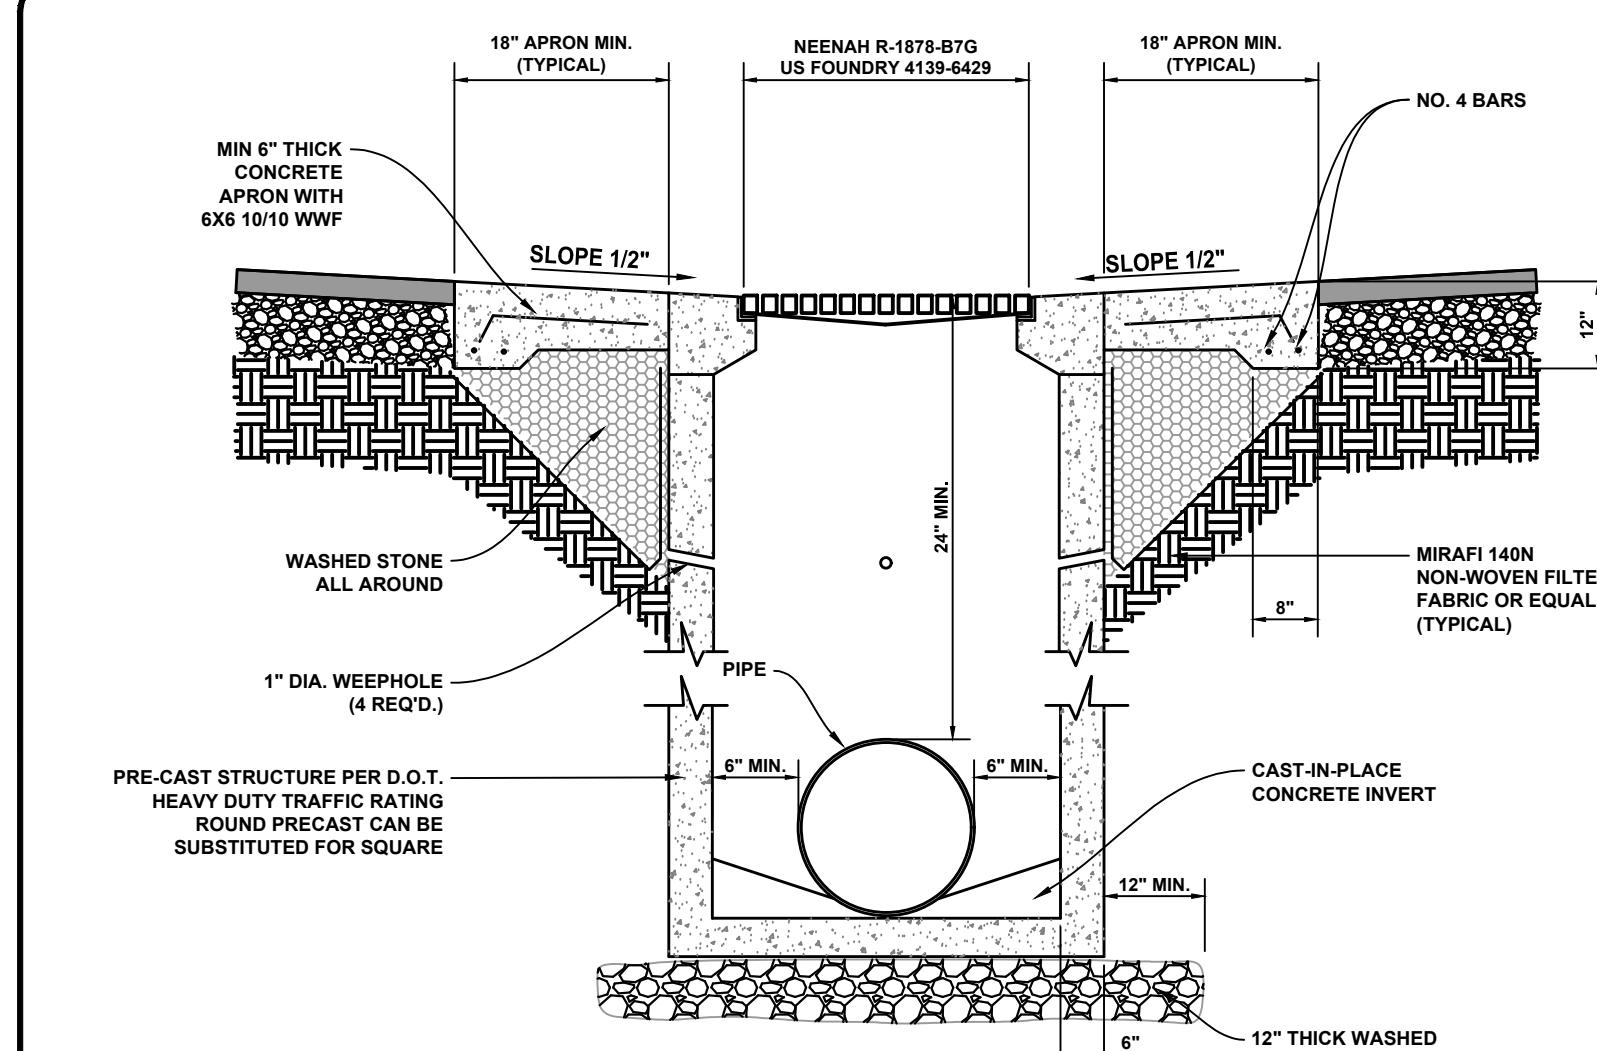CURB RAMP PLAN
(N.T.S.)


NOTE:
1. NO KNOCKOUT BOXES UNLESS APPROVED BY INGLES AND DESIGN ENGINEER
2. H-20 TRAFFIC LOAD RATING
3. IF GRATE IS REQUIRED TO BE ADA COMPLIANT, USE US FOUNDRY 4139-6002

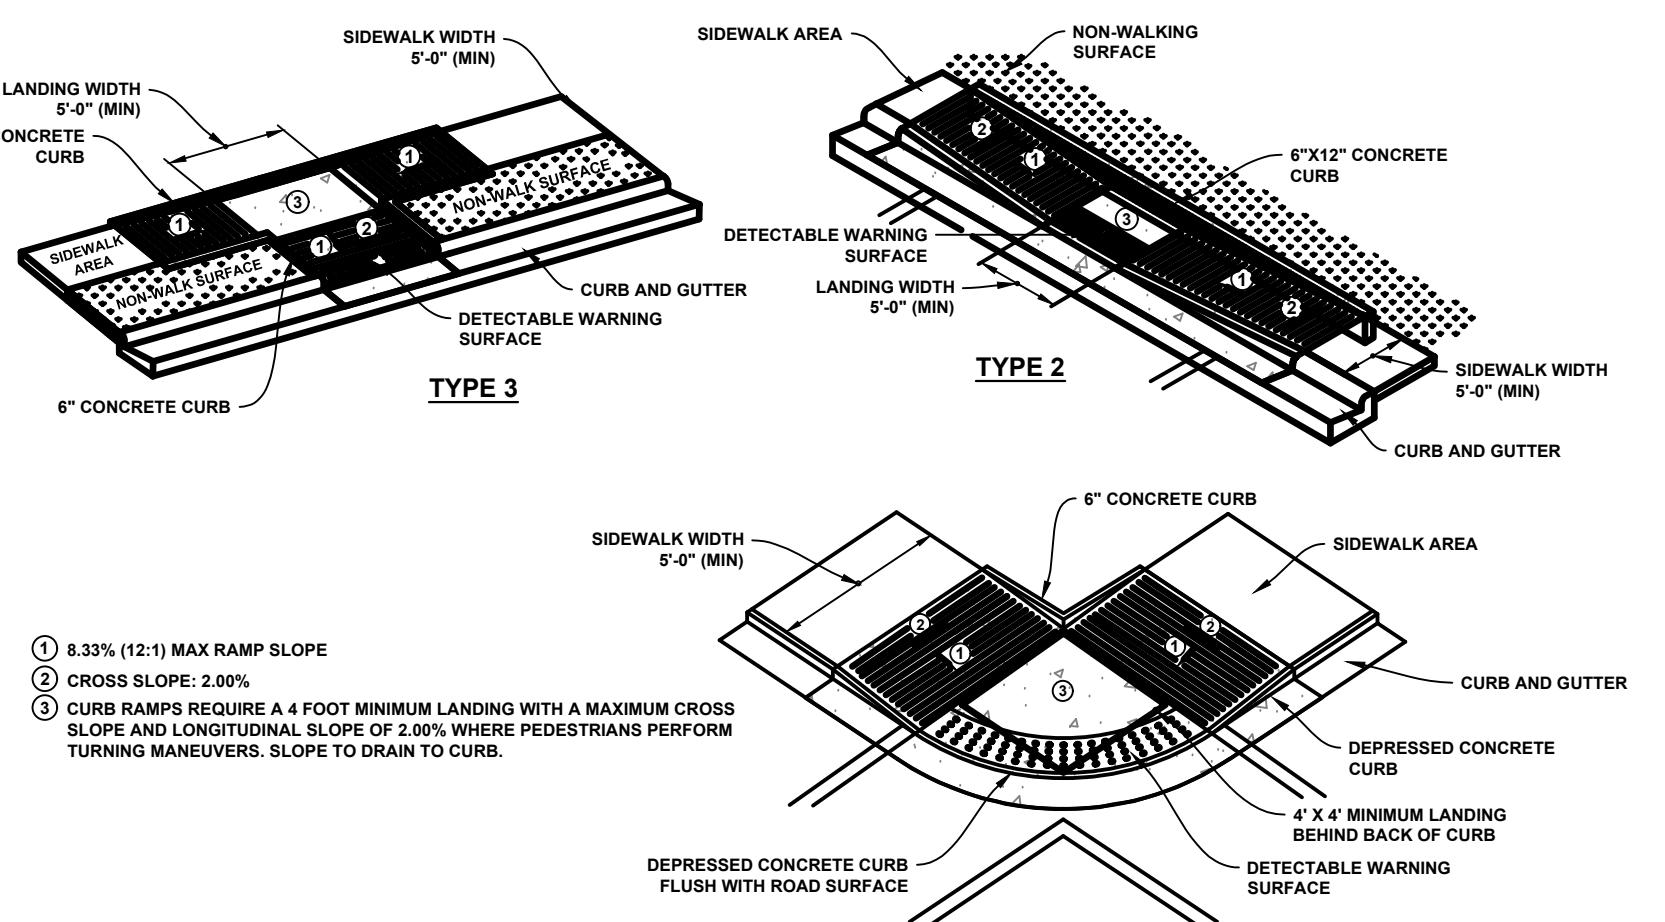DROP INLET
(N.T.S.)


NOTES:
1. NO KNOCKOUT BOXES UNLESS APPROVED BY INGLES AND DESIGN ENGINEER
2. H-20 TRAFFIC LOAD RATING
3. IF GRATE IS REQUIRED TO BE ADA COMPLIANT, USE US FOUNDRY 4139-6002

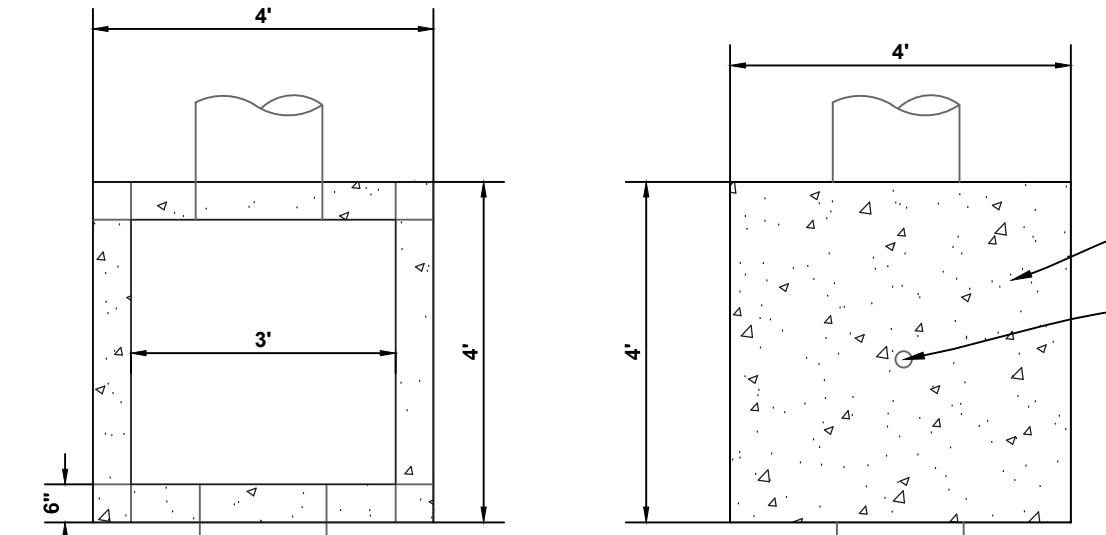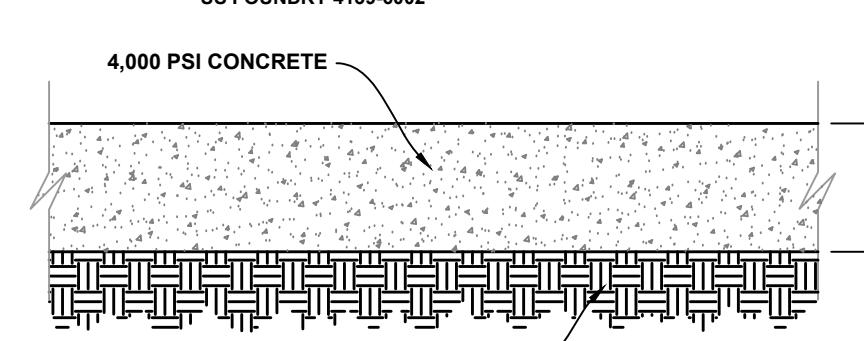CURB INLET
(N.T.S.)

NOTES:
1. NO KNOCKOUT BOXES UNLESS APPROVED BY INGLES AND DESIGN ENGINEER
2. H-20 TRAFFIC LOAD RATING
3. MANHOLE FRAME AND COVER SHALL MATCH GRADE AND CROSS SLOPE OF DRIVEWAY UNLESS WITHIN A SAG.

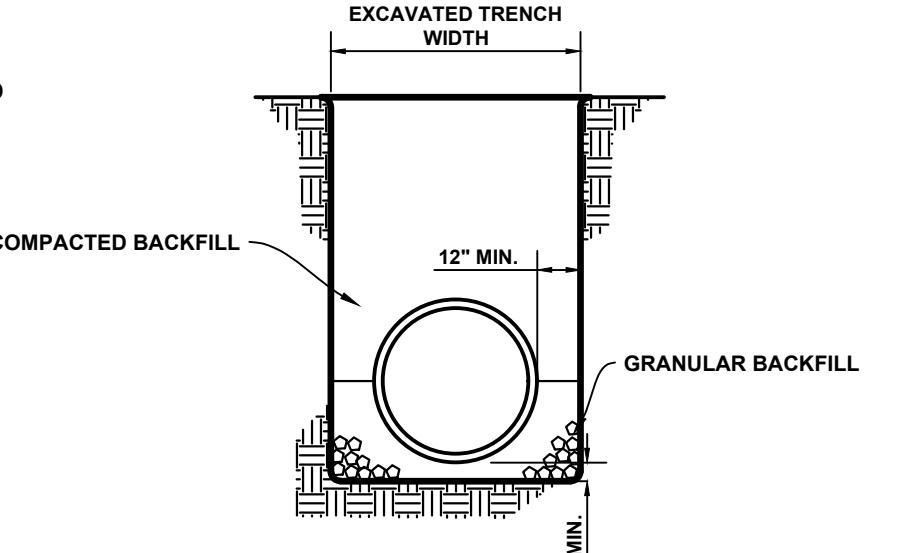DROPOUT DETAIL
(N.T.S.)

NOTES:
1. CONTRACTION JOINTS SPACE TO BE EQUAL TO SIDEWALK WIDTH
2. EXPANSION JOINTS 40 O/C
3. ALL JOINTS SEALED PER SPEC
4. SEE DOT DETAIL FOR SIDEWALK WITHIN RIGHT OF WAY
5. PLACE ON STONE WHEN REQUIRED BY GOVERNING AGENCY

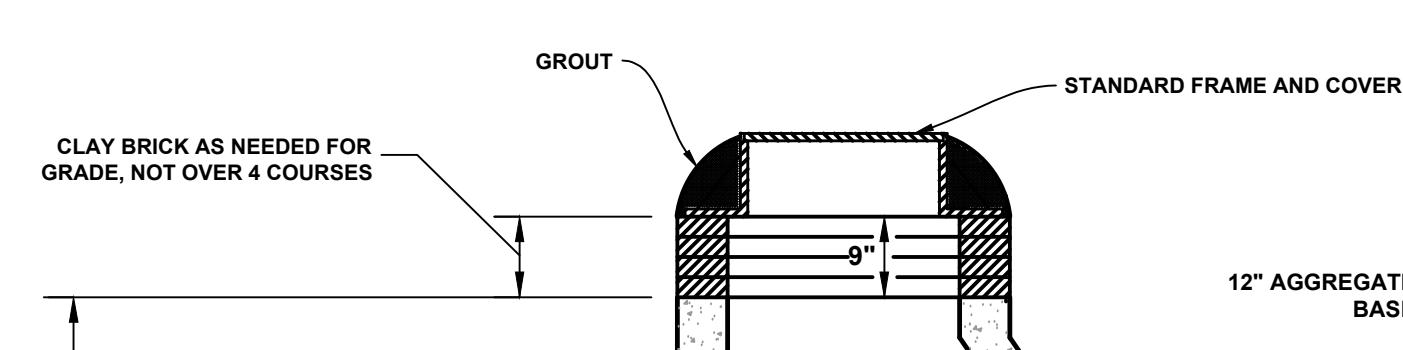SIDEWALK DETAIL
(N.T.S.)




PLAN

TOP

VARIABLE

STORM DRAIN BEDDING
(N.T.S.)

NOTE:
PIPE BEDDING MATERIAL SHALL CONFORM TO AASHTO M43 NO. 57 COURSE AGGREGATE PLACED WITH 4" MINIMUM UNDER PIPE AND BACKFILL WITH STONE TO THE SPRINGLINE. CRUSHER RUN IS ALSO ACCEPTABLE IN DRY TRENCH CONDITIONS. IF GROUNDWATER FLOW IS EXPECTED IN BEDDING MATERIAL CONTACT DESIGN ENGINEER OR GEOTECH CONSULTANT

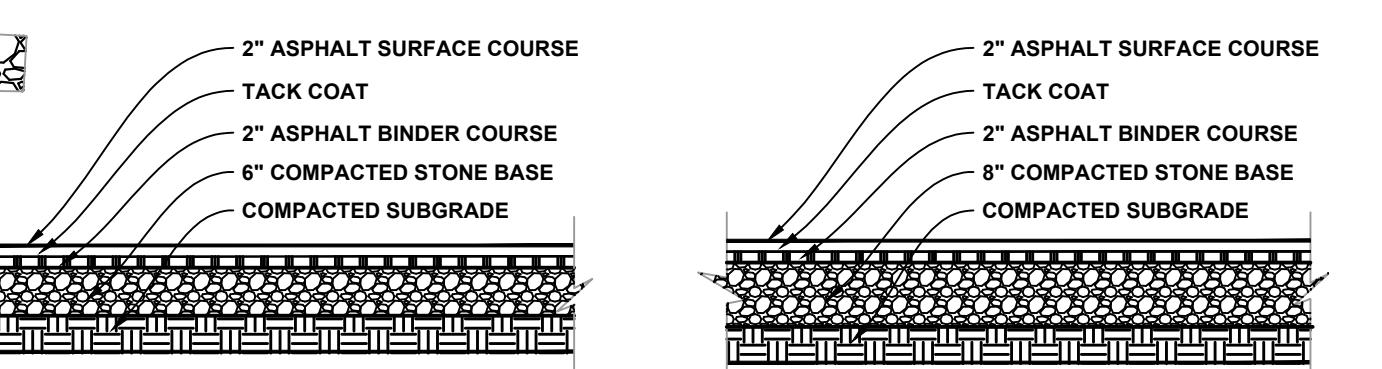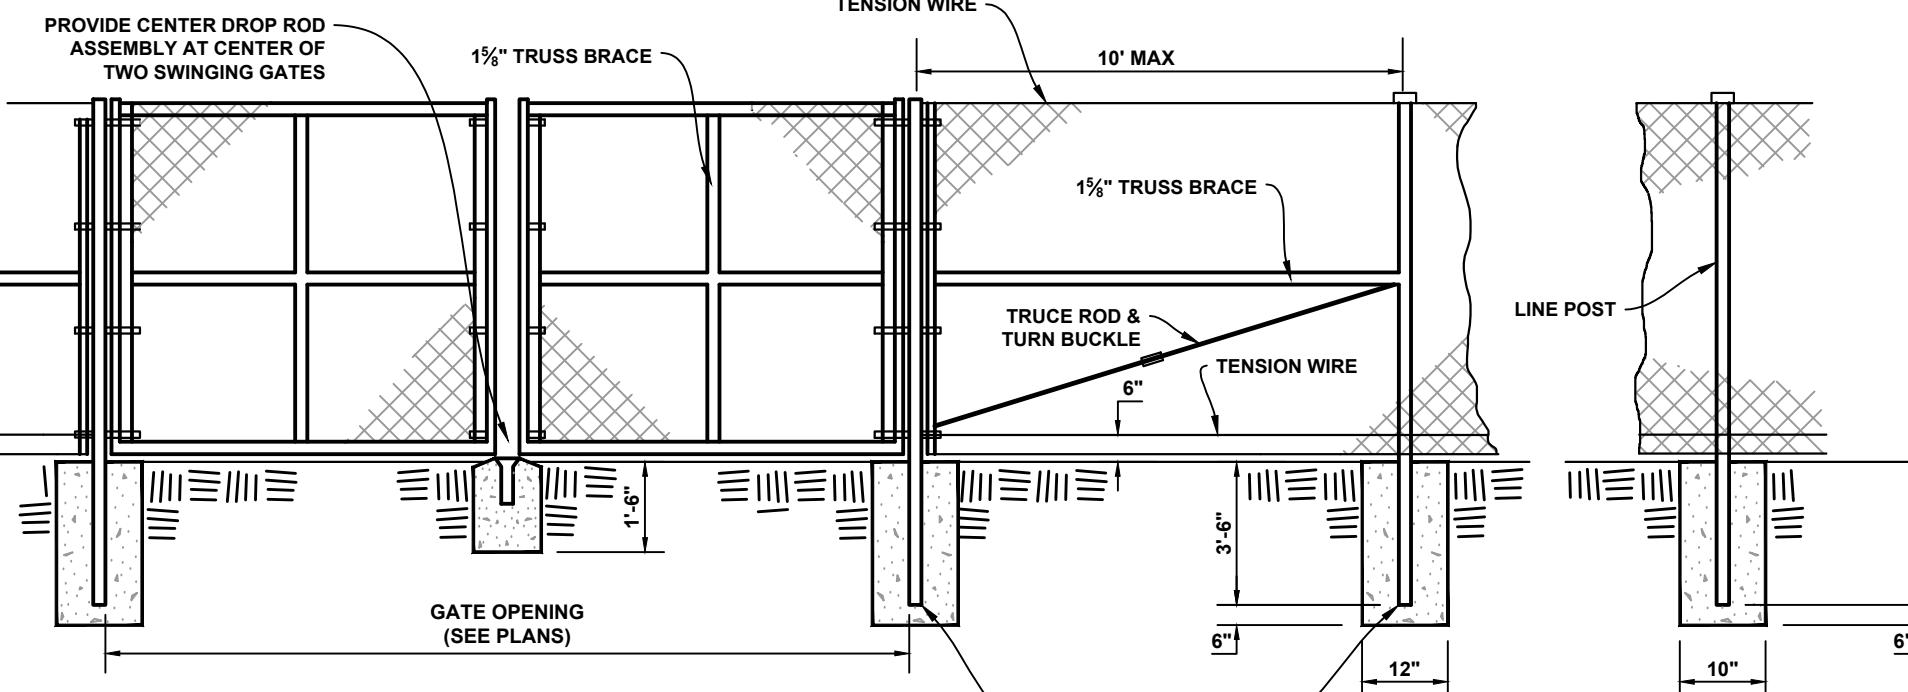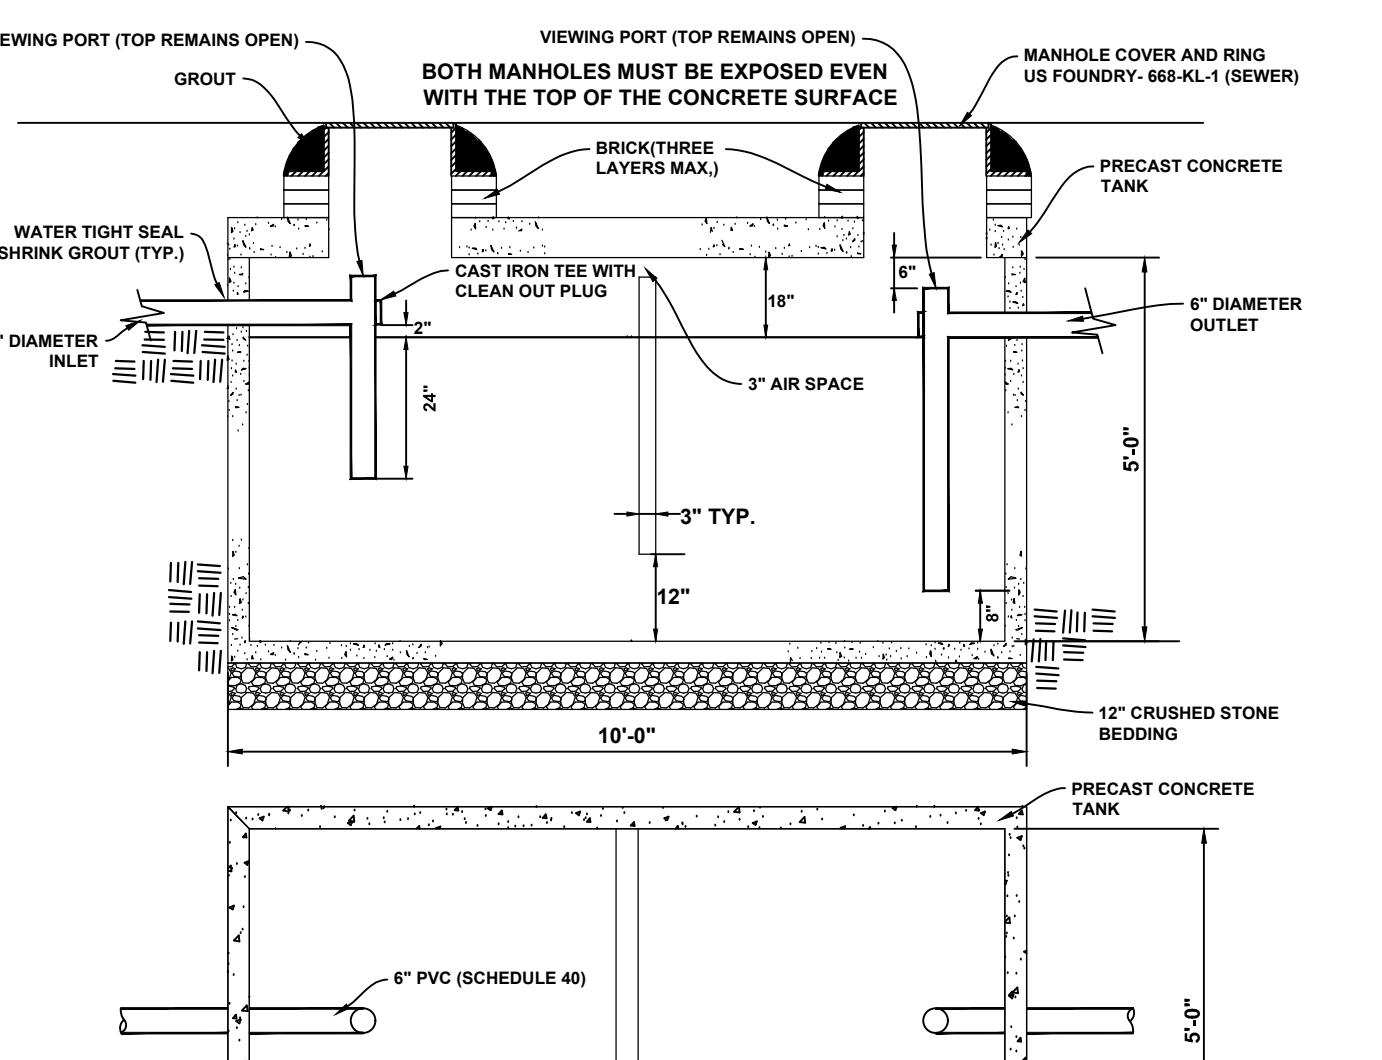PARALLEL RAMPS DETAIL
(N.T.S.)PAVING DETAILS
(N.T.S.)6' CHAIN LINK FENCE DETAIL
(N.T.S.)

REVISIONS:

NO.	DATE	DESCRIPTION	BY
1	8/26/22	ADDED NCDEQ NOTES PER HENDERSON COUNTY COMMENT	SCW
2	6/28/23	REVISED DETAILS PER INGLES	JDC

SEAL:

INGLES MARKETS INCORPORATED
SERIAL 2545
6/28/23

CORPORATE SEAL:



DBA

LAND PLANNING ASSOCIATES OF NC, INC.
110 WEST 1ST AVENUE - SUITE A
EASLEY, SC 29640
864.242.6072 FAX 208.730.8214
design@pa-inc.net


ingles
Markets Incorporated
STORE #140
5620 HENDERSONVILLE ROAD
FLETCHER NC

PROPERTY INFORMATION:	
TAX MAP NUMBER:	9652316641, 9652316277
REFERENCE D.B. & PG:	DB 3396 PG 597

ADDITIONAL INFO:
9652314347
DB 3464 PG 102


ISSUE FOR CONSTRUCTION:	
PERMIT DATE:	
BID DATE:	
DRAWN BY:	PCB
DESIGN BY:	JDC
CHECKED BY:	JDC
DATE:	4/19/22
SCALE:	HORIZ. VERT.
JOB NUMBER:	21.018

EROSION CONTROL DETAILS
C-116
STORE #140
HENDERSONVILLE RD
FLETCHER NC

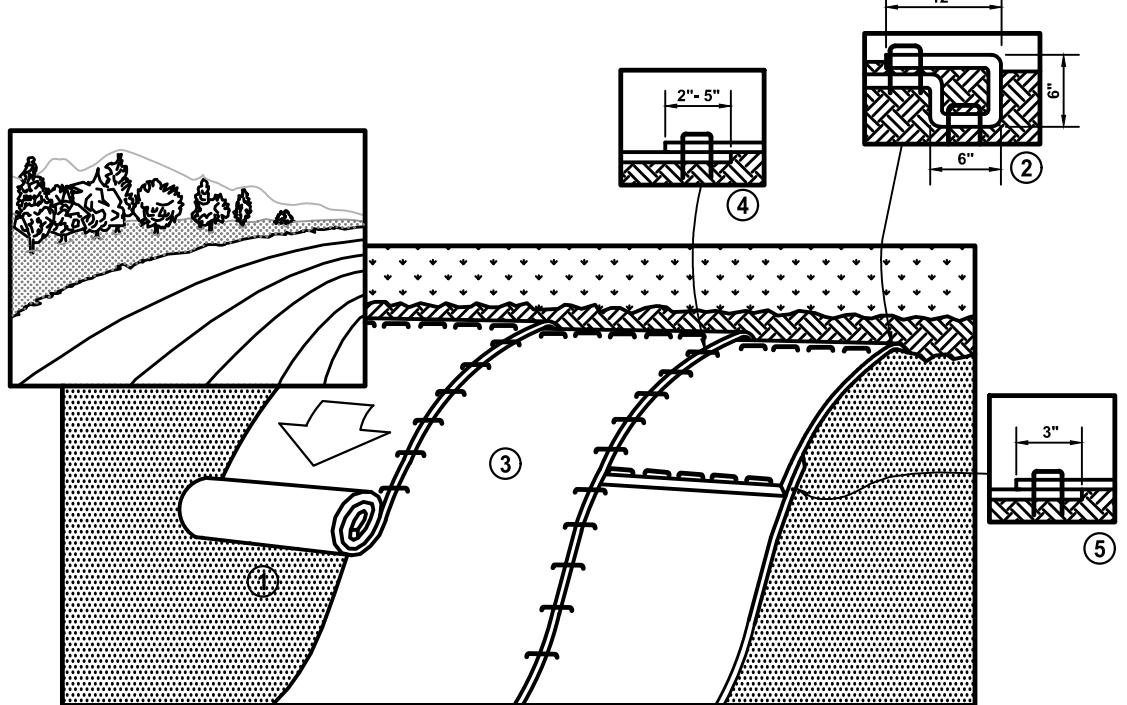**EROSIONAL CONTROL BLANKET DETAIL FOR SLOPE INSTALLATION**


NOTES:
1. PREPARE SOIL BEFORE INSTALLING BLANKETS, INCLUDING ANY NECESSARY APPLICATION OF LIME, FERTILIZER, AND SEED.
2. BEGIN AT THE TOP OF THE SLOPE BY ANCHORING THE BLANKET IN A 6" (15cm) WIDE TRENCH WITH APPROXIMATELY 12" (30cm) OF BLANKET OVER THE SOIL. BACKFILL THE TRENCH WITH SOIL, STAPLE OR STAKE THE BLANKET TO THE SOIL, AND COMPACT THE SOIL.
3. APPROPRIATELY 12" (30cm) APART IN THE BOTTOM OF THE TRENCH, BACKFILL AND COMPACT THE TRENCH AFTER STAPLING, APPLY SEED TO COMPACTED SOIL AND FOLD REMAINING 12" (30cm) PORTION OF THE BLANKET BACK OVER SEED AND COMPACTED SOIL, SECURE BLANKET OVER COMPACTED SOIL WITH A ROW OF STAPLES/TAKES SPACED APPROXIMATELY 12" (30cm) APART ACROSS THE WIDTH OF THE BLANKET.
4. ROLL THE BLANKETS VERTICALLY ON THE SLOPE. BLANKETS WILL LAY WITH THE ADVERSE SIDE AGAINST THE SOIL SURFACE. ALL STAPLES/TAKES SHOULD BE TIGHTLY STAPLED OR SECURED. STAPLES/TAKES IN APPROPRIATE LOCATIONS AS SHOWN IN THE STAPLE PATTERN GUIDE. WHEN USING OPTIONAL DOT SYSTEM, STAPLES/TAKES SHOULD BE PLACED THROUGH EACH OF THE COLOR DOTS CORRESPONDING TO THE APPROPRIATE STAPLE PATTERN.
4. IF THE EXPOSED AREA OF THE BLANKET IS BEING STORED, STAPLE OR STAKE THE BLANKET OVER APPROXIMATELY 2.5" (6cm-12.5cm) OVERLAP DEPENDING ON BLANKET TYPE. TO ENSURE PROPER SEAM ALIGNMENT, PLACE THE EDGE OF THE OVERLAPPING BLANKET (BLANKET BEING INSTALLED ON TOP) EVEN WITH THE COLORLESS SEAM STITCH ON THE PREVIOUSLY INSTALLED BLANKET.
5. COLORLESS BLANKET SEAMS SHOULD BE OVERLAPPED AND STAPLED OVER END (SHINGLE STYLE) WITH AN APPROXIMATE 3" (7.5cm) OVERLAP. STAPLE THOROUGH OVERLAPPED AREA, APPROXIMATELY 12" (30cm) APART ACROSS ENTIRE BLANKET WIDTH.

NOTE: IN LOOSE SOIL CONDITIONS, THE USE OF STAPLE OR STAKE LENGTHS GREATER THAN 6" (15cm) MAY BE NECESSARY TO PROPERLY ANCHOR THE BLANKETS.

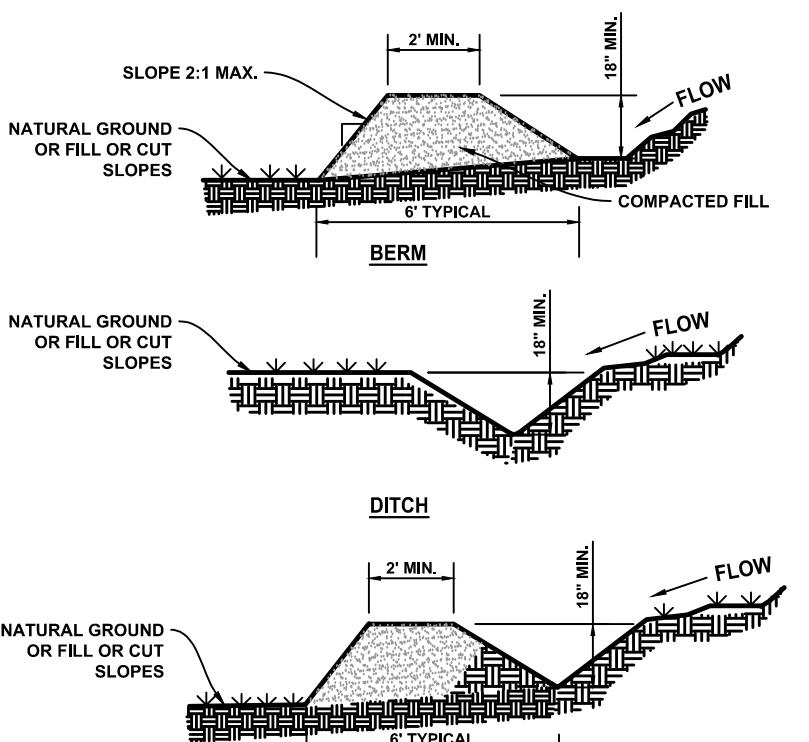


NCDEQ CONSTRUCTION NOTES:
1. REMOVE AND PROPERLY DISPOSE OF ALL TREES, BRUSH, STUMPS, AND OTHER OBJECTIONABLE MATERIAL.
2. ENDS OF DIVERSIONS MUST MEET THE PROPOSED CROSS SECTION MEETS ALL DESIGN REQUIREMENTS.
3. ENSURE THAT THE TOP OF THE DIKE IS NOT LOWER AT ANY POINT THAN THE GROUND ELEVATION PLUS THE SPECIFIED SETTLEMENT.
4. PROVIDE SUFFICIENT DRAINAGE VERTICALLY AND HORIZONTALLY TO PERMIT MAINTENANCE, REGRADING, AND CLEANOUT.
5. VEGETATE THE RIDGE IMMEDIATELY AFTER CONSTRUCTION, UNLESS IT WILL REMAIN IN PLACE LESS THAN 30 WORKING DAYS.

NCDEQ MAINTENANCE NOTES:
• INSPECT TEMPORARY DIVERSIONS ONCE A WEEK AND EVEN MORE FREQUENTLY REMOVE SEDIMENT FROM THE FLOW AREA AND REPAIR THE DIVERSION RIDGE. CAREFULLY CHECK OUTLETS AND MAKE TIMELY REPAIRS AS NEEDED. REGRAD THE DIVERSION RIDGE AND CHANNEL TO APPROPRIATELY STABILIZE IT.

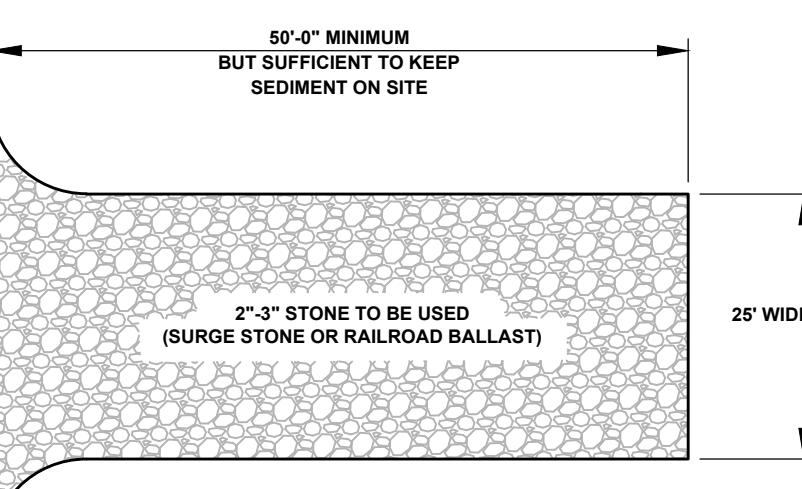

NCDEQ CONSTRUCTION NOTES:
1. CLEAR THE ENTRANCE AND EXIT AREA OF ALL VEGETATION, ROOTS, AND OTHER OBJECTIONABLE MATERIAL AND PROPERLY GRADE IT.
2. PLACE THE GRAVEL TO THE SPECIFIC GRADE AND DIMENSIONS SHOWN ON THE PLAN.
3. PROVIDE DRAINAGE TO CARRY WATER TO A SEDIMENT TRAP OR OTHER SUITABLE OUTLET.
4. USE GEOTEXTILE FABRICS BECAUSE THEY IMPROVE THE STABILITY OF THE FOUNDATION IN LOCATIONS SUBJECT TO SEEPAGE OR HIGH WATER TABLE

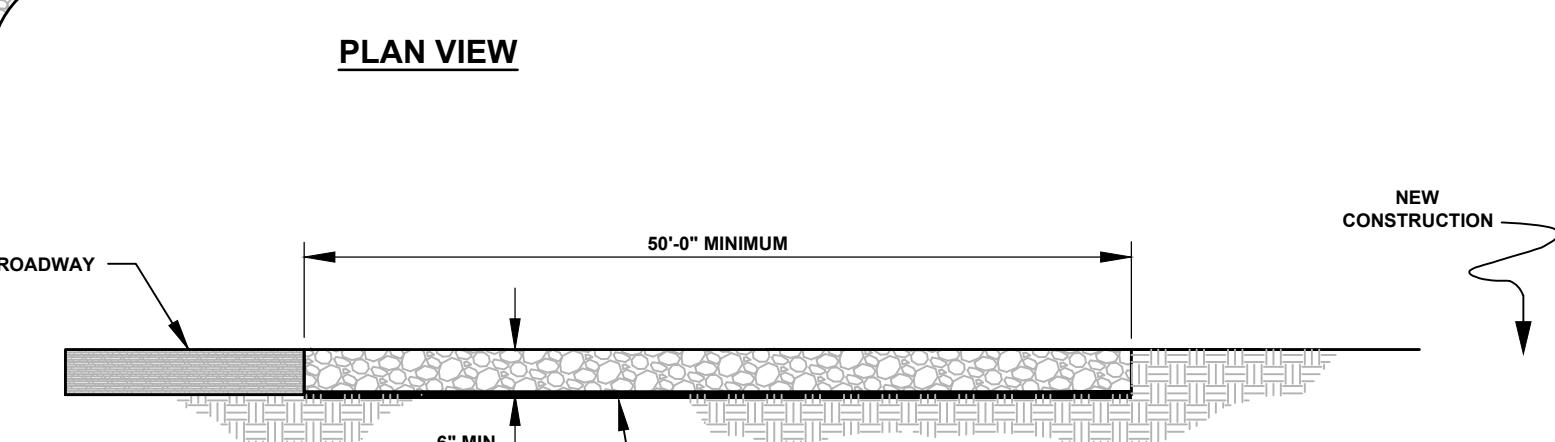**PLAN VIEW**

EXISTING ROADWAY NEW CONSTRUCTION

50'-0" MINIMUM
25' WIDE (12' MIN)

6' MIN.

FILTER FABRIC UNDER STONE

NOTES:
1) PUT FILTER FENCE OR TREE PROTECTION FENCE UP TO ENSURE CONSTRUCTION ENTRANCE IS USED.
2) IF CONSTRUCTION ON THE MUD IS SUCH THAT THE MUD IS NOT REMOVED, IT MUST BE COVERED OVER THE STONE. THE TIRES OF THE VEHICLES MUST BE WASHED BEFORE ENTERING THE PUBLIC ROAD.

NCDEQ MAINTENANCE NOTES:
• MAINTAIN THE GRAVEL PAD IN A CONDITION TO PREVENT MUD OR SEDIMENT FROM SPILLING OFF THE CONSTRUCTION SITE. THIS MAY REQUIRE FILTER FABRIC COVERED WITH 2" STONE. AFTER EACH RAINFALL, INSPECT ANY STRUCTURE USED TO TRAP SEDIMENT AND CLEAN IT OUT AS NECESSARY. IMMEDIATELY REMOVE ALL OBJECTIONABLE MATERIALS SPILLED, WASHED, OR TRACKED ONTO PUBLIC ROADWAYS.

NOTES:
1) POSITIVE GRADE MUST BE PROVIDED TO ASSURE DRAINAGE. IF SLOPE EXCEEDS 2%, SEED AND MULCH DIVISION, TRY NOT TO EXCEED 3%.
2. ENSURE THAT THE TOP OF THE DIKE IS NOT LOWER AT ANY POINT THAN THE GROUND ELEVATION PLUS THE SPECIFIED SETTLEMENT.
3. DIVERSIONS SUFFICIENT TO DIRECT ALL SEDIMENT-LADEN STORMWATER INTO SEDIMENT CONTROL DEVICE MUST BE INSTALLED PRIOR TO CLEARING AND GRADING OF AREA (OR DIVERSIONS WITH THIS OPERATION IF SEDIMENT CONTROLS AND DIVERSIONS ARE NOT ENSURED).

4. DIVERSIONS SHOULD BE LOCATED TO MINIMIZE DAMAGES BY CONSTRUCTION OPERATIONS.

5. DIVERSIONS SHOULD BE SEADED AND MULCHED IF THEY ARE TO REMAIN IN PLACE OVER 4 DAYS.

6. CHECK DIVERSIONS AFTER EACH RAIN, OR ONCE PER WEEK WHICH EVER IS THE SHORTER DURATION. REPAIR AS NEEDED TO MAINTAIN FUNCTION.

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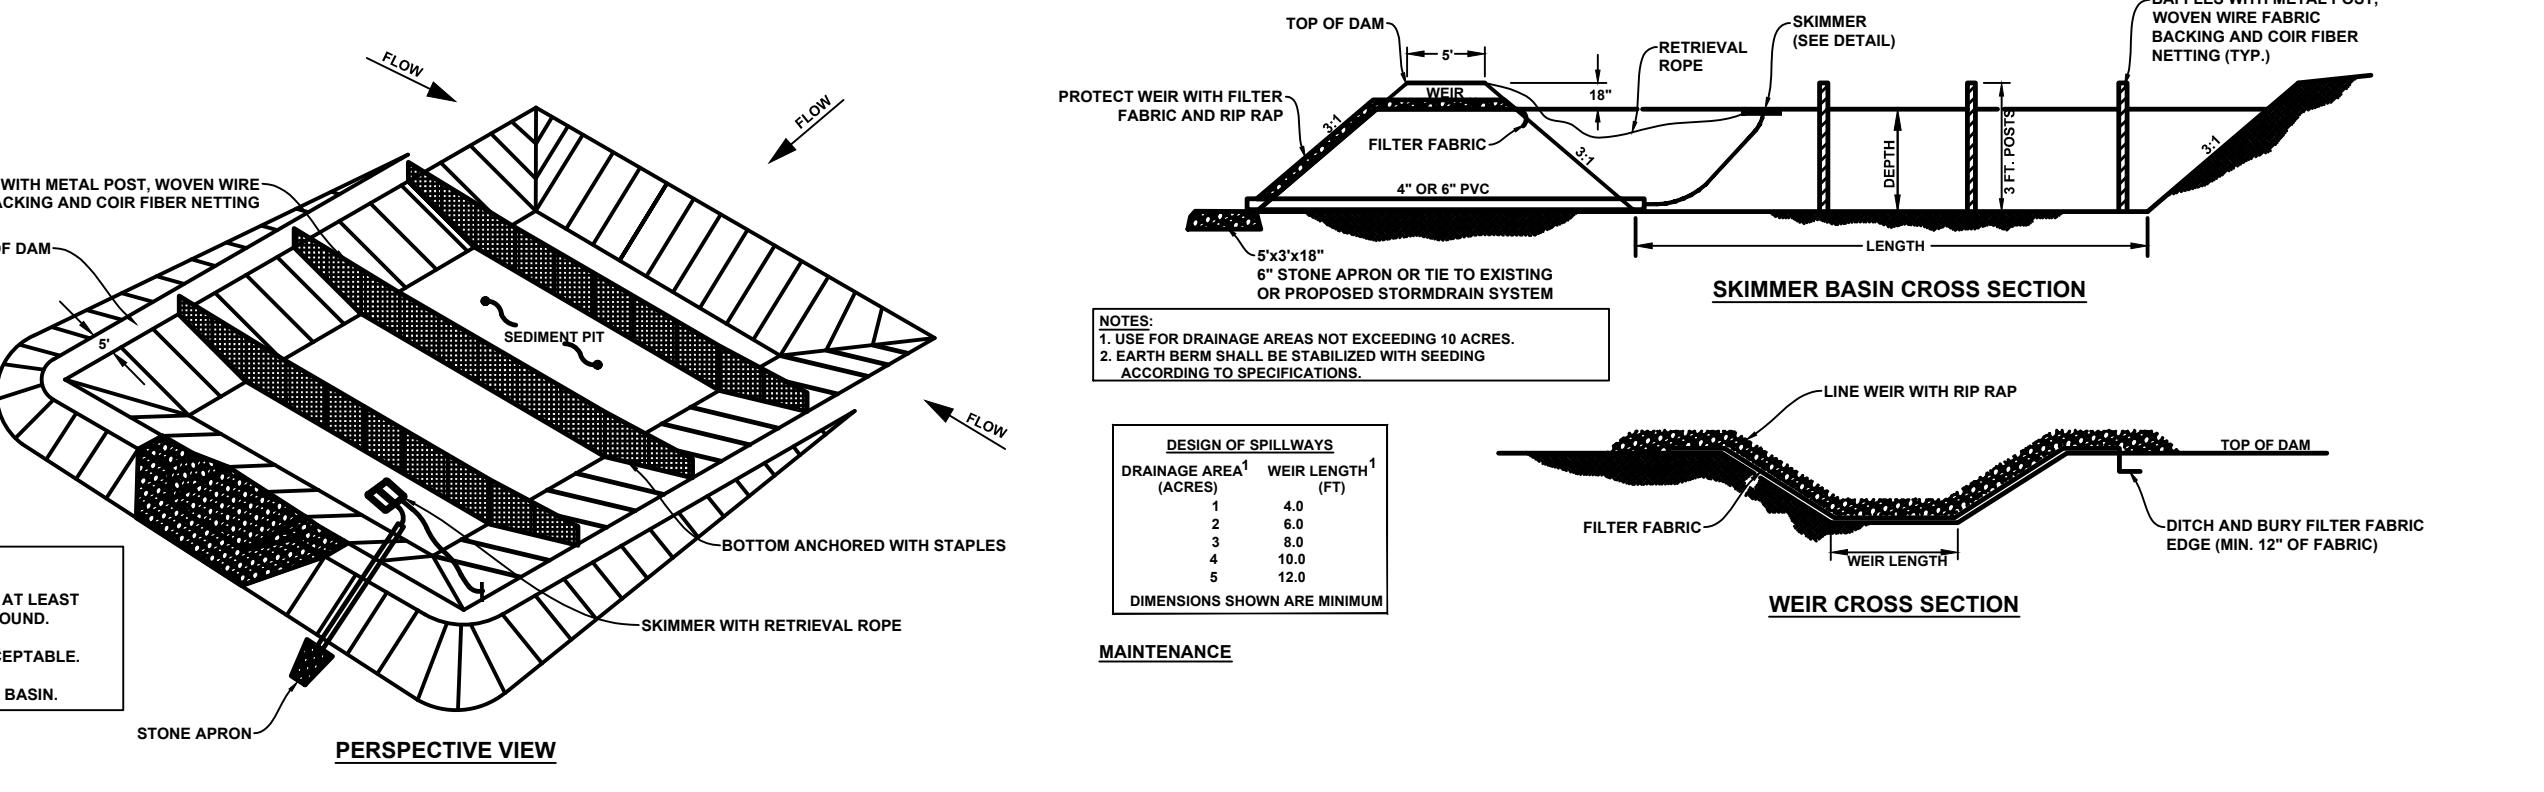
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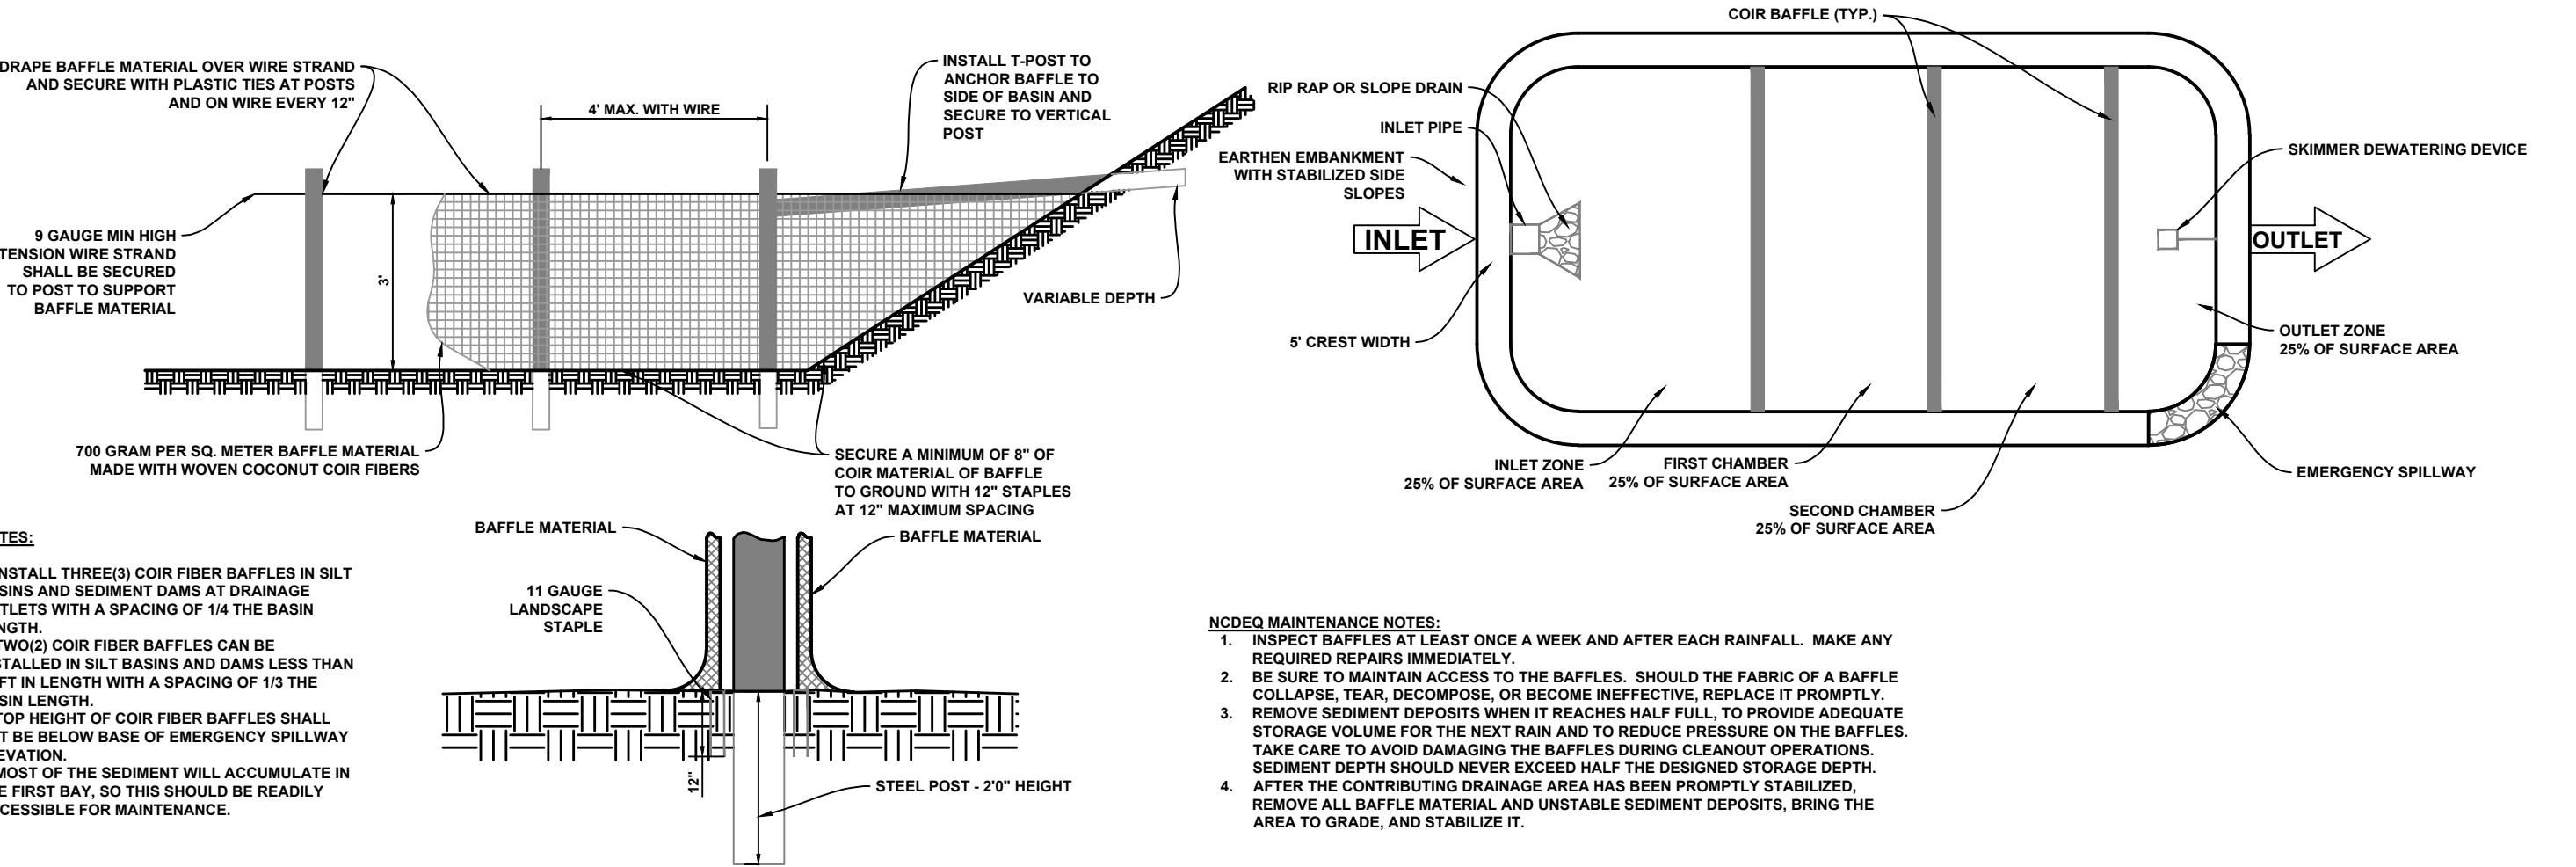
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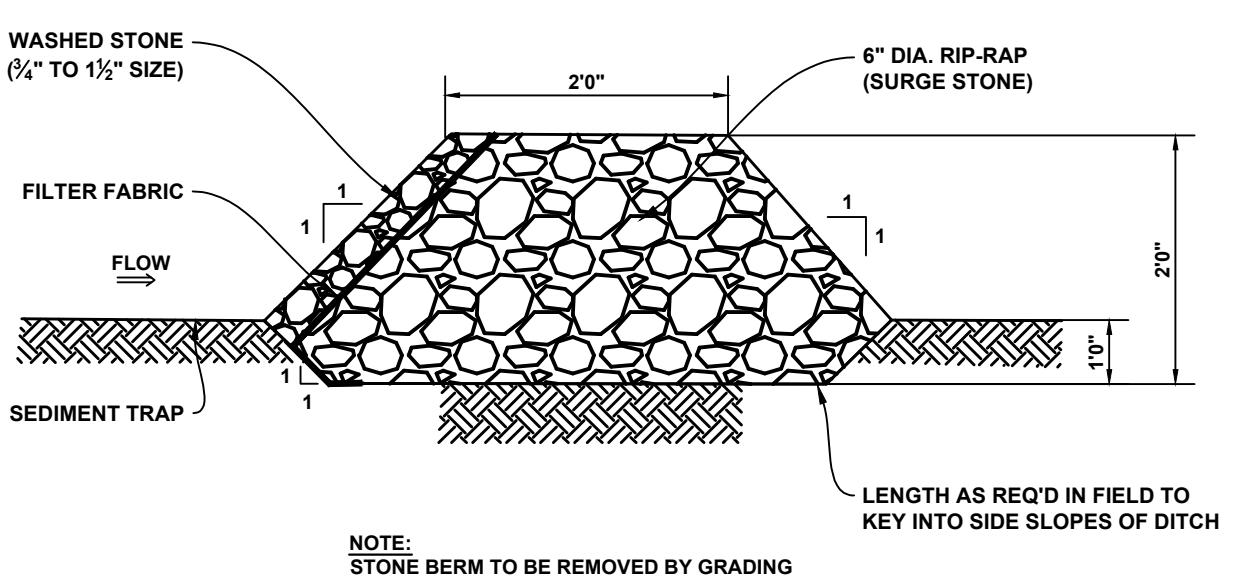
NCDEQ CONSTRUCTION NOTES:

1. CLEAR, GRUB, AND STRIP THE AREA UNDER THE EMBANKMENT OF ALL VEGETATION AND ROOT MAT. REMOVE ALL SURFACE SOIL CONTAINING HIGH AMOUNTS OF ORGANIC MATTER AND STOCKPILE OR DISPOSE OF IT PROPERLY. HAUL ALL OBJECTIONABLE MATERIAL TO THE DESIGNATED DISPOSAL AREA. PLACE TEMPORARY SEDIMENT CONTROL MEASURES BELOW BASIN AS NEEDED.
2. ENSURE THAT FILL MATERIAL FOR THE EMBANKMENT IS FREE OF ROOTS, WOODY VEGETATION, ORGANIC MATER, AND OTHER OBJECTIONABLE MATERIAL. PLACE THE FILL IN LIFTS NOT TO EXCEED 9", AND MACHINE COMPACT IT. OVERFILL THE EMBANKMENT 6" TO ALLOW FOR SETTLEMENT
3. SHAPE THE BASIN TO THE SPECIFIED DIMENSIONS. PREVENT THE SKIMMING DEVICE FROM SETTLING INTO THE MUD BY EXCAVATING A SHALLOW PIT UNDER THE SKIMMER OR PROVIDING A LOW SUPPORT UNDER THE SKIMMER OF STONE OR TIMBER.
4. PLACE THE BARREL ON A FIRM, SMOOTH FOUNDATION OF IMPERVIOUS SOIL. DO NOT USE PERVERIOUS MATERIAL SUCH AS SAND, GRAVEL OR CRUSHED STONE AS BACKFILL AROUND THE PIPE. PLACE THE FILL MATERIAL AROUND THE PIPE SPILLWAY IN 4" LAYERS AND COMPACT IT UNDER AND AROUND THE PIPE TO AT LEAST THE SAME DENSITY AS THE ADJACENT EMBANKMENT. CARE MUST BE TAKEN NOT RAISE THE PIPE FROM THE FIRM CONTACT WITH ITS FOUNDATION WHEN COMPACTING UNDER THE PIPE HAUNCHES. PLACE A MINIMUM DEPTH OF 2' OF COMPACTED BACKFILL OVER THE PIPE SPILLWAY BEFORE CROSSING IT WITH CONSTRUCTION EQUIPMENT. IN NO CASE SHOULD THE PIPE CONDUIT BE INSTALLED BY CUTTING A TRENCH THROUGH THE DAM AFTER THE EMBANKMENT IS COMPLETE.
5. ASSEMBLE THE SKIMMER FOLLOWING THE MANUFACTURERS INSTRUCTIONS, OR AS DESIGNED.
6. LAY THE ASSEMBLED SKIMMER ON THE BOTTOM OF THE BASIN WITH THE FLEXIBLE JOINT AT THE INLET OF THE BARREL PIPE. ATTACH THE FLEXIBLE JOINT TO THE BARREL PIPE AND POSITION THE SKIMMER OVER THE EXCAVATED PIT OR SUPPORT. BE SURE TO ATTACH A ROPE TO THE SKIMMER AND ANCHOR IT TO THE SIDE OF THE BASIN. THIS WILL BE USED TO PULL THE SKIMMER TO THE SIDE FOR MAINTENANCE.
7. EARTHEN SPILLWAYS - INSTALL THE SPILLWAY IN UNDISTURBED SOIL TO THE GREATEST EXTENT POSSIBLE. THE ACHIEVEMENT OF PLANNED EXCAVATIONS, GRADE, DESIGN WITH, AND ENTRANCE AND EXIT SLOPES ARE CRITICAL TO THE SUCCESSFUL OPERATION OF THE SPILLWAY. THE SPILLWAY SHOULD BE LINED WITH LAMINATED PLASTIC OR IMPERMEABLE GEOTEXTILE FABRIC. THE FABRIC MUST BE WIDE AND LONG ENOUGH TO COVER THE BOTTOM AND SIDES AND EXTEND ONTO THE TOP OF THE DAM FOR ANCHORING IN A TRENCH. THE EDGES MAY BE SECURED WITH 8" STAPLES OR PINS. THE FABRIC MUST BE LONG ENOUGH TO EXTEND DOWN THE SLOPE AND EXIT ONTO STABLE GROUND. THE WIDTH OF THE FABRIC MUST BE ONE PIECE, NOT JOINED OR SPLICED; OTHERWISE WATER CAN GET UNDER THE FABRIC. IF THE LENGTH OF THE FABRIC IS INSUFFICIENT FOR THE ENTIRE LENGTH OF THE SPILLWAY, MULTIPLE SECTIONS, SPANNING THE COMPLETE WIDTH, MAY BE USED. THE UPPER SECTION(S) SHOULD OVERLAP THE LOWER SECTION(S) SO THAT THE WATER CANNOT FLOW UNDER THE FABRIC. SECURE THE UPPER EDGE AND SIDES OF THE FABRIC IN A TRENCH WITH STAPLES OR PINS.
8. INLETS - DISCHARGE WATER INTO THE BASIN IN A MANNER TO PREVENT EROSION. USE TEMPORARY SLOPE DRAINS OR DIVERSIONS WITH OUTLET PROTECTION TO DIVERT SEDIMENT-LADEN WATER TO THE UPPER END OF THE POOL AREA TO IMPROVE BASIN TRAP EFFICIENCY.
9. EROSION CONTROL - CONSTRUCT THE STRUCTURE SO THAT THE DISTURBED AREA IS MINIMIZED. DIVERT SURFACE WATER AWAY FROM BARE AREAS. COMPLETE THE EMBANKMENT BEFORE THE AREA IS CLEARED. STABILIZE THE EMERGENCY SPILLWAY EMBANKMENT AND ALL OTHER DISTURBED AREAS ABOVE THE CREST OF THE PRINCIPLE SPILLWAY IMMEDIATELY AFTER CONSTRUCTION
10. INSTALL POROUS BAFFLES AS SPECIFIED IN DETAIL
11. AFTER ALL THE SEDIMENT-PRODUCING AREAS HAVE BEEN PERMANENTLY STABILIZED, REMOVE THE STRUCTURE AND ALL UNSTABLE SEDIMENT. SMOOTH THE AREA TO BLEND WITH THE ADJOINING AREAS AND STABILIZE PROPERLY.



NCDEQ CONSTRUCTION NOTES:

1. GRADE THE BASIN SO THAT THE BOTTOM IS LEVEL FRONT TO BACK AND SIDE TO SIDE.
2. INSTALL THE COIR FIBER BAFFLES IMMEDIATELY UPON EXCAVATION OF THE BASINS.
3. INSTALL POSTS ACROSS THE WIDTH OF THE SEDIMENT TRAP.
4. STEEL POSTS SHOULD BE DRIVEN TO A DEPTH OF 24" AND SPACED AT A MAXIMUM OF 4' APART. THE TOP OF THE FABRIC SHOULD BE A MINIMUM OF 6" HIGHER THAN THE INVERT OF THE SPILLWAY. TOPS OF BAFFLES SHOULD BE A MINIMUM OF 2" LOWER THAN THE TOP OF THE EARTHEN EMBANKMENT.
5. INSTALL AT LEAST 3 ROWS OF BAFFLES BETWEEN THE INLET AND OUTLET DISCHARGE POINT. BASINS LESS THAN 20' MAY USE 2 BAFFLES.
6. ATTACH A 9 GAUGE HIGH TENSION WIRE STRAND TO THE STEEL POSTS AT A HEIGHT OF 6" ABOVE THE SPILLWAY ELEVATION WITH PLASTIC TIES OR WIRE FASTENERS TO PREVENT SAGGING. IF THE TEMPORARY SEDIMENT BASIN WILL BE CONVERTED TO A PERMANENT STORMWATER BASIN OF A GREATER DEPTH, THE BAFFLE HEIGHT SHOULD BE BASED ON THE POOL DEPTH DURING USE AS A TEMPORARY SEDIMENT BASIN.
7. EXTEND 9 GAUGE MINIMUM HIGH TENSION WIRE STRAND TO SIDE OF BASIN OR INSTALL STEEL T-POSTS TO ANCHOR BAFFLE TO SIDE OF BASIN AND SECURE TO VERTICAL END POSTS.
8. DRAPE THE COIR FIBER MAT OVER THE WIRE STRAND MOUNTED AT A HEIGHT OF 6" ABOVE THE SPILLWAY ELEVATION. SECURE THE COIR FIBER MAT TO THE WIRE STRAND WITH PLASTIC TIES OR WIRE FASTENERS. ANCHOR THE MATTING TO THE SIDES AND FLOOR OF THE BASIN WITH 12" WIRE STAPLES, APPROXIMATELY 1' APART, ALONG THE BOTTOM AND SIDE SLOPES OF THE BASIN.



TYPICAL SECTION THRU STONE CHECK DAM

EARTHEN MATERIALS HANDLING PRACTICES FOR COMPLIANCE WITH CONSTRUCTION GENERAL PERMIT						
<p>details and specifications on this plan sheet will result in the construction being compliant with the Ground Stabilization and Materials Handling section of the G01 Construction General Permit (Sections E and F, respectively). The project must comply with the Erosion and Sediment Control plan approved by the authority having jurisdiction. All details and specifications shown on this sheet apply to site conditions and the delegated authority having jurisdiction.</p>						
LAND STABILIZATION						
Required Ground Stabilization Timeframes						
Option	Stabilize within this many calendar days after ceasing land disturbance	Timeframe variations				
Dikes, swales, and slopes	7	None				
Waterways	7	None				
Other than 4:1 slopes	7	If slopes are 10' or less in length and are not steeper than 2:1, 14 days are allowed				
4:1	14	-7 days for slopes greater than 50' in length and with slopes steeper than 4:1 -7 days for perimeter dikes, swales, ditches, perimeter slopes and HQW Zones -10 days for Falls Lake Watershed				
:1	14	-7 days for perimeter dikes, swales, ditches, perimeter slopes and HQW Zones -10 days for Falls Lake Watershed unless there is zero slope				
<p>Permanent cessation of construction activities, any areas with temporary structures shall be converted to permanent ground stabilization as soon as possible longer than 90 calendar days after the last land disturbing activity ground stabilization shall be maintained in a manner to render the site resistant to accelerated erosion until permanent ground stabilization is achieved.</p>						
STABILIZATION SPECIFICATION						
<p>Stabilize sufficiently so that rain will not dislodge the soil. Use one of the methods below:</p> <table border="1"> <thead> <tr> <th>Temporary Stabilization</th> <th>Permanent Stabilization</th> </tr> </thead> <tbody> <tr> <td>Soil covered with straw or other mulches and tackifiers</td> <td> <ul style="list-style-type: none"> Permanent grass seed covered with straw or other mulches and tackifiers Geotextile fabrics such as permanent soil reinforcement matting Hydroseeding Shrubs or other permanent plantings covered with mulch Uniform and evenly distributed ground cover sufficient to restrain erosion Structural methods such as concrete, asphalt or retaining walls Rolled erosion control products with grass seed </td> </tr> </tbody> </table>			Temporary Stabilization	Permanent Stabilization	Soil covered with straw or other mulches and tackifiers	<ul style="list-style-type: none"> Permanent grass seed covered with straw or other mulches and tackifiers Geotextile fabrics such as permanent soil reinforcement matting Hydroseeding Shrubs or other permanent plantings covered with mulch Uniform and evenly distributed ground cover sufficient to restrain erosion Structural methods such as concrete, asphalt or retaining walls Rolled erosion control products with grass seed
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PAMS (PAMS) AND FLOCCULANTS						
<p>Plants that are appropriate for the soils being exposed during construction, selecting from the NC DWR List of Approved PAMS/Flocculants.</p> <p>Plants at or before the inlets to Erosion and Sediment Control Measures.</p> <p>Plants at the concentrations specified in the NC DWR List of Approved PAMS/Flocculants and in accordance with the manufacturer's instructions.</p> <p>Discharging area for containment of treated Stormwater before discharging</p> <p>Plants in leak-proof containers that are kept under storm-resistant cover and by secondary containment structures.</p>						
EQUIPMENT AND VEHICLE MAINTENANCE						
<ol style="list-style-type: none"> Maintain vehicles and equipment to prevent discharge of fluids. Provide drip pans under any stored equipment. Identify leaks and repair as soon as feasible, or remove leaking equipment from the project. Collect all spent fluids, store in separate containers and properly dispose as hazardous waste (recycle when possible). Remove leaking vehicles and construction equipment from service until the problem has been corrected. Bring used fuels, lubricants, coolants, hydraulic fluids and other petroleum products to a recycling or disposal center that handles these materials. 						
LITTER, BUILDING MATERIAL AND LAND CLEARING WASTE						
<ol style="list-style-type: none"> Never bury or burn waste. Place litter and debris in approved waste containers. Provide a sufficient number and size of waste containers (e.g. dumpster, trash receptacle) on site to contain construction and domestic wastes. Locate waste containers at least 50 feet away from storm drain inlets and surface waters unless no other alternatives are reasonably available. Locate waste containers on areas that do not receive substantial amounts of runoff from upland areas and does not drain directly to a storm drain, stream or wetland. Cover waste containers at the end of each workday and before storm events or provide secondary containment. Repair or replace damaged waste containers. Anchor all lightweight items in waste containers during times of high winds. Empty waste containers as needed to prevent overflow. Clean up immediately if containers overflow. Dispose waste off-site at an approved disposal facility. On business days, clean up and dispose of waste in designated waste containers. 						
PAINT AND OTHER LIQUID WASTE						
<ol style="list-style-type: none"> Do not dump paint and other liquid waste into storm drains, streams or wetlands. Locate paint washouts at least 50 feet away from storm drain inlets and surface waters unless no other alternatives are reasonably available. Contain liquid wastes in a controlled area. Containment must be labeled, sized and placed appropriately for the needs of site. Prevent the discharge of soaps, solvents, detergents and other liquid wastes from construction sites. 						
PORTABLE TOILETS						
<ol style="list-style-type: none"> Install portable toilets on level ground, at least 50 feet away from storm drains, streams or wetlands unless there is no alternative reasonably available. If 50 foot offset is not attainable, provide relocation of portable toilet behind silt fence or place on a gravel pad and surround with sand bags. Provide staking or anchoring of portable toilets during periods of high winds or in high foot traffic areas. Monitor portable toilets for leaking and properly dispose of any leaked material. Utilize a licensed sanitary waste hauler to remove leaking portable toilets and replace with properly operating unit. 						
EARTHEN STOCKPILE MANAGEMENT						
<ol style="list-style-type: none"> Show stockpile locations on plans. Locate earthen-material stockpile areas at least 50 feet away from storm drain inlets, sediment basins, perimeter sediment controls and surface waters unless it can be shown no other alternatives are reasonably available. Protect stockpile with silt fence installed along toe of slope with a minimum offset of five feet from the top of stockpile. Provide stable stone access point when feasible. Stabilize stockpile within the timeframes provided on this sheet and in accordance with the approved plan and any additional requirements. Soil stabilization is defined as vegetative, physical or chemical coverage techniques that will restrain accelerated erosion on disturbed soils for temporary or permanent control needs. 						


NCG01 GROUND STABILIZATION AND MATERIALS HANDLING

EFFECTIVE: 04/01/19

PART III SELF-INSPECTION, RECORDKEEPING AND REPORTING		PART III SELF-INSPECTION, RECORDKEEPING AND REPORTING													
SPECIFICATION		SECTION B: RECORDKEEPING													
1. E&SC Plan Documentation		<p>The approved E&SC plan as well as any approved deviation shall be kept on the site. The approved E&SC plan must be kept up-to-date throughout the coverage under this permit. The following items pertaining to the E&SC plan shall be kept on site and available for inspection at all times during normal business hours.</p> <table border="1"> <thead> <tr> <th>Item to Document</th><th>Documentation Requirements</th></tr> </thead> <tbody> <tr> <td>(a) Each E&SC measure has been installed and does not significantly deviate from the locations, dimensions and relative elevations shown on the approved E&SC plan.</td><td>Initial and date each E&SC measure on a copy of the approved E&SC plan or complete, date and sign an inspection report that lists each E&SC measure shown on the approved E&SC plan. This documentation is required upon the initial installation of the E&SC measures or if the E&SC measures are modified after initial installation.</td></tr> <tr> <td>(b) A phase of grading has been completed.</td><td>Initial and date a copy of the approved E&SC plan or complete, date and sign an inspection report to indicate completion of the construction phase.</td></tr> <tr> <td>(c) Ground cover is located and installed in accordance with the approved E&SC plan.</td><td>Initial and date a copy of the approved E&SC plan or complete, date and sign an inspection report to indicate compliance with approved ground cover specifications.</td></tr> <tr> <td>(d) The maintenance and repair requirements for all E&SC measures have been performed.</td><td>Complete, date and sign an inspection report.</td></tr> <tr> <td>(e) Corrective actions have been taken to E&SC measures.</td><td>Initial and date a copy of the approved E&SC plan or complete, date and sign an inspection report to indicate the completion of the corrective action.</td></tr> </tbody> </table>		Item to Document	Documentation Requirements	(a) Each E&SC measure has been installed and does not significantly deviate from the locations, dimensions and relative elevations shown on the approved E&SC plan.	Initial and date each E&SC measure on a copy of the approved E&SC plan or complete, date and sign an inspection report that lists each E&SC measure shown on the approved E&SC plan. This documentation is required upon the initial installation of the E&SC measures or if the E&SC measures are modified after initial installation.	(b) A phase of grading has been completed.	Initial and date a copy of the approved E&SC plan or complete, date and sign an inspection report to indicate completion of the construction phase.	(c) Ground cover is located and installed in accordance with the approved E&SC plan.	Initial and date a copy of the approved E&SC plan or complete, date and sign an inspection report to indicate compliance with approved ground cover specifications.	(d) The maintenance and repair requirements for all E&SC measures have been performed.	Complete, date and sign an inspection report.	(e) Corrective actions have been taken to E&SC measures.	Initial and date a copy of the approved E&SC plan or complete, date and sign an inspection report to indicate the completion of the corrective action.
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2. Additional Documentation to be Kept on Site		<p>In addition to the E&SC plan documents above, the following items shall be kept on the site and available for inspectors at all times during normal business hours, unless the Division provides a site-specific exemption based on unique site conditions that make this requirement not practical:</p> <ol style="list-style-type: none"> This General Permit as well as the Certificate of Coverage, after it is received. Records of inspections made during the previous twelve months. The permittee shall record the required observations on the Inspection Record Form provided by the Division or a similar inspection form that includes all the required elements. Use of electronically-available records in lieu of the required paper copies will be allowed if shown to provide equal access and utility as the hard-copy records. 													
3. Documentation to be Retained for Three Years		<p>All data used to complete the e NOI and all inspection records shall be maintained for a period of three years after project completion and made available upon request. [40 CFR 122.41]</p>													
PART II, SECTION G, ITEM (4) DRAW DOWN OF SEDIMENT BASINS FOR MAINTENANCE OR CLOSE OUT		PART III SELF-INSPECTION, RECORDKEEPING AND REPORTING													
<p>Traps that receive runoff from drainage areas of one acre or more shall use outlet structures that withdraw water from the surface when these devices need to be drawn down to close out unless this is infeasible. The circumstances in which it is not feasible to withdraw water from the surface shall be rare (for example, times with extended cold weather). Withdrawals from sediment basins shall be allowed only when all of the following criteria have been met:</p> <p>An authority has been provided with documentation of the non-surface withdrawal and the specific time periods or conditions in which it will occur. The non-surface withdrawal will continue until the E&SC plan authority has approved these items.</p> <p>Non-surface withdrawal has been reported as an anticipated bypass in accordance with Part III, Section C, Item (2)(c) and (d) of this permit.</p> <p>Discharges are treated with controls to minimize discharges of pollutants from stormwater that is removed from the sediment basin. Examples of appropriate controls include, designed and maintained dewatering tanks, weir tanks, and filtration systems,</p> <p>Land areas of the sites or a properly designed stone pad is used to the extent feasible at the outlet of the dewatering treatment devices described in Item (c) above, and devices such as check dams, sediment traps, and riprap are provided at the discharge points of all dewatering devices, and</p> <p>Water removed from the dewatering treatment devices described in Item (c) above is disposed of in a manner that does not cause deposition of sediment into waters of the United States.</p>		<p>Permittees shall report the following occurrences:</p> <ol style="list-style-type: none"> Visible sediment deposition in a stream or wetland. Oil spills if: <ul style="list-style-type: none"> They are 25 gallons or more, They are less than 25 gallons but cannot be cleaned up within 24 hours, They cause sheen on surface waters (regardless of volume), or They are within 100 feet of surface waters (regardless of volume). Releases of hazardous substances in excess of reportable quantities under Section 311 of the Clean Water Act (Ref: 40 CFR 110.3 and 40 CFR 117.3) or Section 102 of CERCLA (Ref: 40 CFR 302.4) or G.S. 143-215.85. Anticipated bypasses and unanticipated bypasses. Noncompliance with the conditions of this permit that may endanger health or the environment. <p>2. Reporting Timeframes and Other Requirements</p> <p>After a permittee becomes aware of an occurrence that must be reported, he shall contact the appropriate Division regional office within the timeframes and in accordance with the other requirements listed below. Occurrences outside normal business hours may also be reported to the Department's Environmental Emergency Center personnel at (800) 858-0368.</p> <table border="1"> <thead> <tr> <th>Occurrence</th><th>Reporting Timeframes (After Discovery) and Other Requirements</th></tr> </thead> <tbody> <tr> <td>(a) Visible sediment deposition in a stream or wetland</td><td> <ul style="list-style-type: none"> Within 24 hours, an oral or electronic notification. Within 7 calendar days, a report that contains a description of the sediment and actions taken to address the cause of the deposition. Division staff may waive the requirement for a written report on a case-by-case basis. If the stream is named on the NC 303(d) list as impaired for sediment-related causes, the permittee may be required to perform additional monitoring, inspections or apply more stringent practices if staff determine that additional requirements are needed to assure compliance with the federal or state impaired-waters conditions. </td></tr> <tr> <td>(b) Oil spills and release of hazardous substances per Item 1(b)-(c) above</td><td> <ul style="list-style-type: none"> Within 24 hours, an oral or electronic notification. The notification shall include information about the date, time, nature, volume and location of the spill or release. </td></tr> <tr> <td>(c) Anticipated bypasses [40 CFR 122.41(m)(3)]</td><td> <ul style="list-style-type: none"> A report at least ten days before the date of the bypass, if possible. 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<p>NIC 01. SELF-INSPECTION, RECORDKEEPING AND REPORTING</p>		 <p>NORTH CAROLINA Environmental Quality</p>													

NCG01 SELF INSPECTION, RECORDKEEPING AND REPORTING

EFFECTIVE: 04/01/19

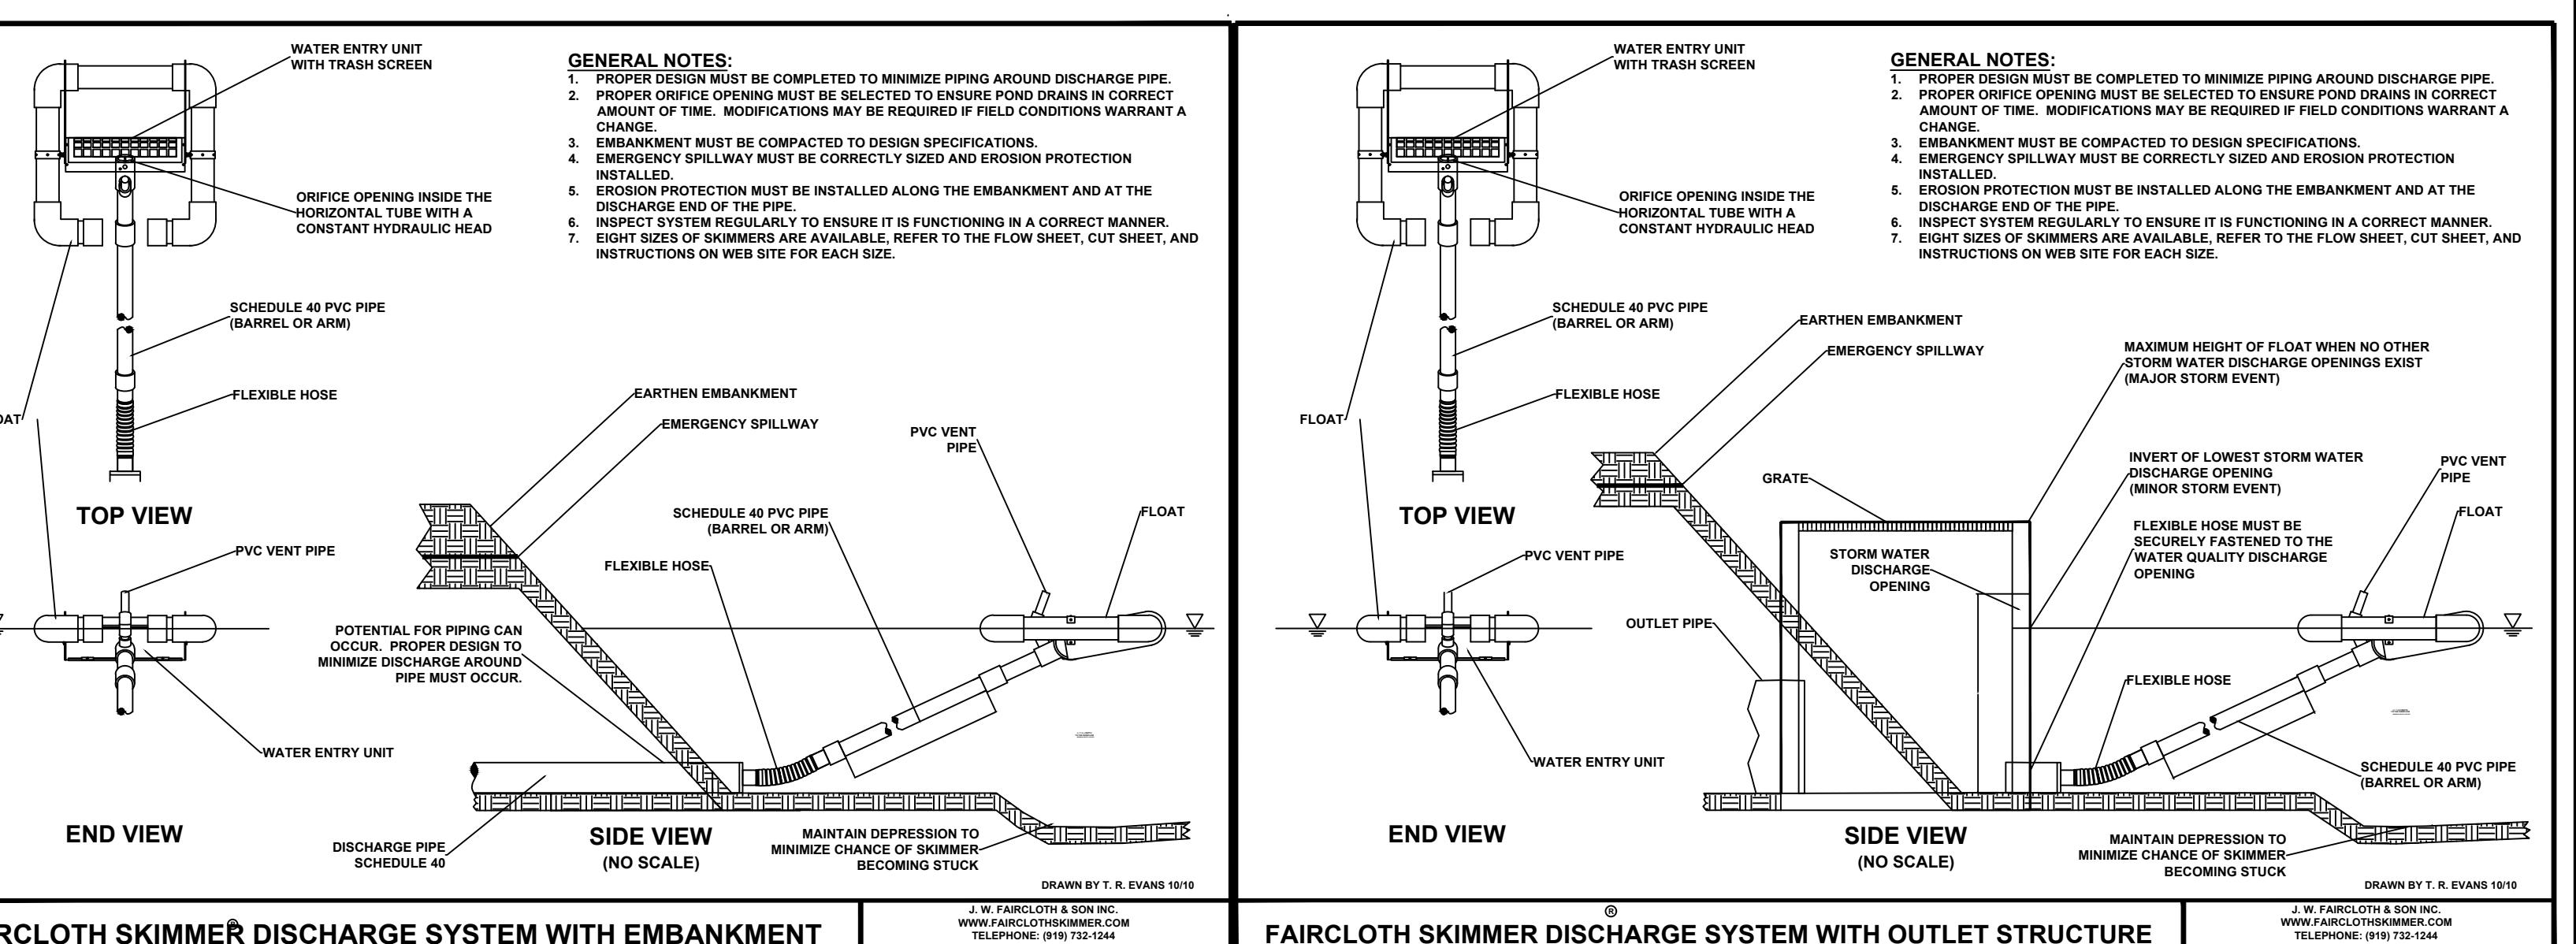

RCLCLOTH SKIMMER[®] DISCHARGE SYSTEM WITH EMBANKMENT

FAIRCLOTH SKIMMER DISCHARGE SYSTEM WITH OUTLET STRUCTURE

A circular notary seal for North Carolina Professional Notaries, Inc. The outer ring contains the text "NOTARY PUBLIC", "NORTH CAROLINA", "PROFESSIONAL", and "NOTARIES, INC.". In the center, it says "SEAL" above the number "25625". Below the seal is a large, stylized handwritten signature. At the bottom, the date "6/28/23" is printed.

CORPORATE SEAL:



LAND PLANNING ASSOCIATES OF NC, INC.
110 WEST 1ST AVENUE - SUITE A
EASLEY, SC 29640
864.242.6072 FAX 208.730.8214
design@lpainc.net

ingles

Markets Incorporated

STORE #140

5620 HENDERSONVILLE ROAD

FLETCHER NC

PROPERTY INFORMATION:

ISSUE FOR CONSTRUCTION:

BID DATE:

DRAWN BY: PCB

DESIGN BY: JDC

CHECKED BY: JDC

DATE: 4/19/22

SCALE: HORIZ. VERT.

JOB NUMBER: 21-018


EROSION CONTROL DETAILS

C-117

STORE #140
HENDERSONVILLE RD
FLETCHER NC

REVISIONS:

NO.	DATE	DESCRIPTION	BY
1	6/28/23	REVISED DETAILS PER INGLES	JDC

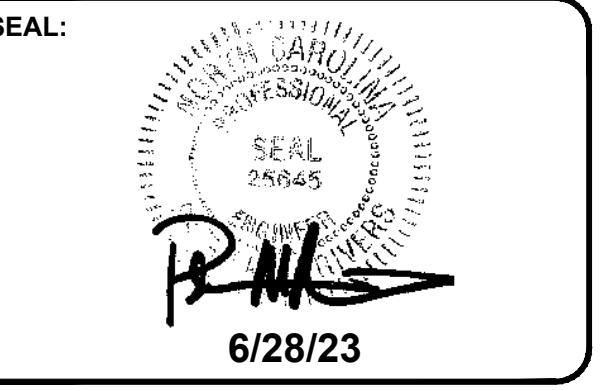

CORPORATE SEAL:



DBA
LAND PLANNING ASSOCIATES OF NC, INC.
110 WEST 1ST AVENUE - SUITE A
EASLEY, SC 29640
864.242.6072 FAX 208.730.8214
design@pa-inc.net



PROPERTY INFORMATION:


TAX MAP NUMBER: 9652316641, 9652316277
REFERENCE D.B. & PG: DB 3396 PG 597
ADDITIONAL INFO: 9652314347
DB 3464 PG 102

ISSUE FOR CONSTRUCTION:


PERMIT DATE:
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DUMPSTER
ENCLOSURE
DETAILS

C-120
STORE #140
HENDERSONVILLE ROAD
FLETCHER NC

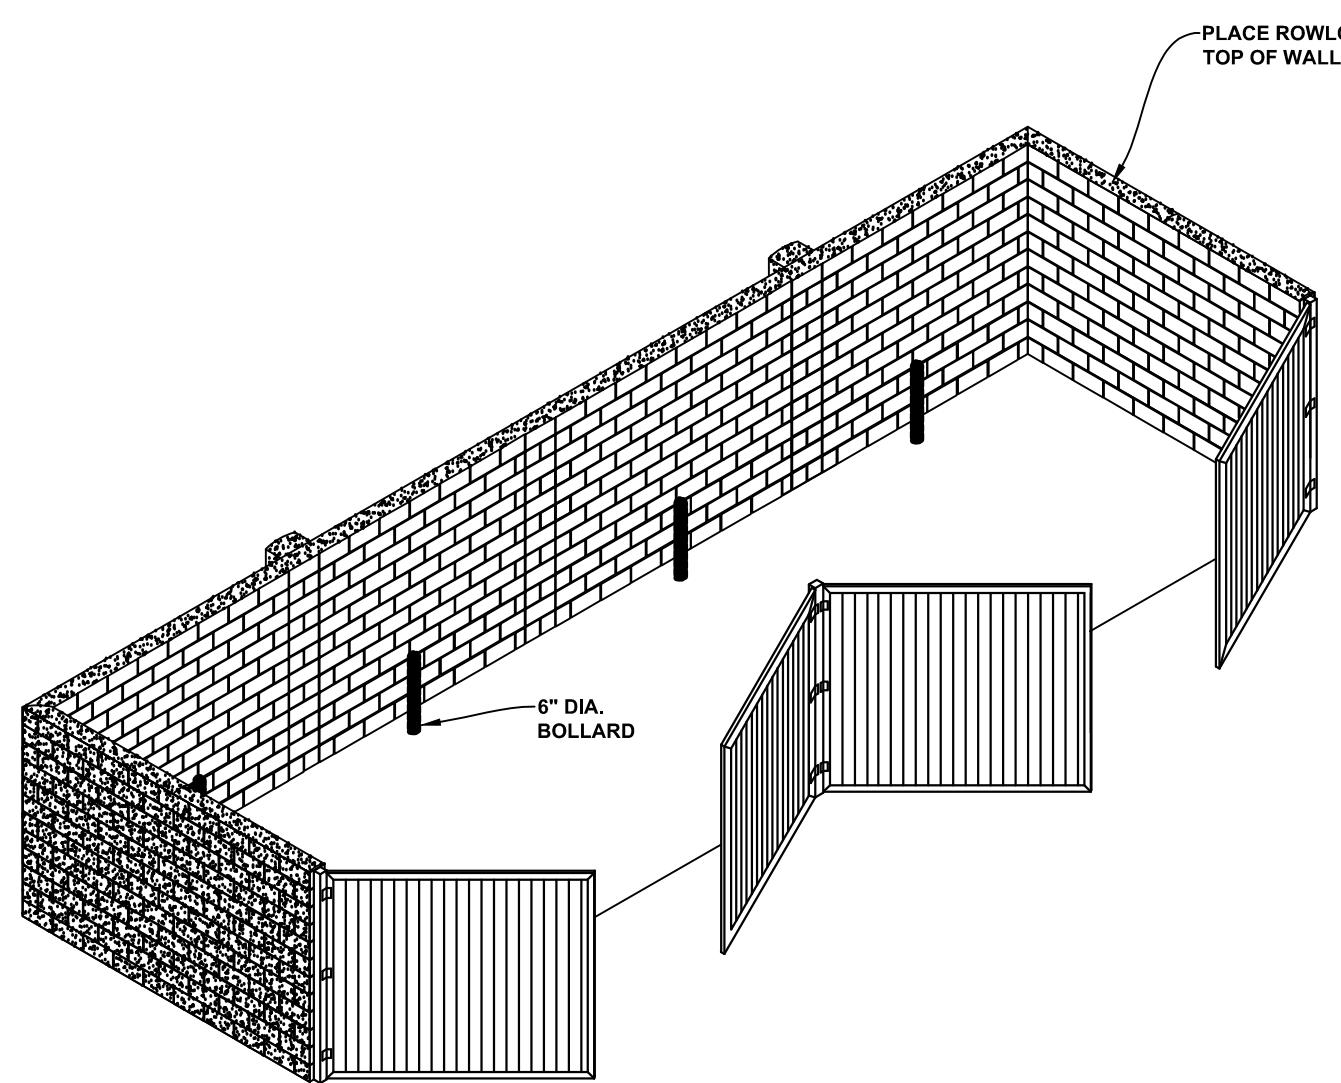


MASONRY BRICK DUMPSTER ENCLOSURE
DESIGN WIND SPEED: 130 M.P.H.
NOT TO SCALE

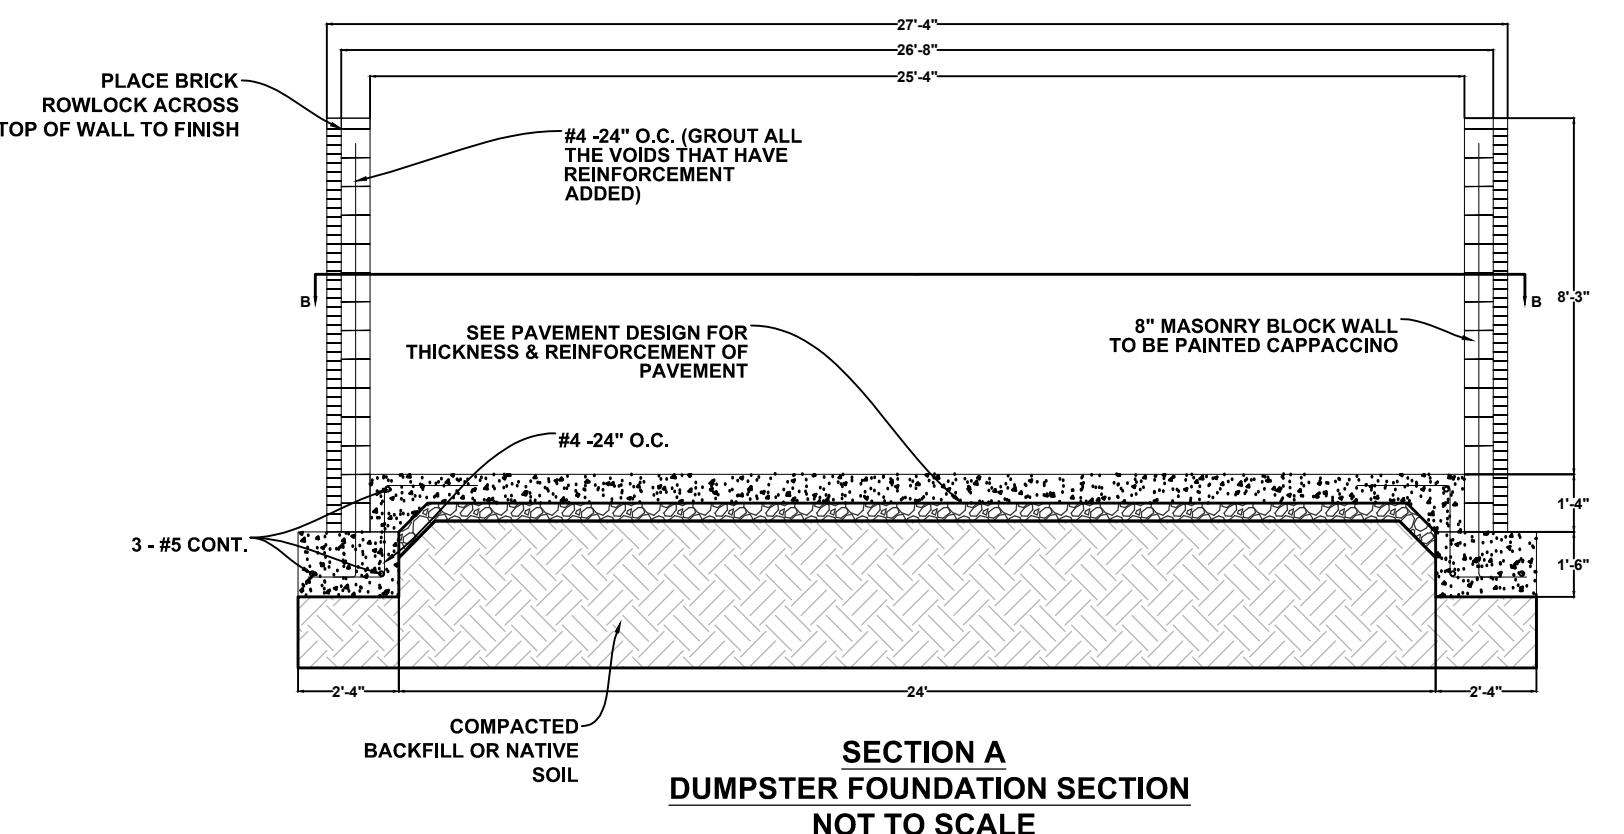



PREFABRICATED METAL GATE INFORMATION

- A - MOD. 800-GP 6" x 6" x 1/4" x 96" (156" TOTAL LENGTH WITH BURIAL) SQUARE STEEL GATE POSTS. (POWDER COATED)
- B - HEAVY DUTY LATCH & KEEPER HAND
- C - LIFTMASTER ELITE POWER HINGE 2 1/2 STEEL & 1/2 ALUMINUM GATE HINGE (2 EACH GATE PANEL)
- D - CANE BOLTS W/ KEEPERS
- E - BLACK ALUMINUM GATE PANEL (INGLES TO APPROVE)


DESIGN WIND SPEED: 130 M.P.H.

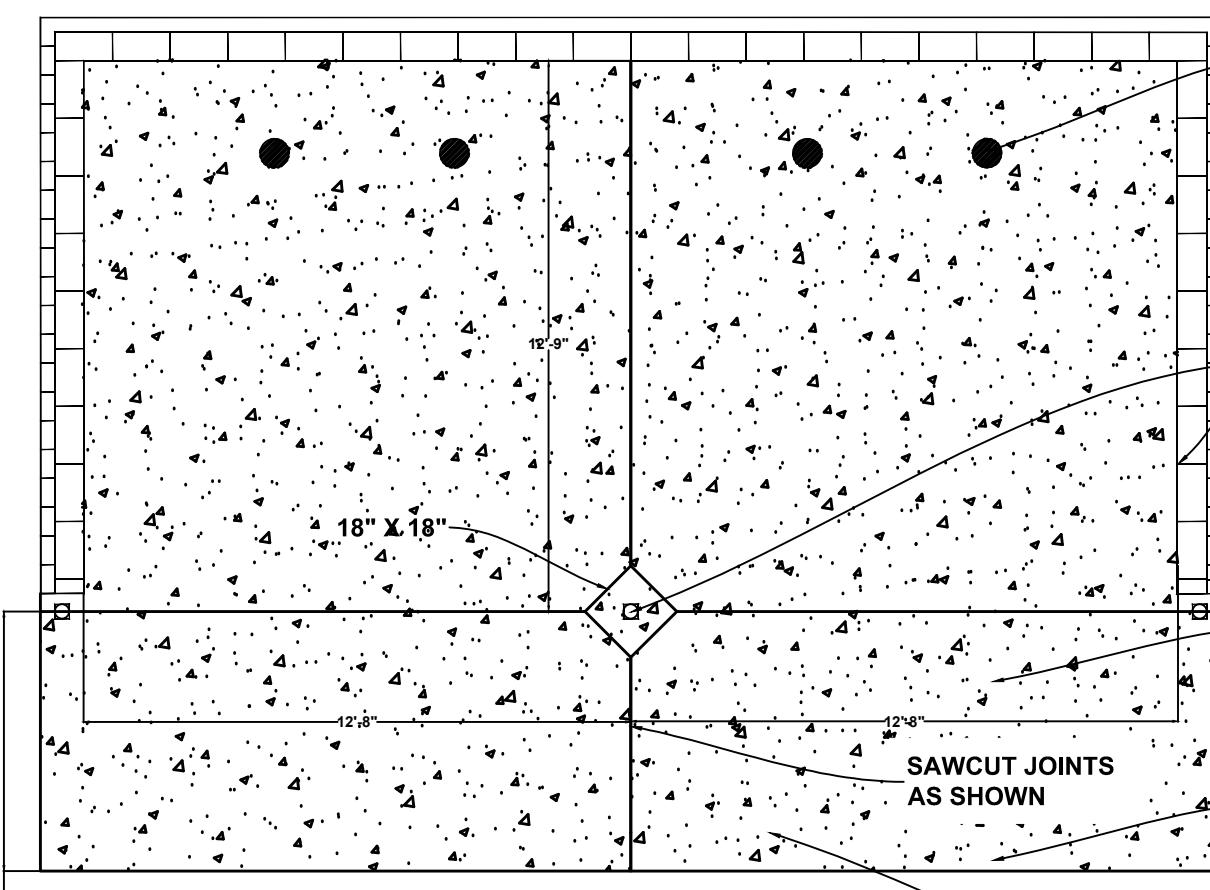



SEE DETAIL FOR CRACK CONTROL STEEL. ALL CONCRETE PANELS THAT EXCEED THE MAXIMUM LENGTH TO WIDTH RATIO OF 1.25:1 SHOULD HAVE NEARSURFACE "CRACK STEEL" CROSSED WITH #4 REBAR AT 24" O.C. BOTH DIRECTIONS WITH 2" CLEAR COVER AT THE ENDS OF BARS, 3" TO 4" COVER BETWEEN SAW CUTS, AND PLACED ON PROPER REBAR CHAIRS TO MAINTAIN 2" CLEAR COVER FROM THE TOP (5" CHAIR FOR 7" THICK PAVEMENT)

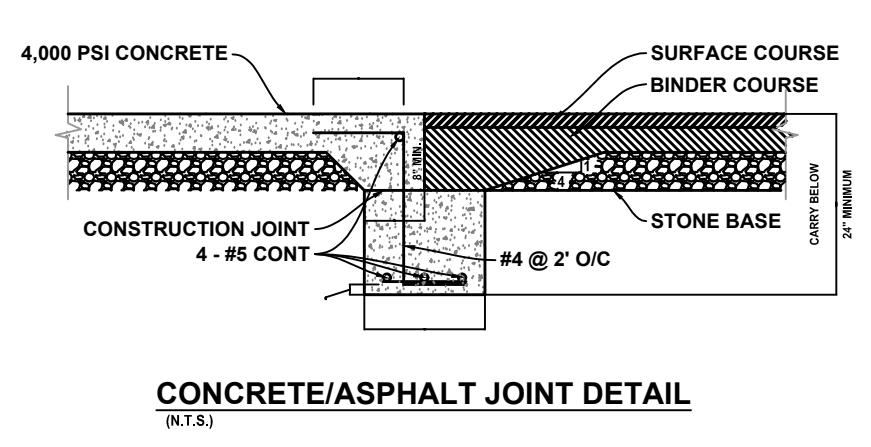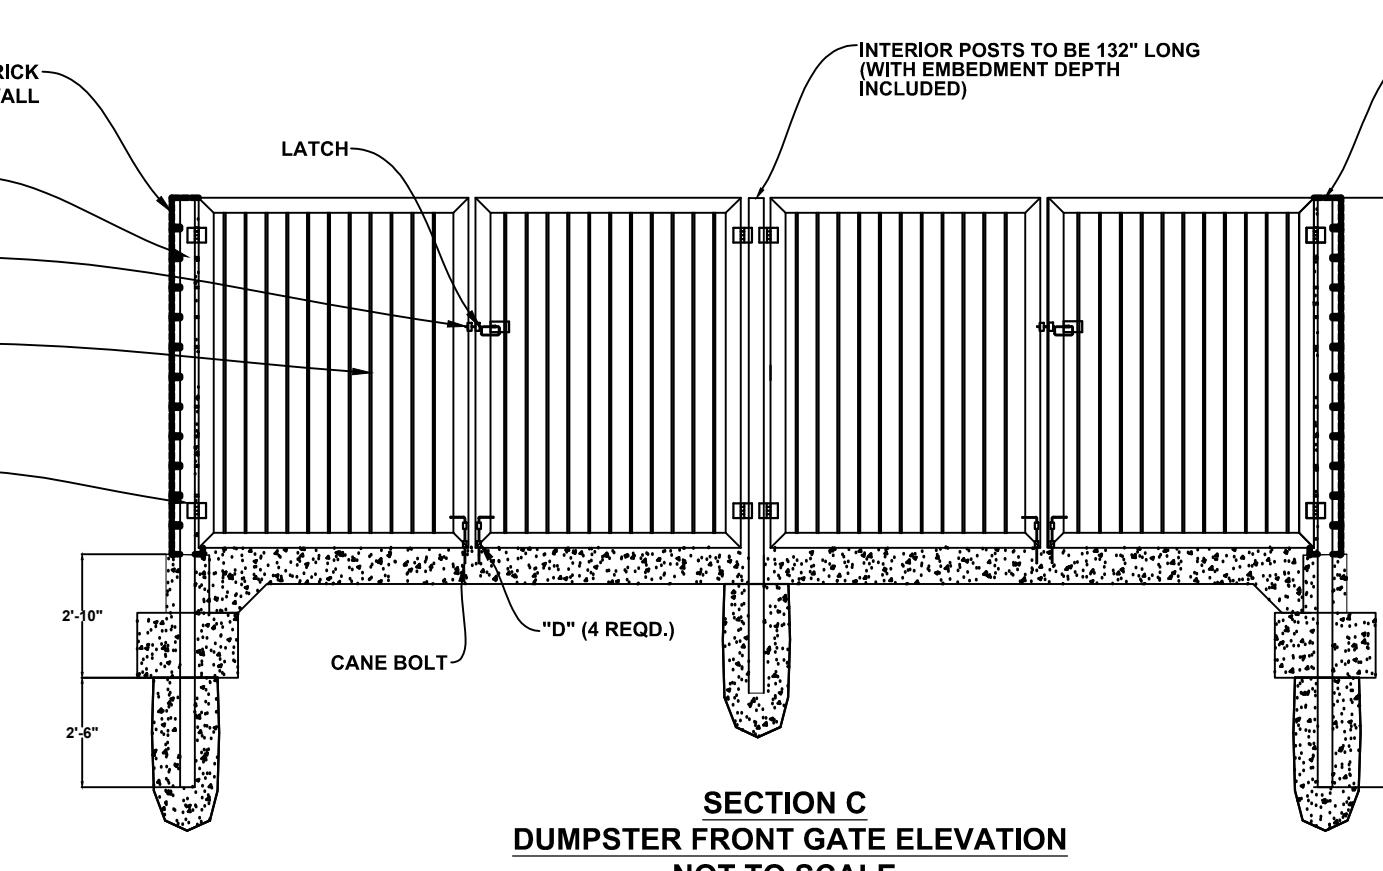

CONCRETE/ASPHALT JOINT DETAIL
(N.T.S.)

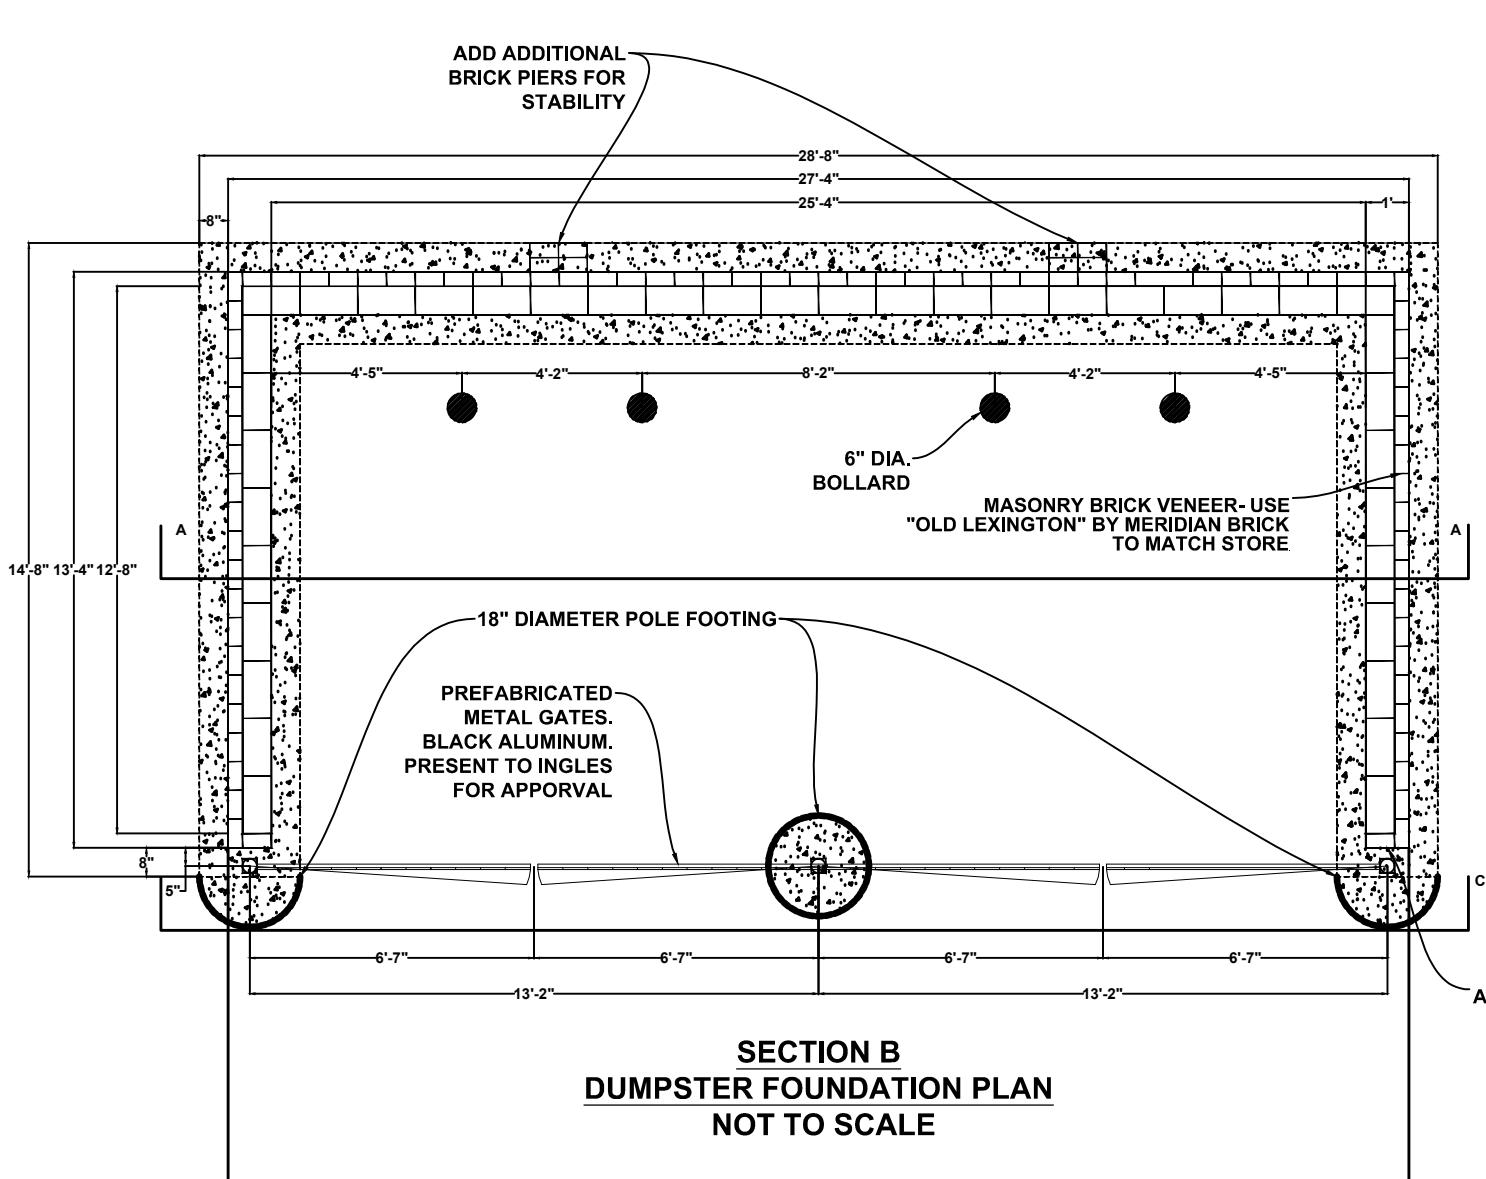


PROVIDE A MINIMUM 8" CONCRETE APRON IN FRONT OF ALL DUMPSTERS, UNLESS IT IS IN A POSITION WHERE NO CONCRETE PAVEMENT ALREADY EXISTS OR PAVEMENT DESIGN PLANS HAVE BEEN PROVIDED.

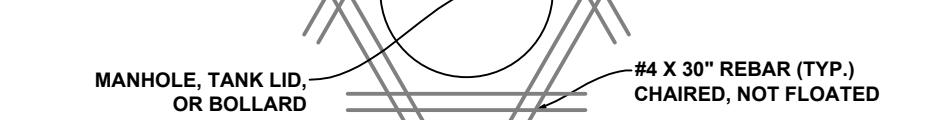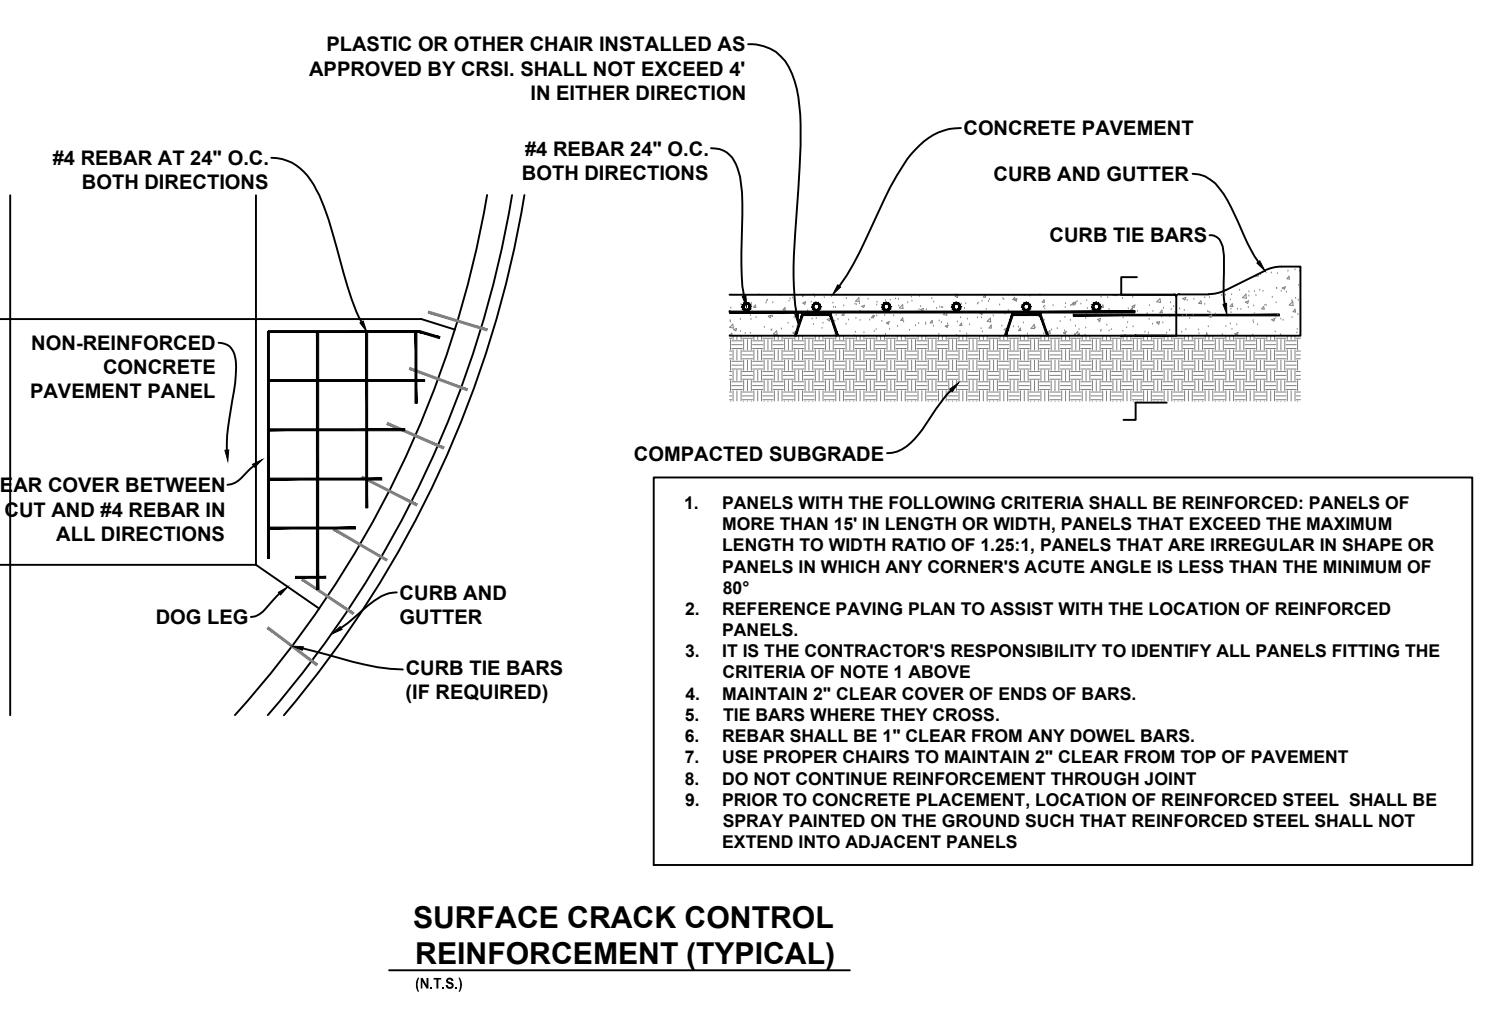

BOLLARD CRACK CONTROL REINFORCEMENT
(N.T.S.)

REVISIONS:

NO.	DATE	DESCRIPTION	BY
1	6/28/23	REVISED PER DOT COMMENTS	JDC

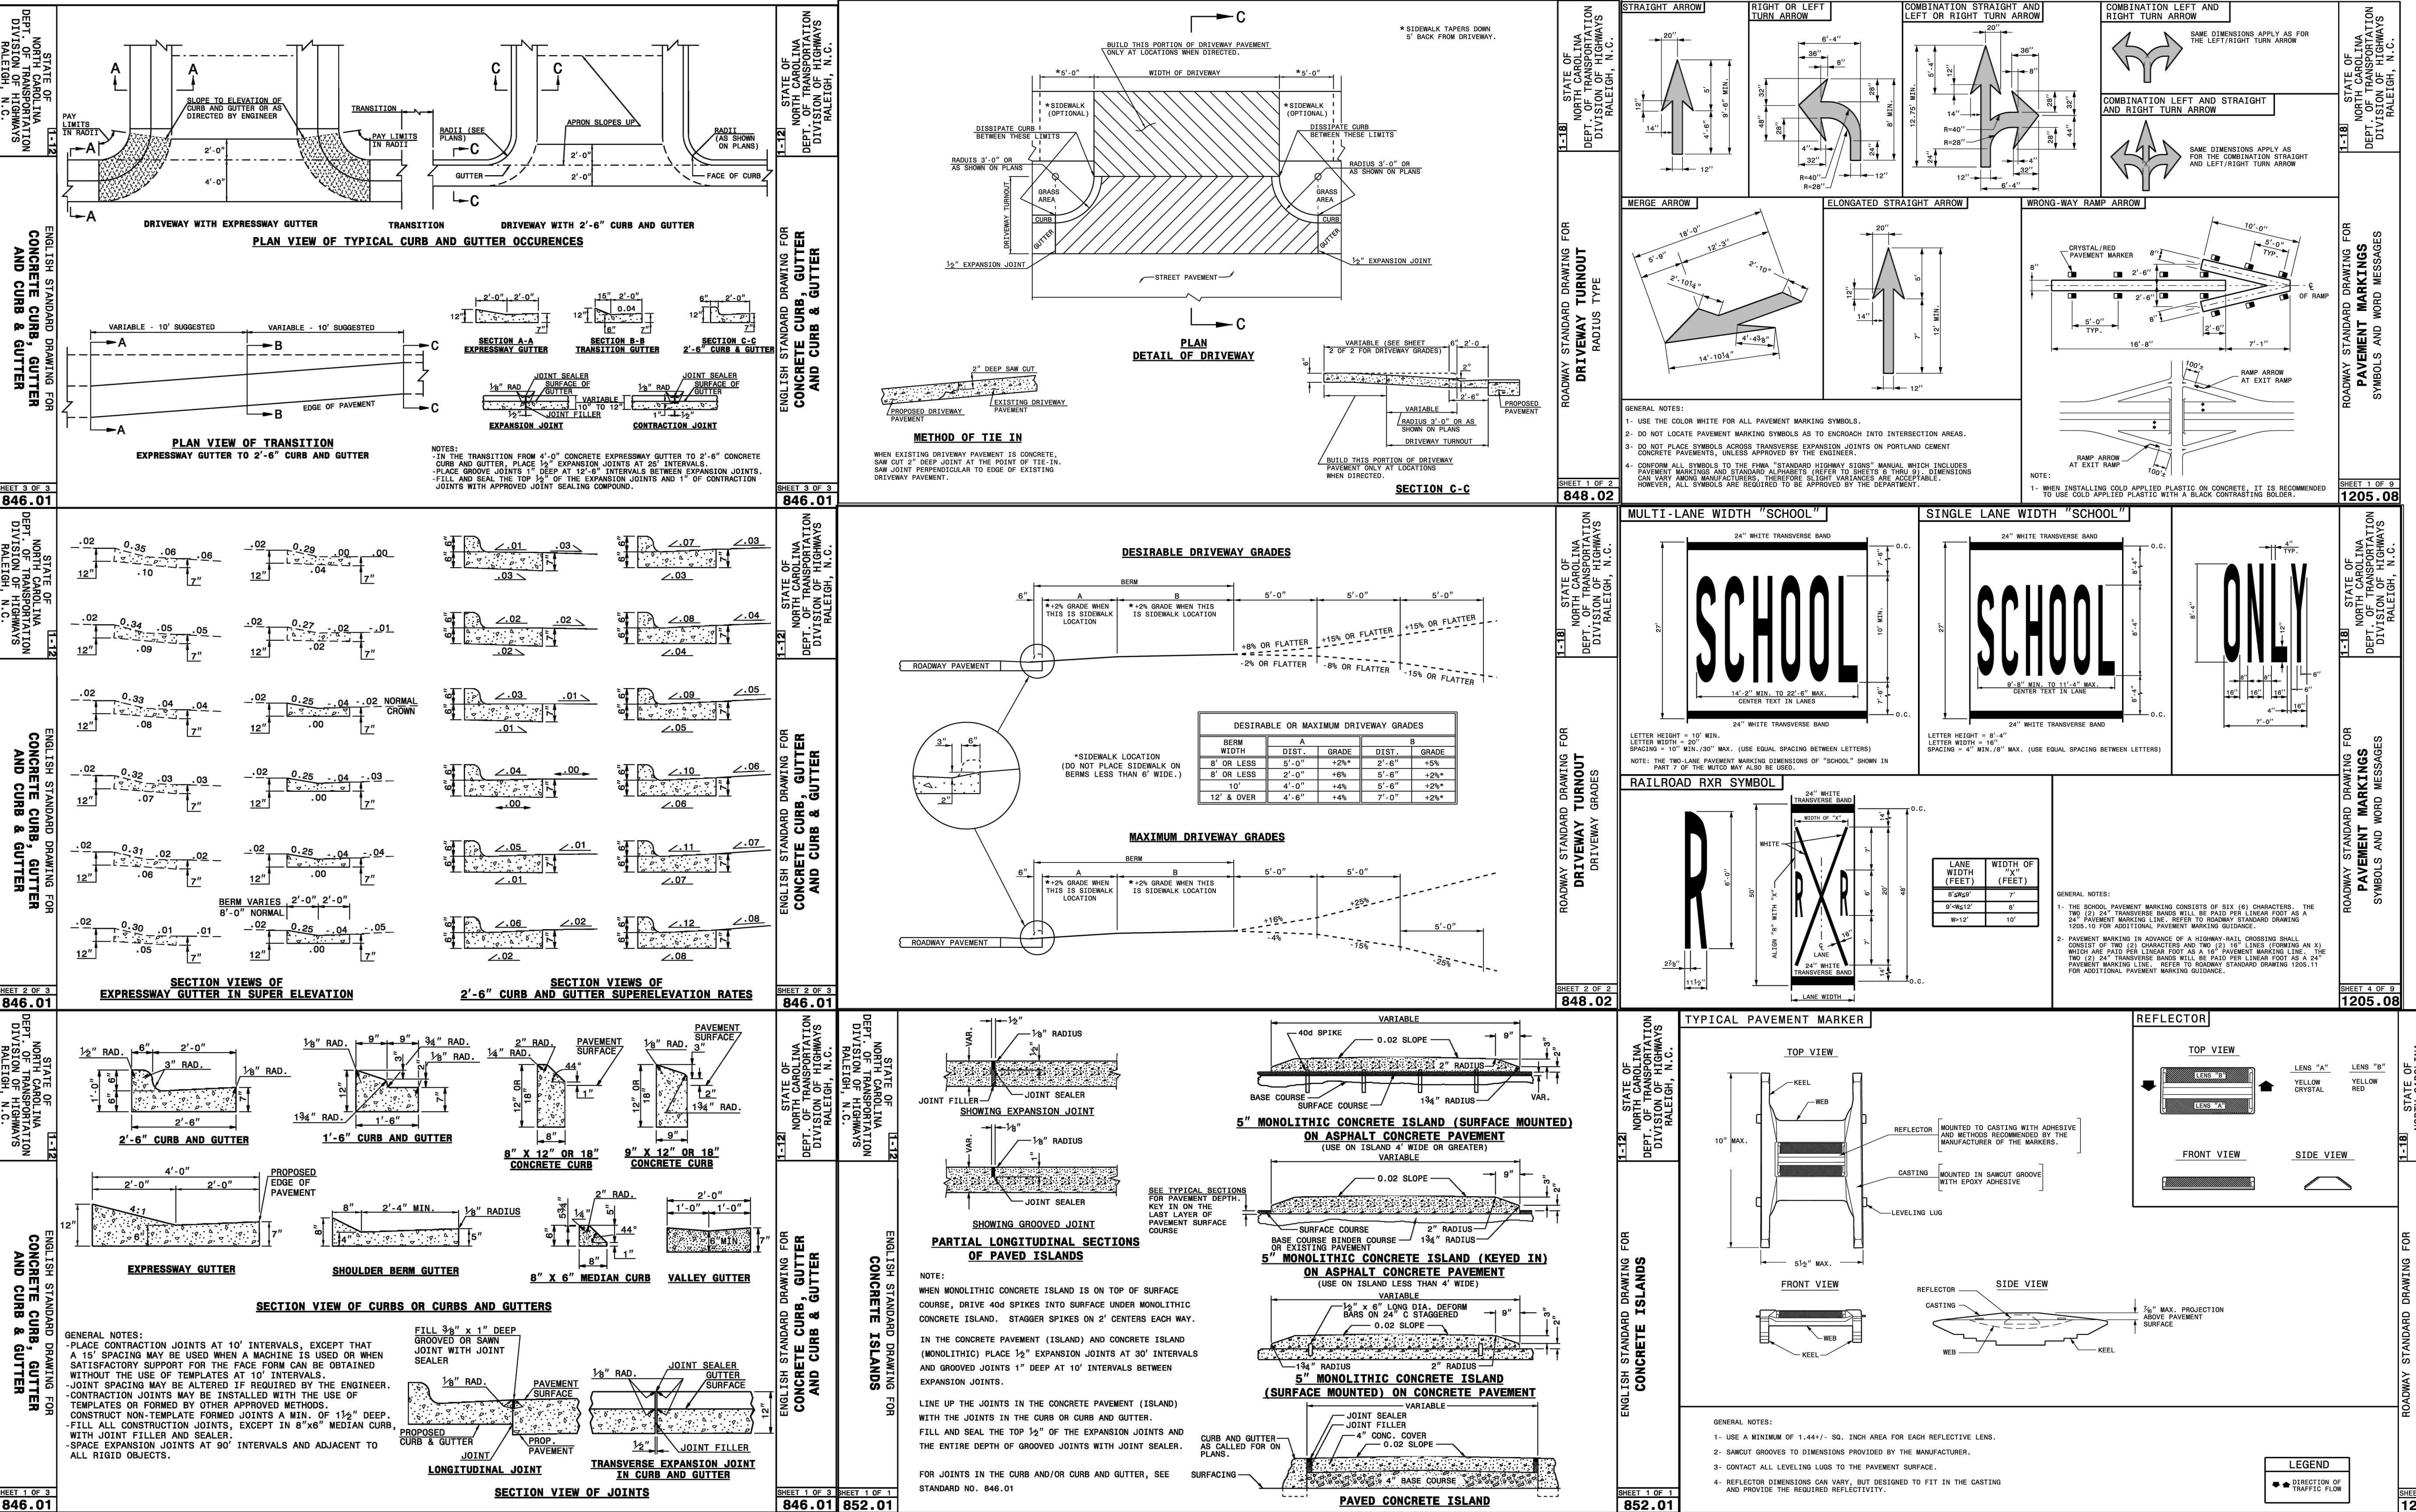

ingles
Markets Incorporated
STORE #140
5620 HENDERSONVILLE ROAD
FLETCHER NC

TAX MAP NUMBER: 9652316641, 9652316277

REFERENCE D.B. & PG: DB 3396 PG 597

ADDITIONAL INFO: 9652314347
DB 3464 PG 102

ISSUE FOR CONSTRUCTION:

PERMIT DATE:

BID DATE:

DRAWN BY: PCB

DESIGN BY: PCB

CHECKED BY: JDC

DATE: 4/19/22

SCALE: HORIZ. VERT.

JOB NUMBER: 21.018

NCDOT
DETAILS

C-121
STORE #140
HENDERSONVILLE ROAD
FLETCHER NC

NO.	DATE	DESCRIPTION	BY

SEAL:

 6/28/23

CORPORATE SEAL:



DBA
LAND PLANNING ASSOCIATES OF NC, INC.
 110 WEST 1ST AVENUE - SUITE A
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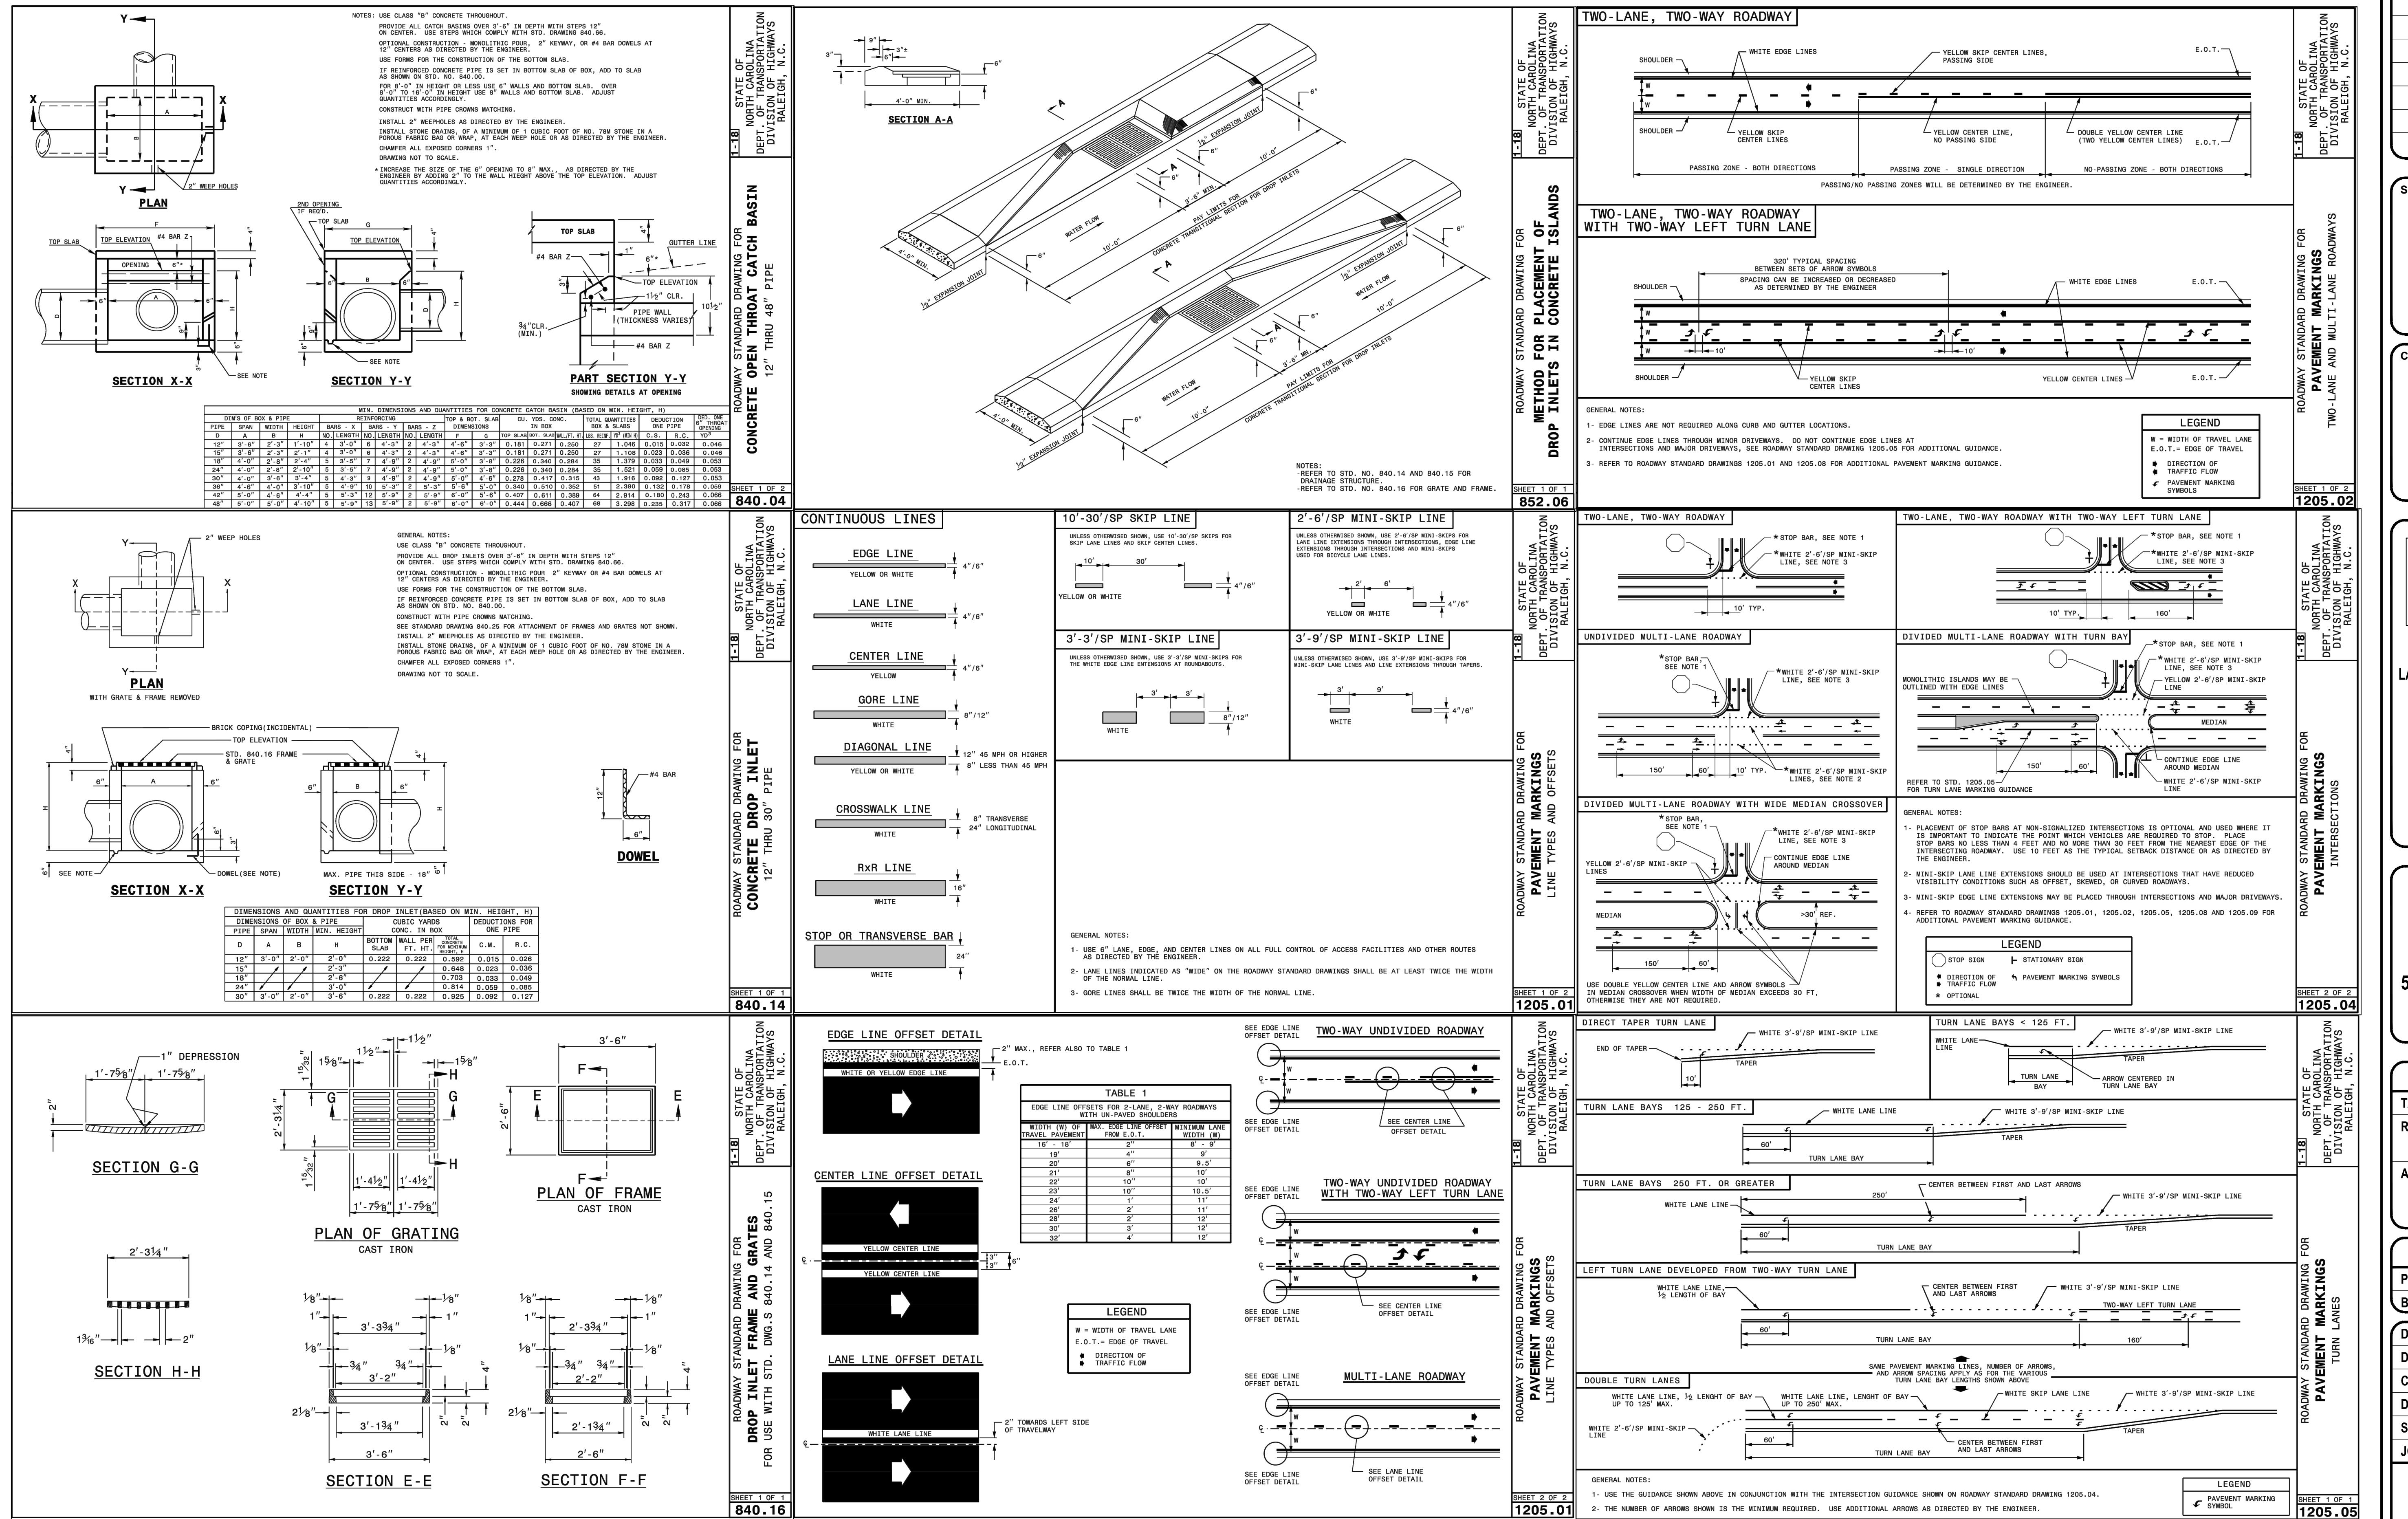
ADDITIONAL INFO:
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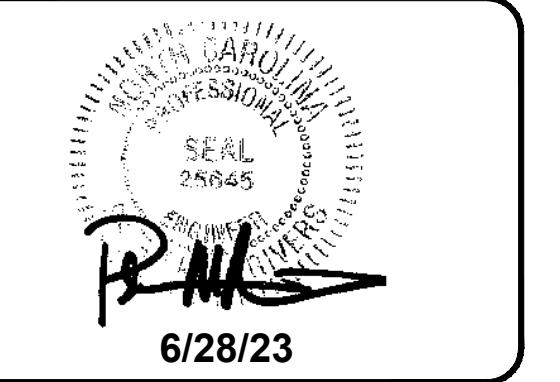
NCDOT DETAILS

C-121A
 STORE #140
 HENDERSONVILLE ROAD
 FLETCHER NC



REVISIONS:

NO.	DATE	DESCRIPTION	BY



CORPORATE SEAL:



DBA

LAND PLANNING ASSOCIATES OF NC, INC.
110 WEST 1ST AVENUE - SUITE A
EASLEY, SC 29640
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DB 3464 PG 102




ISSUE FOR CONSTRUCTION:	
PERMIT DATE:	
BID DATE:	

DRAWN BY:	PCB
DESIGN BY:	PCB
CHECKED BY:	JDC
DATE:	6/28/23
SCALE:	HORIZ. VERT.
JOB NUMBER:	21.018

NCDOT DETAILS

C-121B

STORE #140
HENDERSONVILLE ROAD
FLETCHER NC

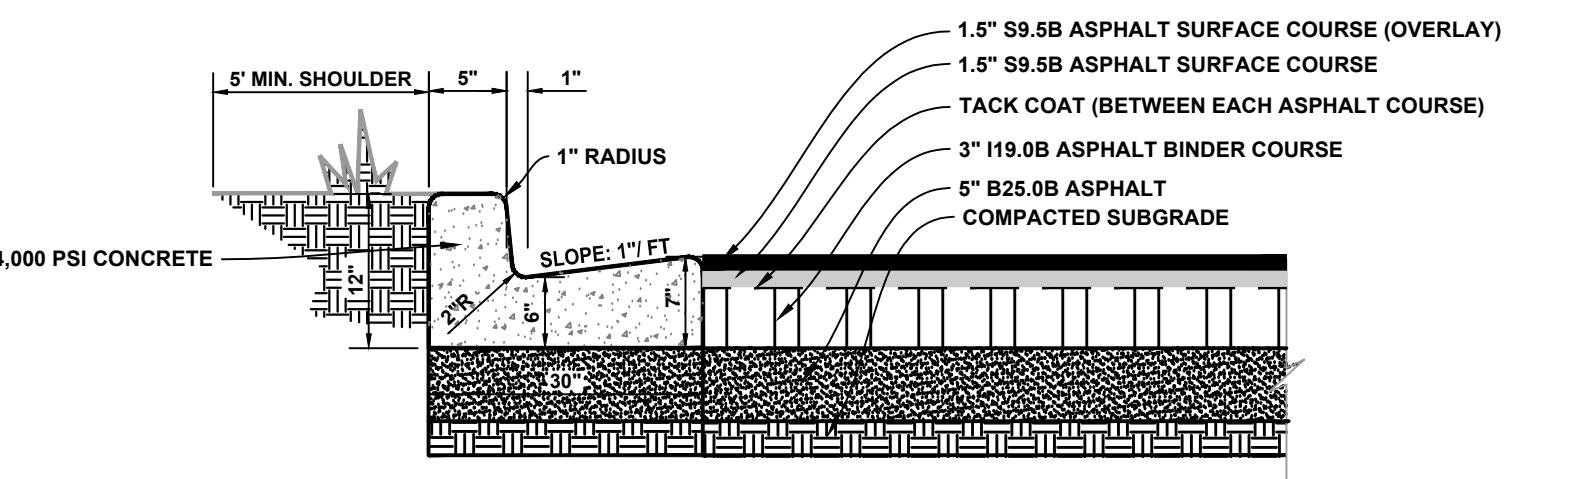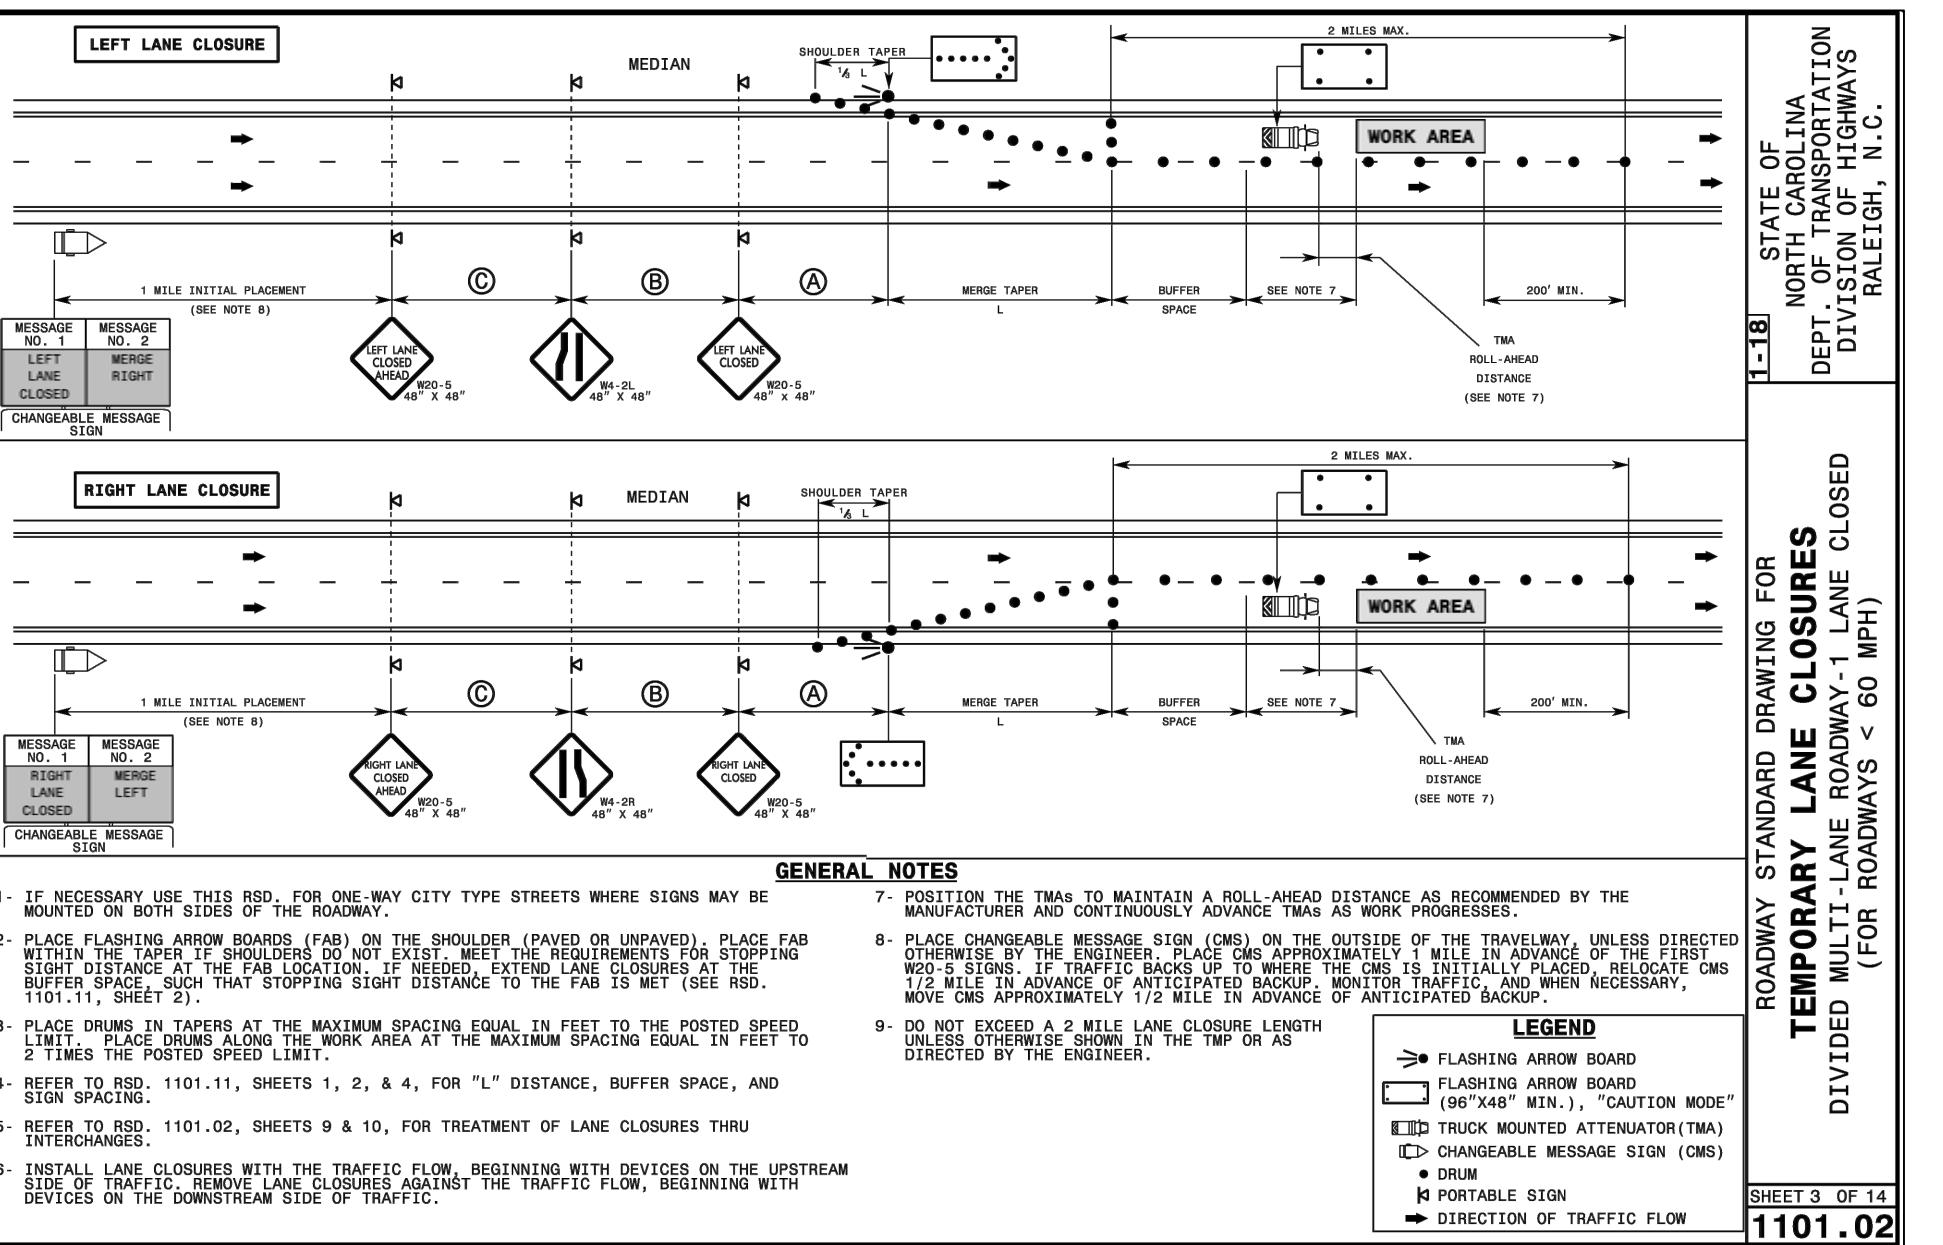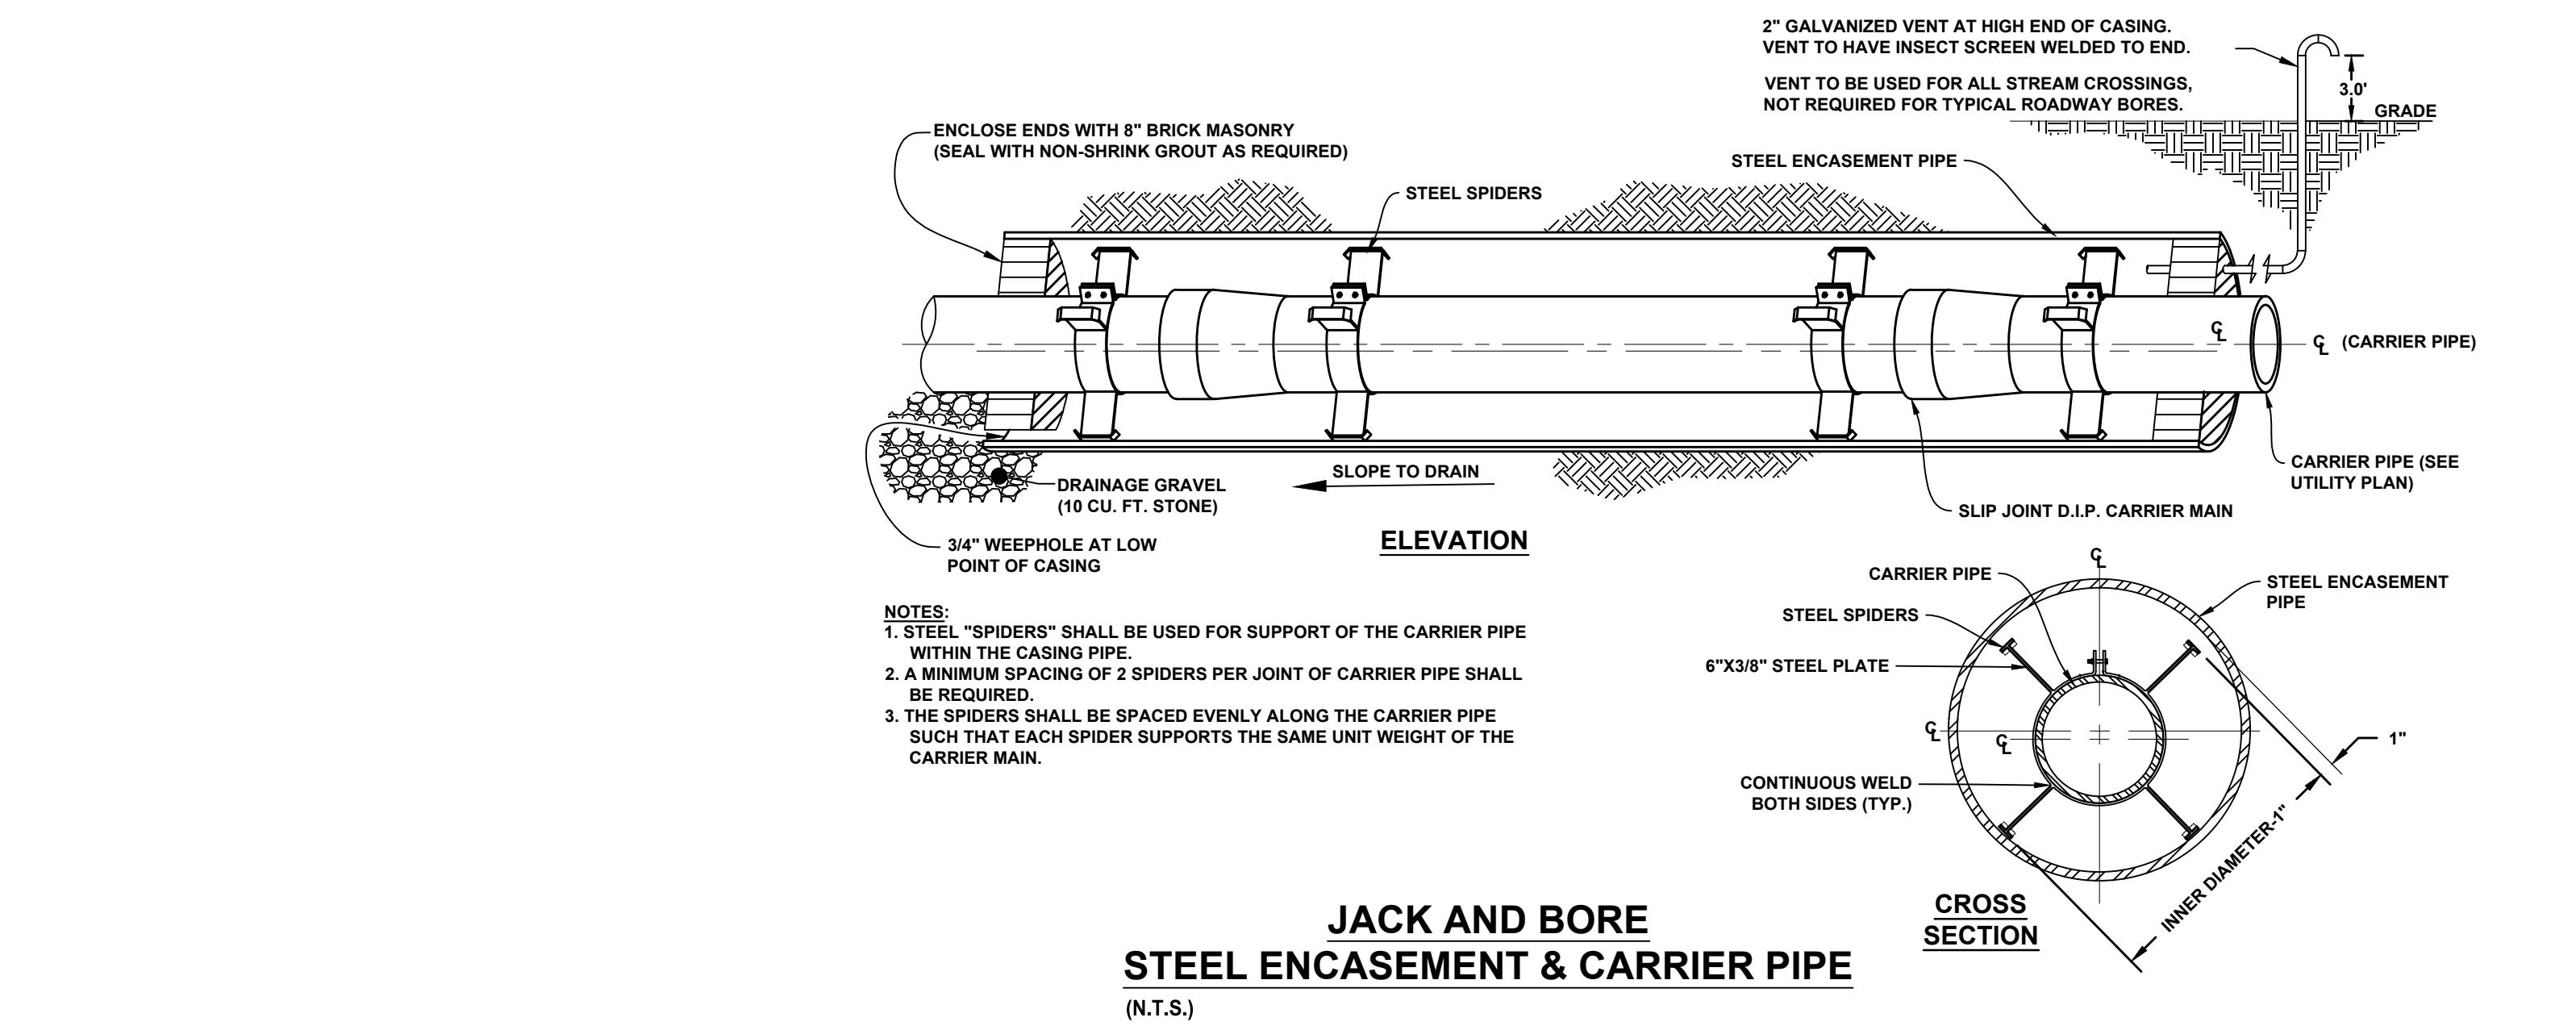

30" CONCRETE CURB & GUTTER WITH
NCDOT ASPHALT DETAIL SECTION
(N.T.S.)

MAXIMUM DISTANCE BETWEEN EXPANSION JOINTS = 40' O/C
EXPANSION JOINTS REQUIRED AT ALL STRUCTURES AND CURB RETURNS
(TO BE APPLIED FOR CURBING WITHIN THE DOT RIGHT OF WAY AND DOT
ASPHALT SECTIONS)

REVISIONS:

NO.	DATE	DESCRIPTION	BY
1	8/26/22	REVISED PER SITE CHANGES	SCW

SEAL:

8/26/22

CORPORATE SEAL:



DBA
LAND PLANNING ASSOCIATES OF NC, INC.
110 WEST 1ST AVENUE - SUITE A
EASLEY, SC 29640
864.242.6072
design@pa-inc.net

ingles

Markets Incorporated
STORE #140
5620 HENDERSONVILLE ROAD
FLETCHER NC

PROPERTY INFORMATION:

TAX MAP NUMBER: 9652316641, 9652316277
REFERENCE D.B. & PG: DB 3396 PG 597

ADDITIONAL INFO:

9652314347
DG 3464 PG 102

ISSUE FOR CONSTRUCTION:

PERMIT DATE:
BID DATE:

DRAWN BY: SCW
DESIGN BY: JDC

CHECKED BY: PMR


DATE: 4/19/22

SCALE: HORIZ. 1' = 50' VERT.

JOB NUMBER: 21.018

TOPSOIL PLAN**C-122**

STORE #140
HENDERSONVILLE ROAD
FLETCHER NC

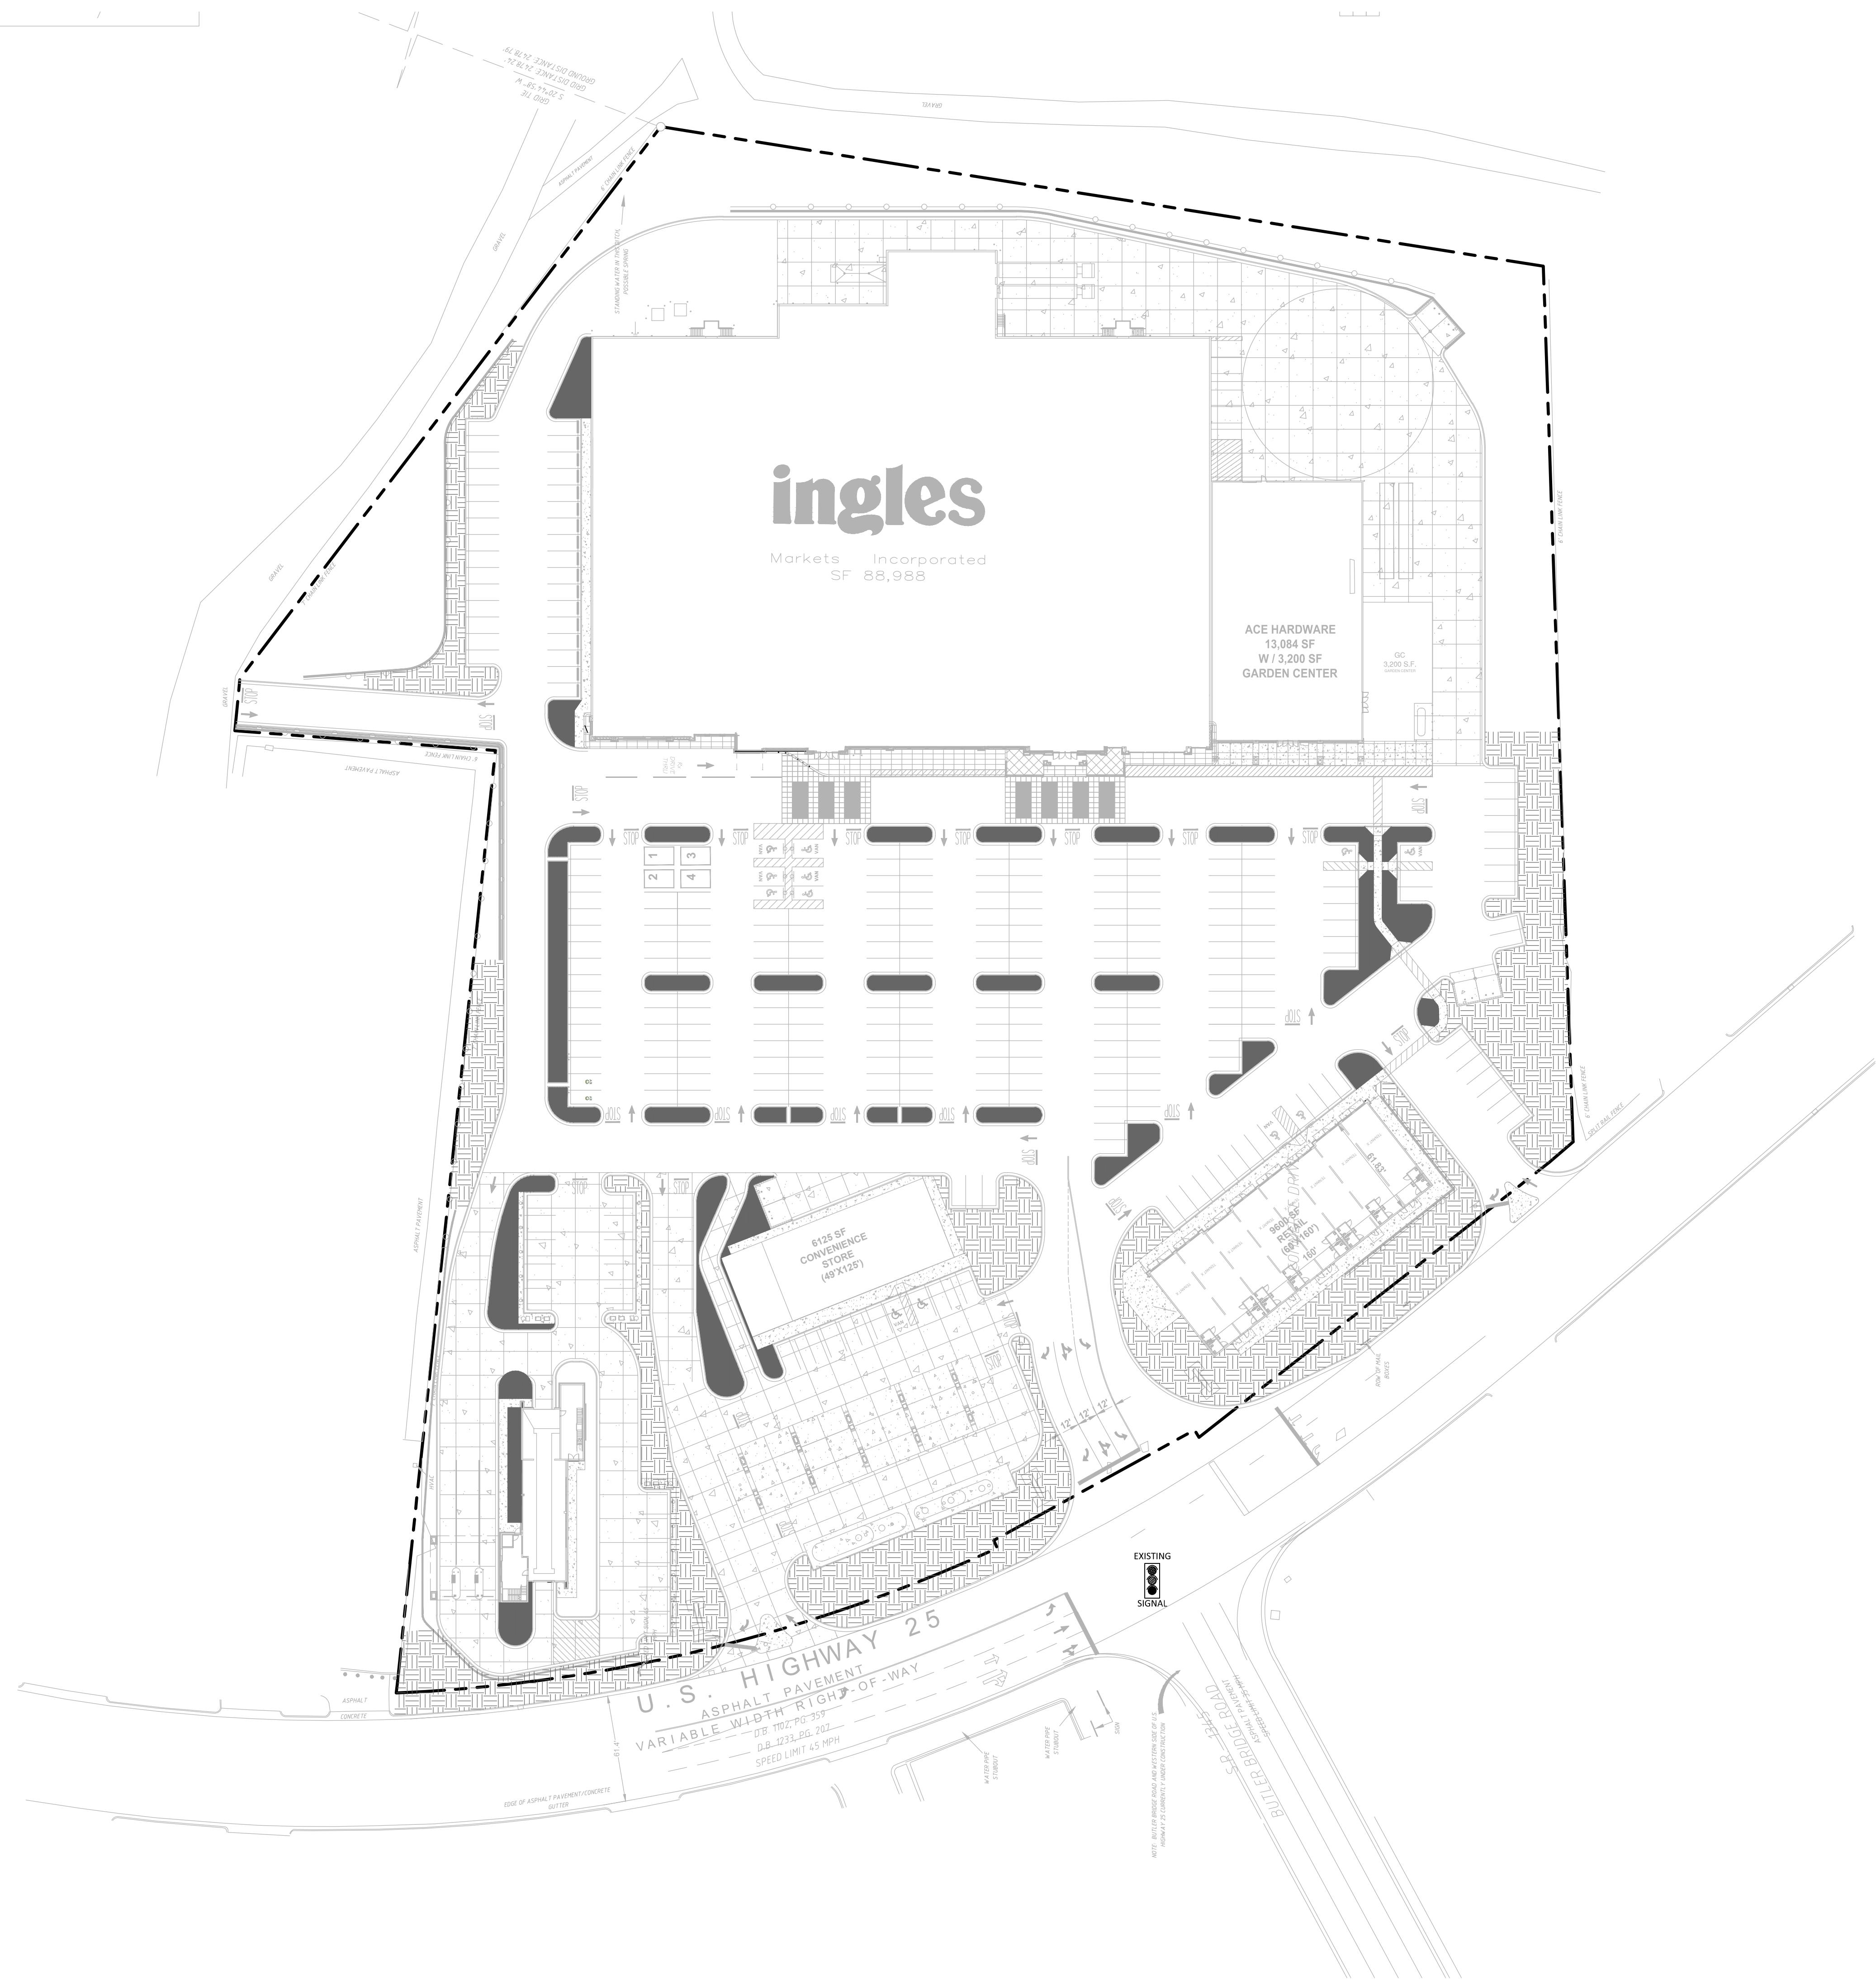



ISLAND AREAS TO RECEIVE TOPSOIL

LAWN AREAS TO RECEIVE TOPSOIL

ISLAND AREAS = 15,387 SQFT
LAWN AREAS = 42,692 SQFT
TOTAL AREA = 57,543 SQFT


SHADED AREAS IN ISLANDS TO RECEIVE 6"
OF TOPSOIL AND LAWN AREAS TO RECEIVE
4" OF TOPSOIL.

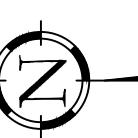

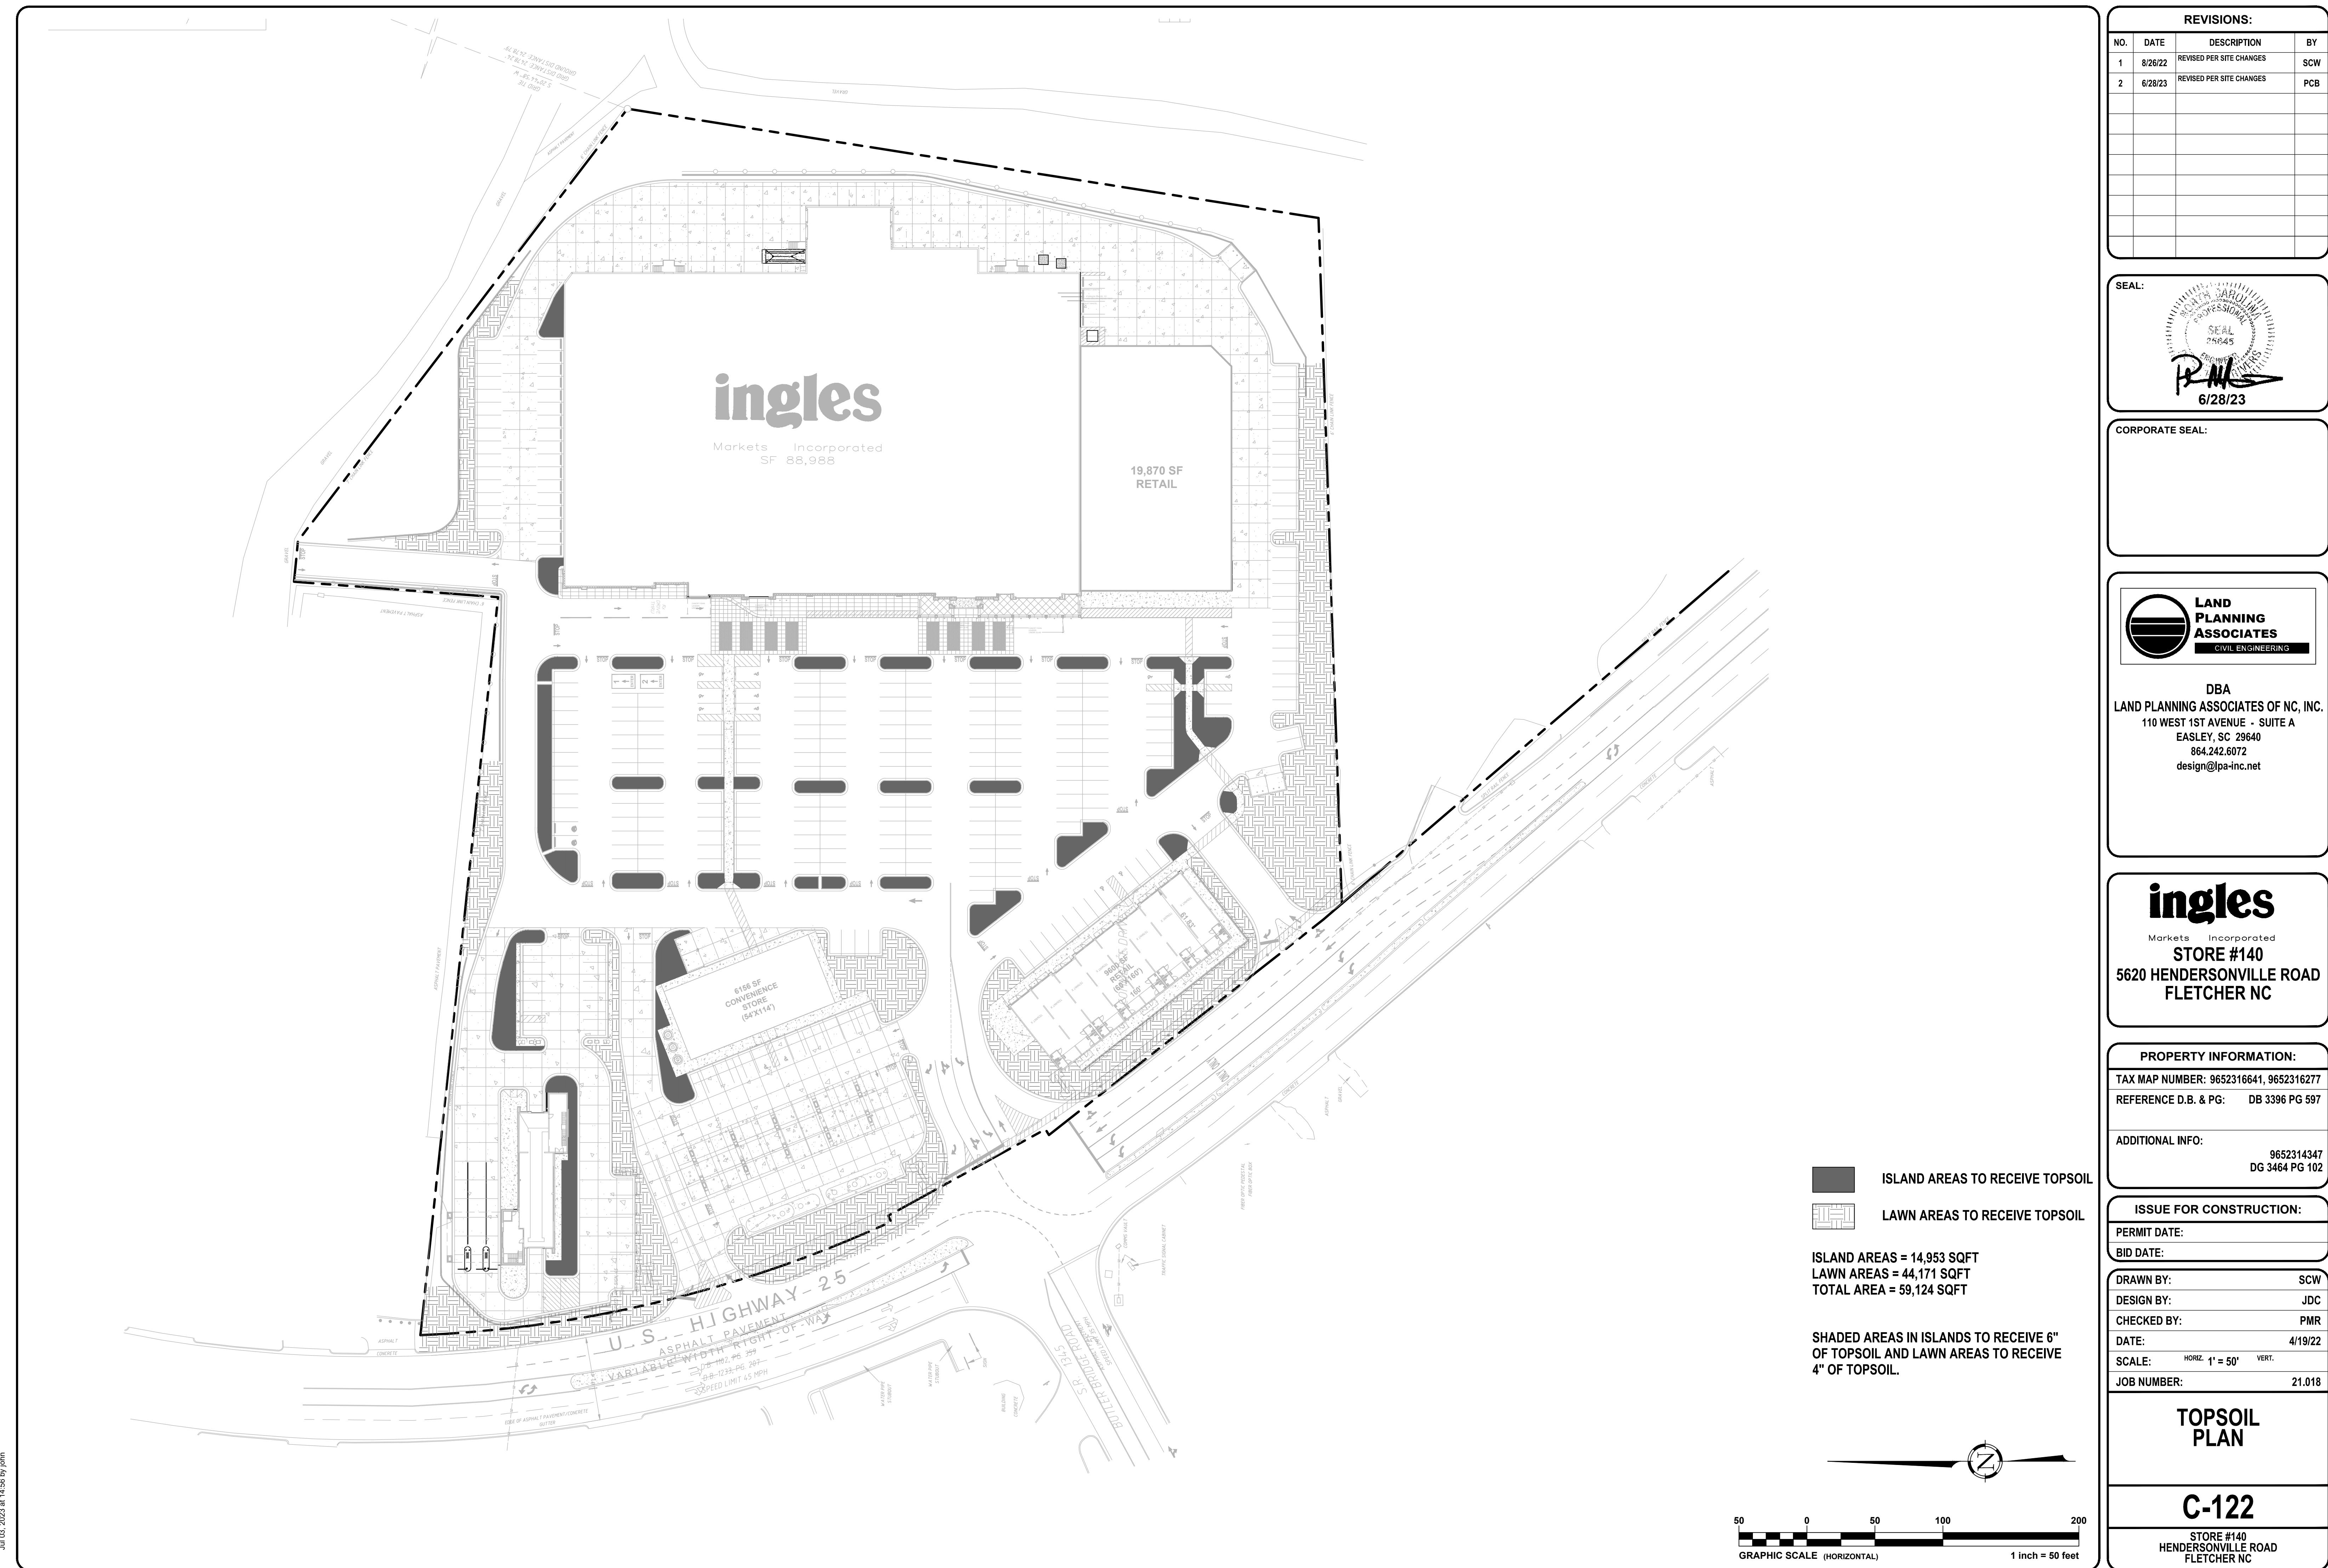

REVISIONS:

NO.	DATE	DESCRIPTION	BY
1	6/28/23	REVISED PER DIRECTION OF INGLES	JDC

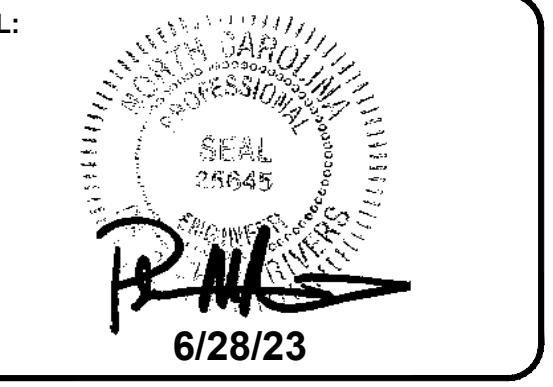

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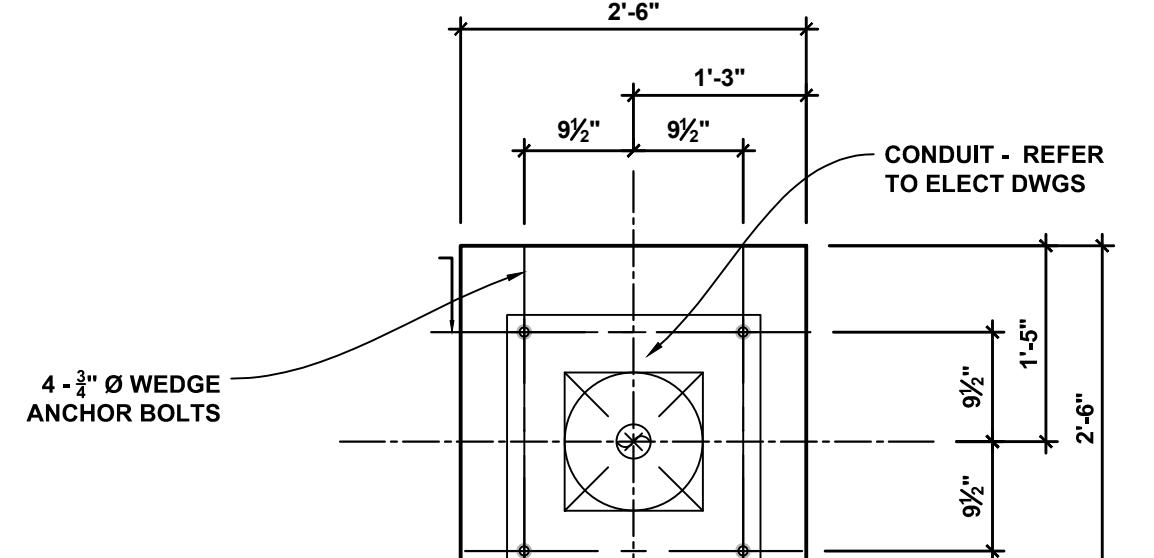
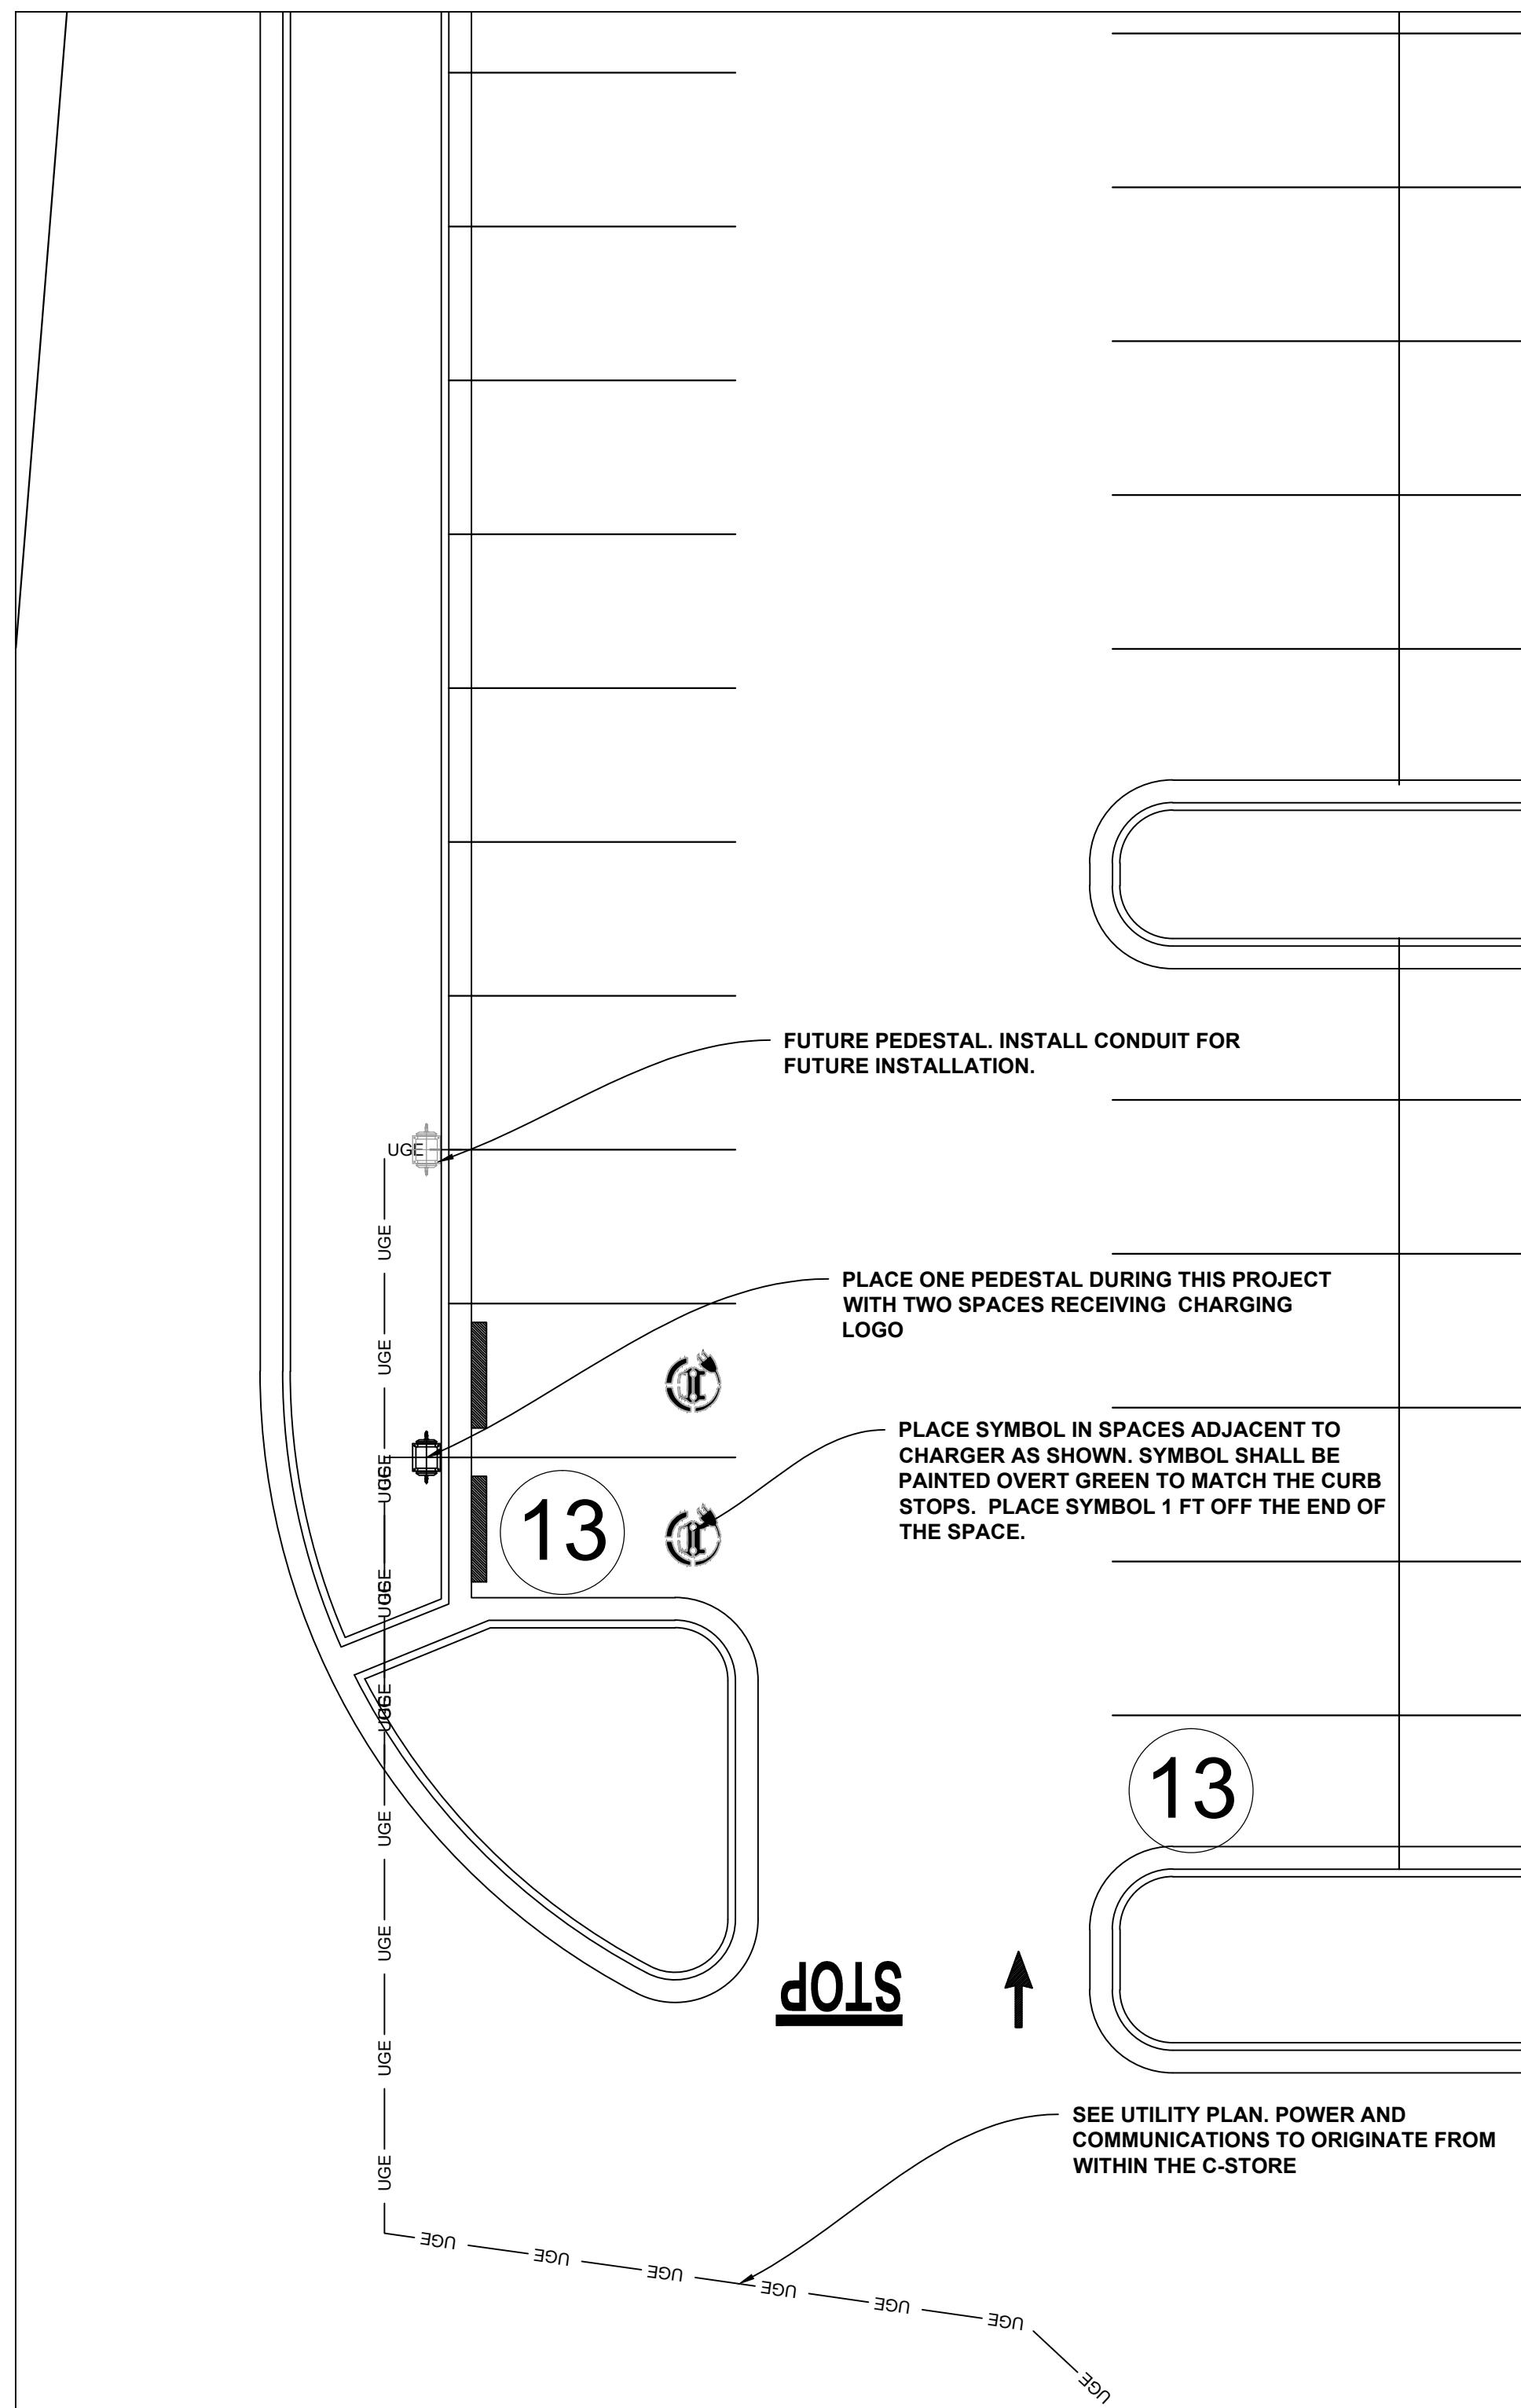
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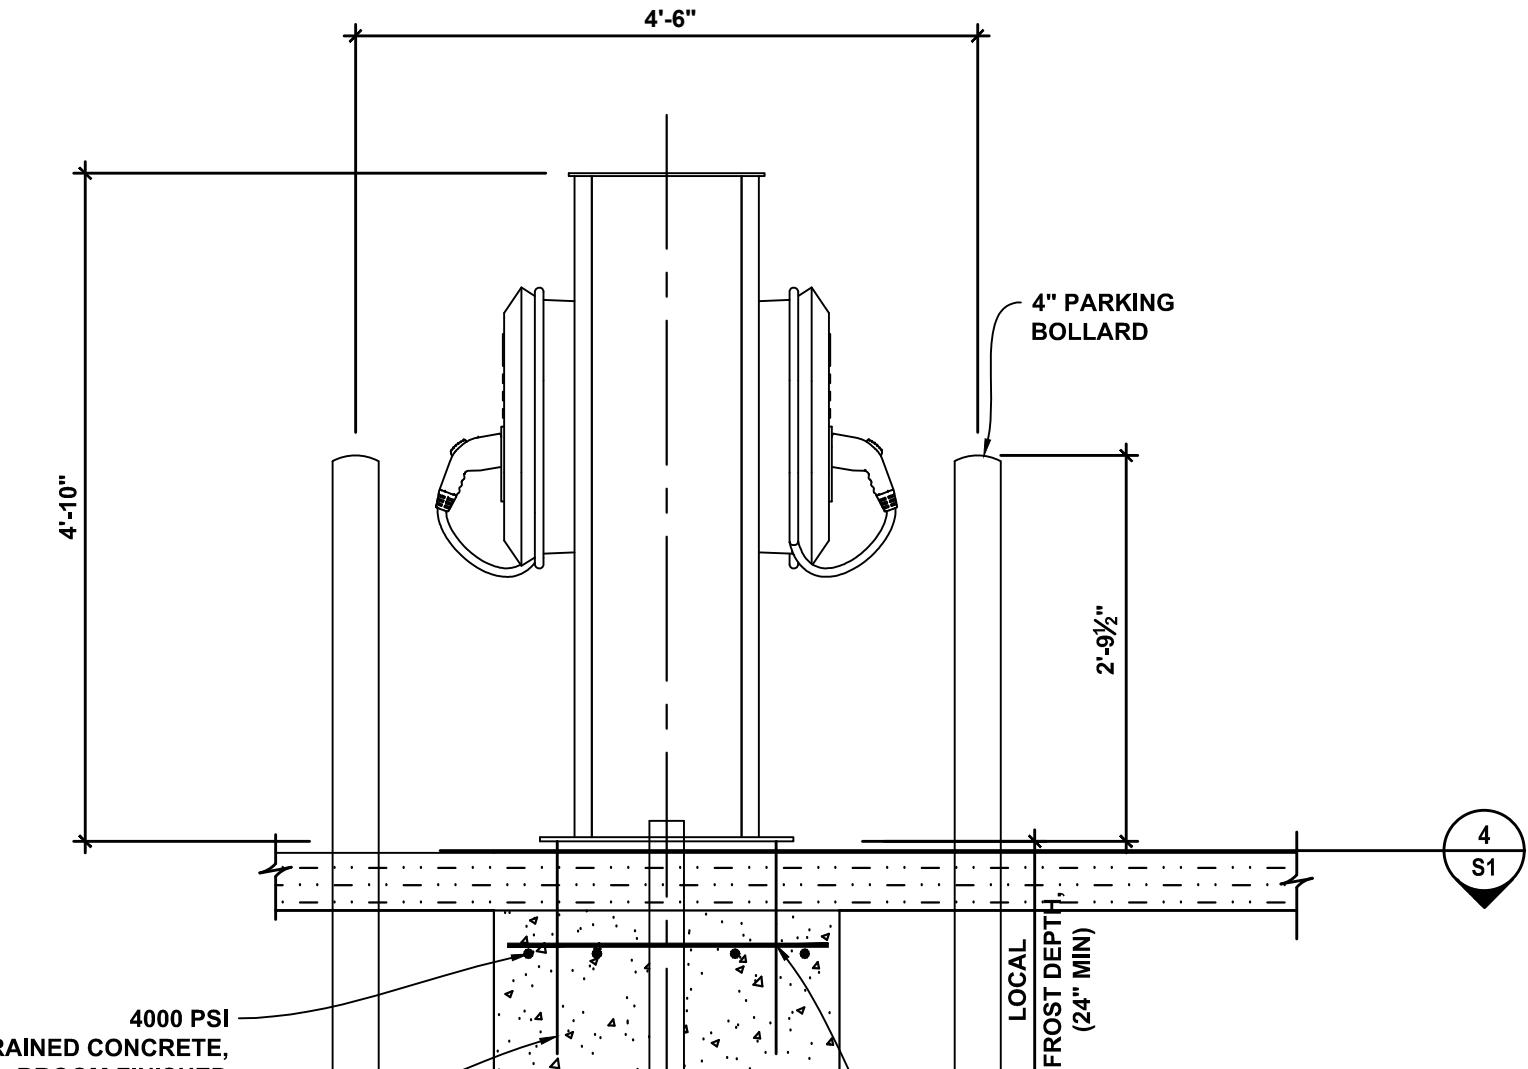
ISSUE FOR CONSTRUCTION:	
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DRAWN BY:	SCW
DESIGN BY:	JDC
CHECKED BY:	JDC
DATE:	4/19/22
SCALE:	HORIZ. VERT.
JOB NUMBER:	21.018


CAR CHARGING DETAILS	
C-123	STORE #140 HENDERSONVILLE ROAD FLETCHER, NC





1 FOUNDATION PLAN
3/4" = 1'-0"



2 ELEVATION IN PARKING SPACE
3/4" = 1'-0"

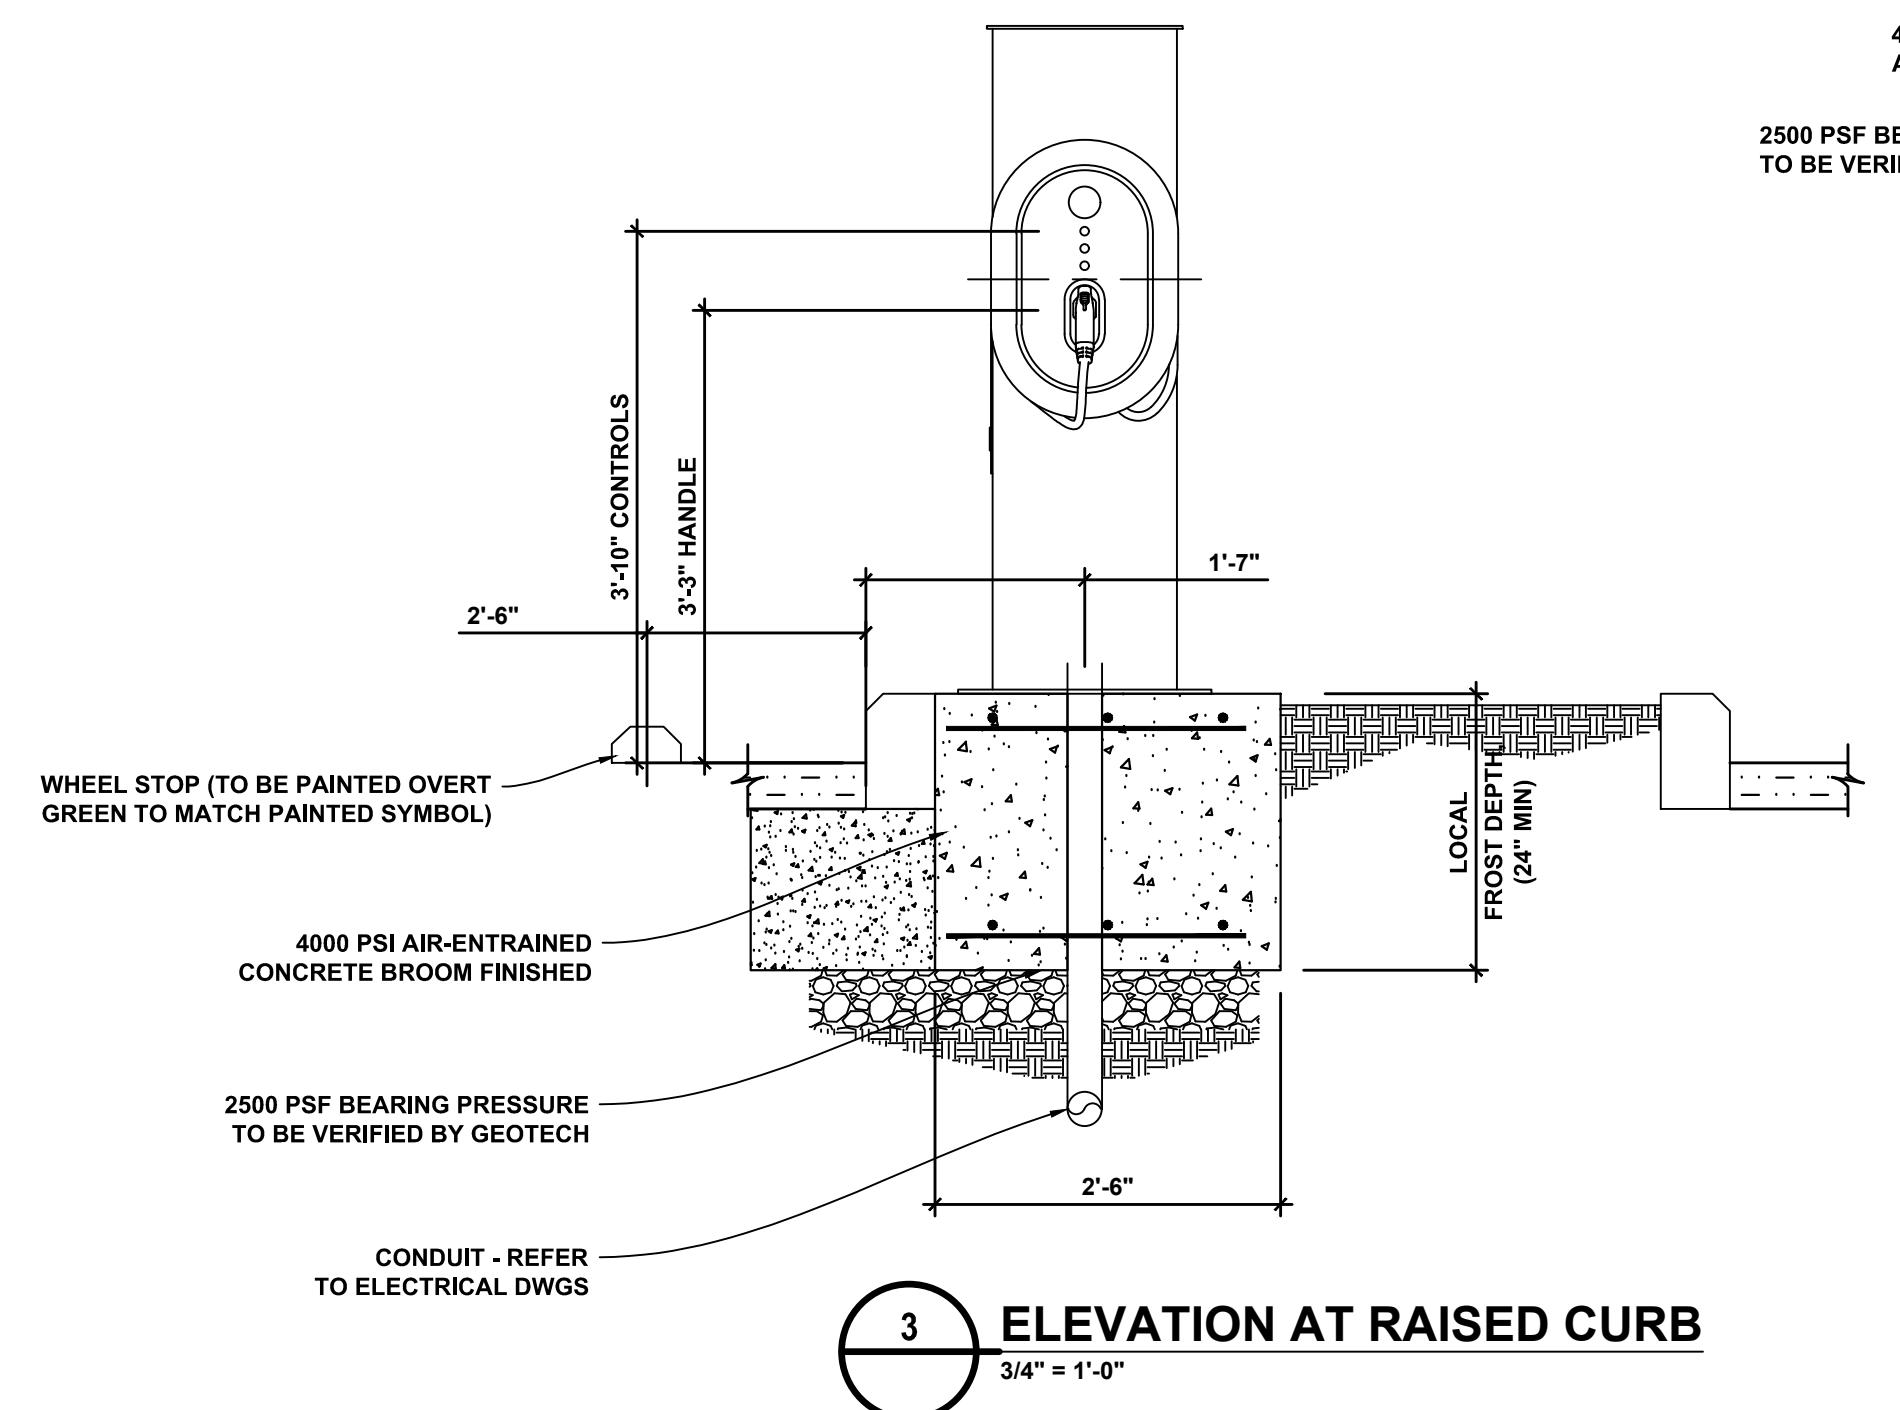


3 ELEVATION AT RAISED CURB
3/4" = 1'-0"

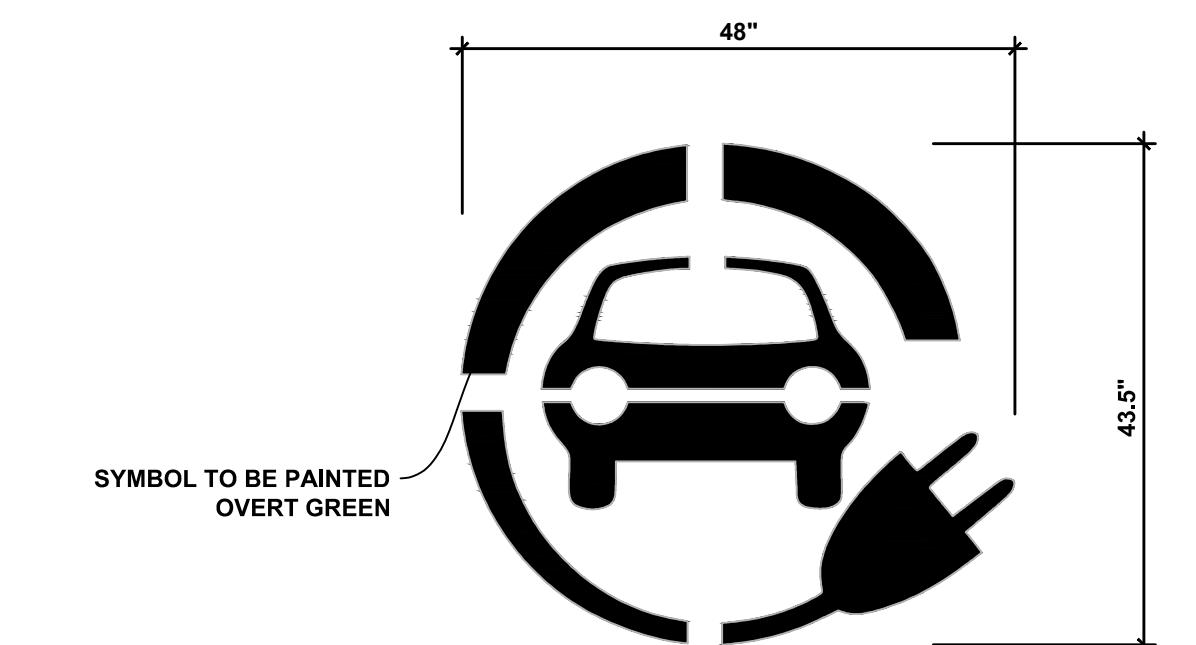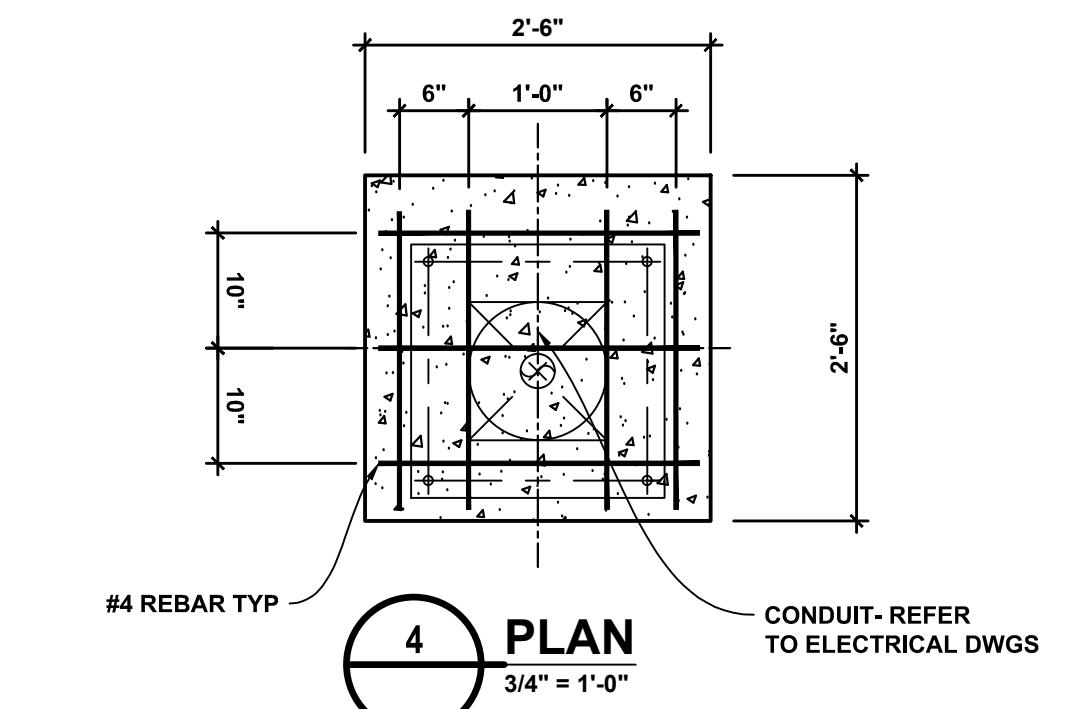

6 CHARGING SPACE SYMBOL
3/4" = 1'-0"


5 ELEVATION
3/4" = 1'-0"

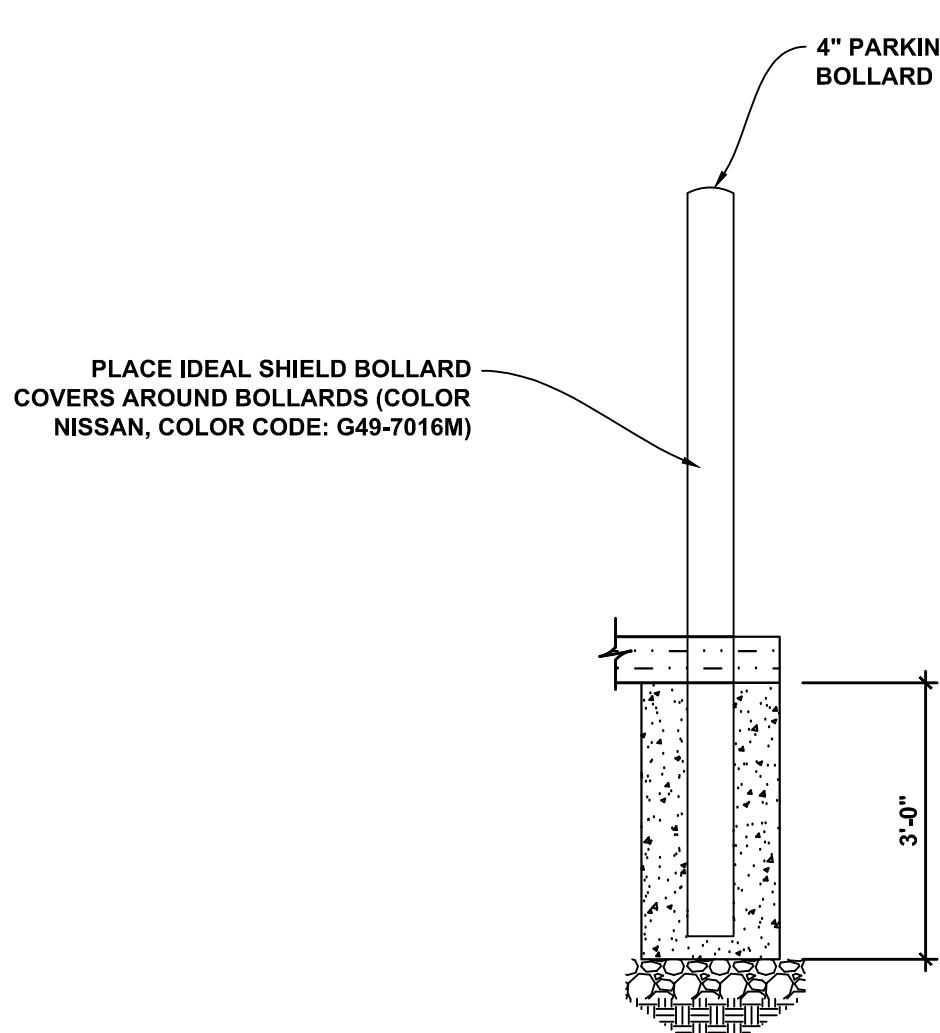


NOTE:
1. STENCILS FOR ALL INGLE'S STRIPING CAN BE FOUND AT PAVEMENT STENCILS CO. ALTERNATE STENCILS NEED TO BE APPROVED BY INGLE'S CONSTRUCTION DEPARTMENT
2. PAINT SYMBOL 1 FT OFF THE END OF THE SPACE

REVISIONS:

NO.	DATE	DESCRIPTION	BY
1	6/28/23	ADJUSTED WIER STRUCTURE TO NEW SITE LAYOUT	SCW

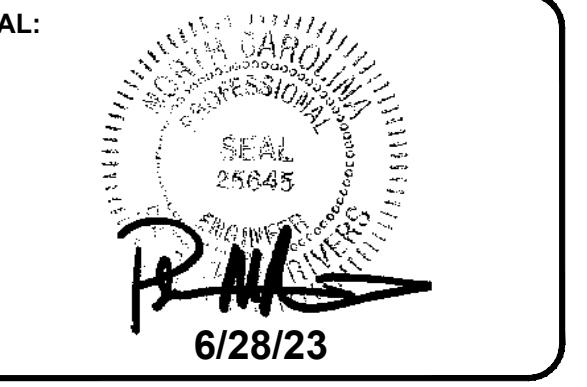

6/28/23

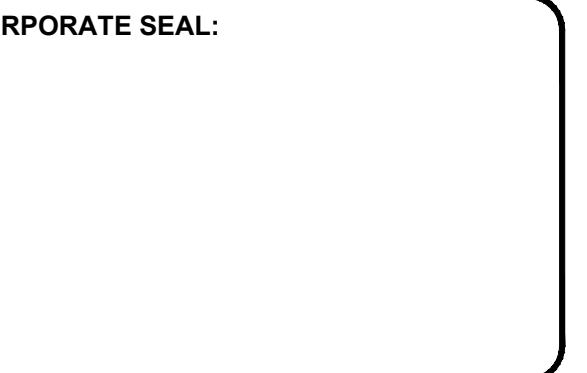

6/28/23



6/28/23

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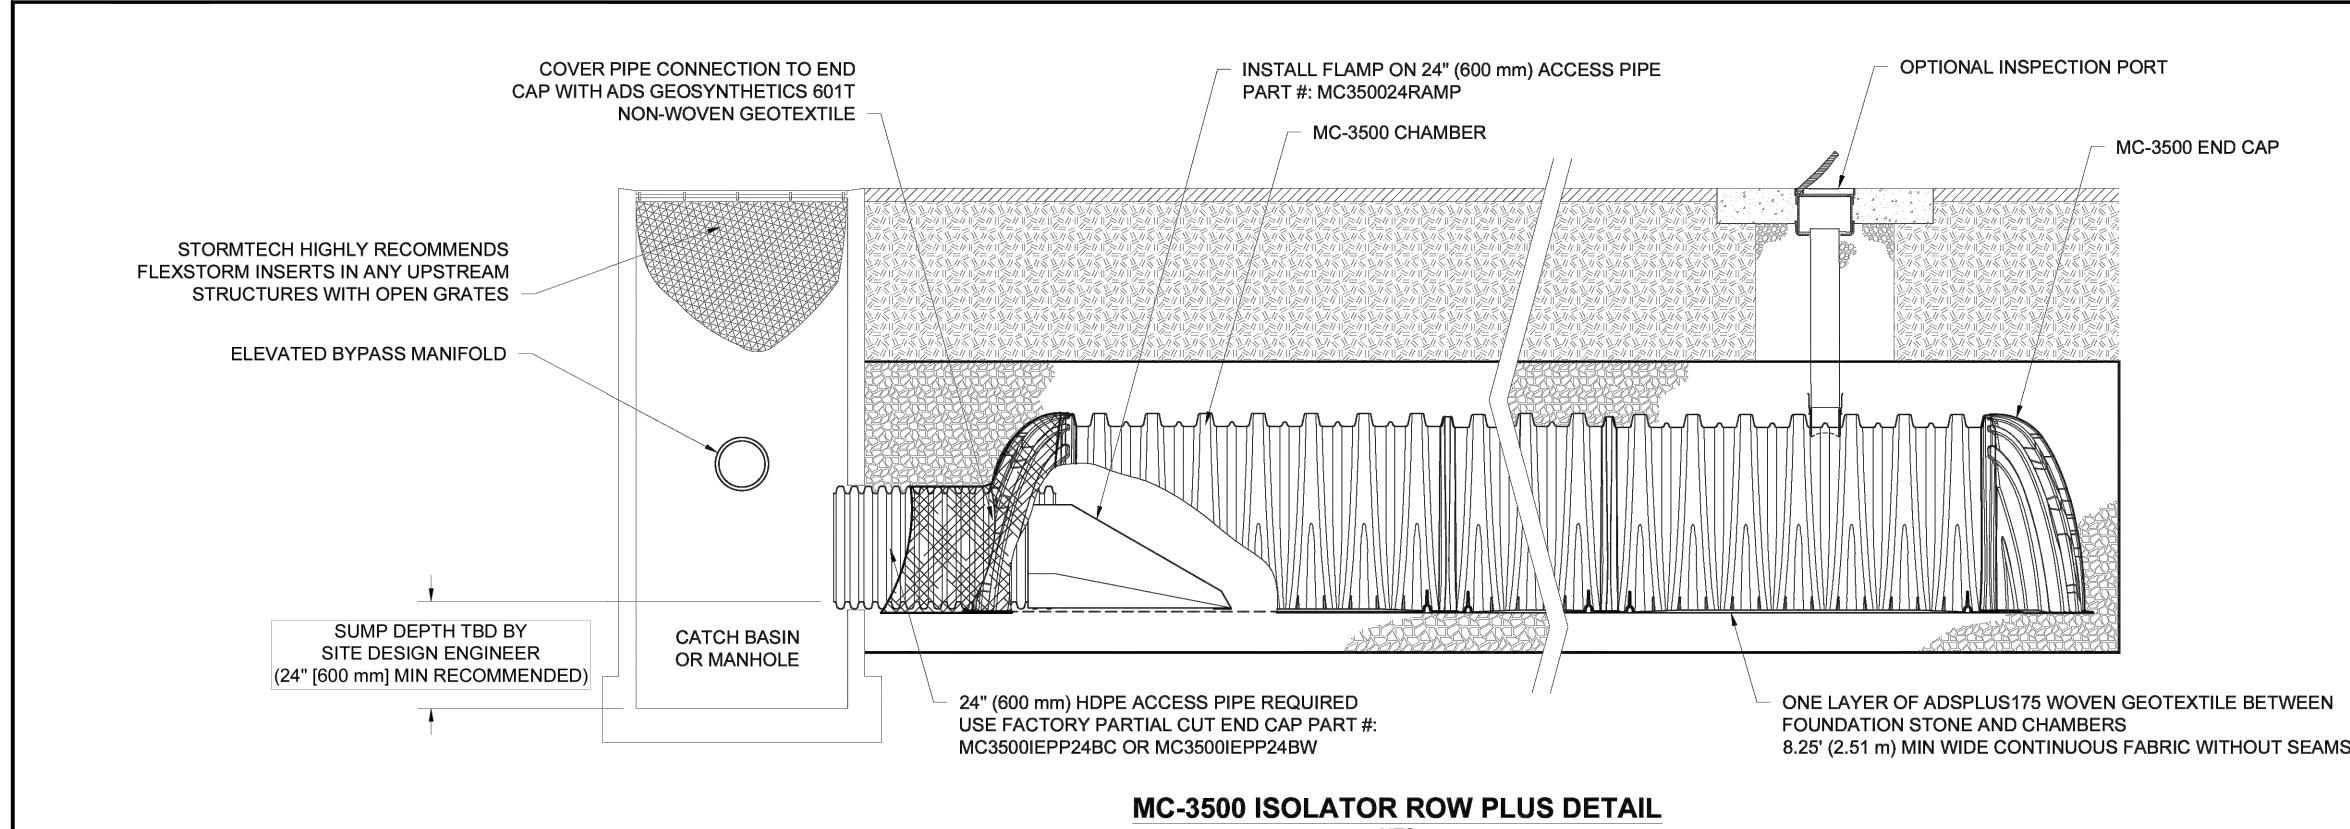
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UNDERGROUND DETENTION DETAILS

C-125

STORE #140
HENDERSONVILLE ROAD
FLETCHER, NC



INSPECTION & MAINTENANCE

- STEP 1) INSPECT ISOLATOR ROW PLUS FOR SEDIMENT
 A.1. INSPECTION PORTS (IF PRESENT)
 A.2. REMOVE OPEN LID ON NYLOPLAST INLINE DRINK
 A.3. REMOVE AND CLEAN EXSTOKE FILTER AS NEEDED
 A.4. USE A STICKY TAPE TO MARK THE AREA TO MEASURE DEPTH OF SEDIMENT AND RECORD ON MAINTENANCE LOG
 A.5. LOWER A CAMERA INTO ISOLATOR ROW PLUS FOR VISUAL INSPECTION OF SEDIMENT LEVELS (OPTIONAL)
- B.1. ALL ADDED PLATE PLUS (IF PRESENT) PROCEED TO STEP 2. IF NOT, PROCEED TO STEP 3.
 B.2. REMOVE COVER FROM STRUCTURE AT UPSTREAM END OF ISOLATOR ROW PLUS
 B.3. USING A FLASHLIGHT, INSPECT DOWN THE ISOLATOR ROW PLUS THROUGH OUTLET PIPE
 B.4. MIRRORS ON THE PIPES ARE TO BE USED TO AVOID A CONFINED SPACE ENTRY
 B.5. FOLLOW REGULATIONS FOR CONFINED SPACES EVEN IF ENTERING MANHOLE
 C. IF SEDIMENT IS AT OR ABOVE, 3' (90 mm) PROCEED TO STEP 2. IF NOT, PROCEED TO STEP 3.
- STEP 2) CLEAN OUT ISOLATOR ROW PLUS USING THE JETVAC PROCESS
 A. A FIXED CULVERT CLEANING NOZZLE WITH REAR FACINGS SPREAD OF 45° (1.1 m) OR MORE IS PREFERRED
 B. APPLY MULTIPLE PASSES OF JETVAC UNTIL BACKFLUSH WATER IS CLEAN
 C. VACUUM STRUCTURE SUMP AS REQUIRED
- STEP 3) REPLACE ALL COVERS, GRATES, FILTERS, AND LIDS; RECORD OBSERVATIONS AND ACTIONS.
- STEP 4) INSPECT AND CLEAN BASINS AND MANHOLES UPSTREAM OF THE STORMTECH SYSTEM.




NOTES

1. INSPECT EVERY 6 MONTHS DURING THE FIRST YEAR OF OPERATION. ADJUST THE INSPECTION INTERVAL BASED ON PREVIOUS OBSERVATIONS OF SEDIMENT ACCUMULATION AND HIGH WATER ELEVATIONS.
2. CONDUCT JETTING AND VACTORING ANNUALLY OR WHEN INSPECTION SHOWS THAT MAINTENANCE IS NECESSARY.


NOTE: INSPECTION PORTS MAY BE CONNECTED THROUGH ANY CHAMBER CORRUGATION VALLEY.

4" PVC INSPECTION PORT DETAIL
(MC SERIES CHAMBER)


NTS

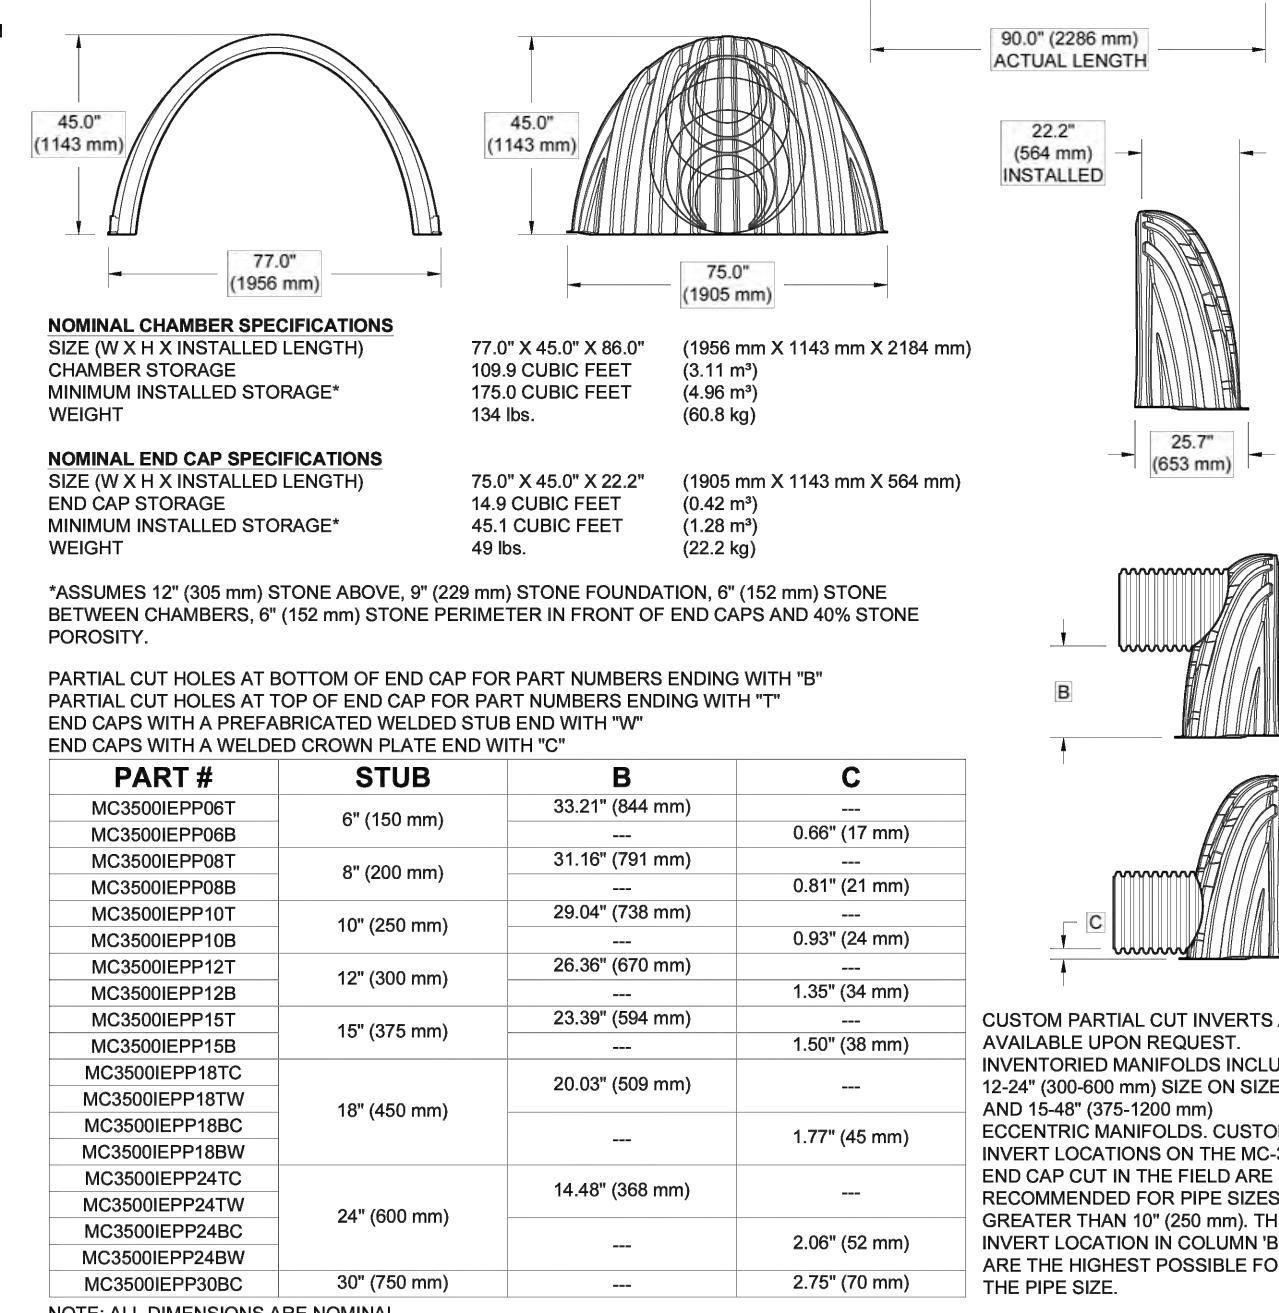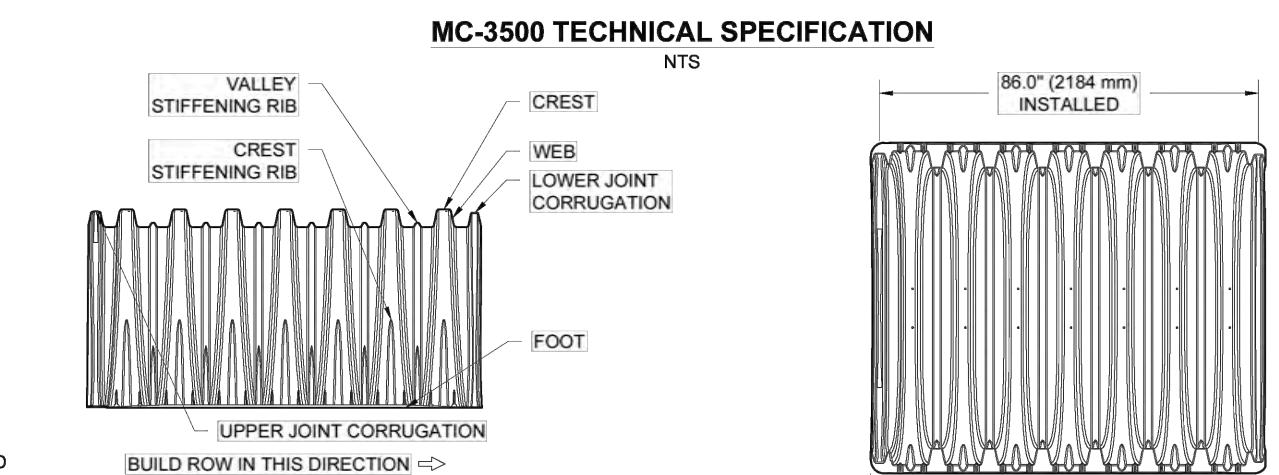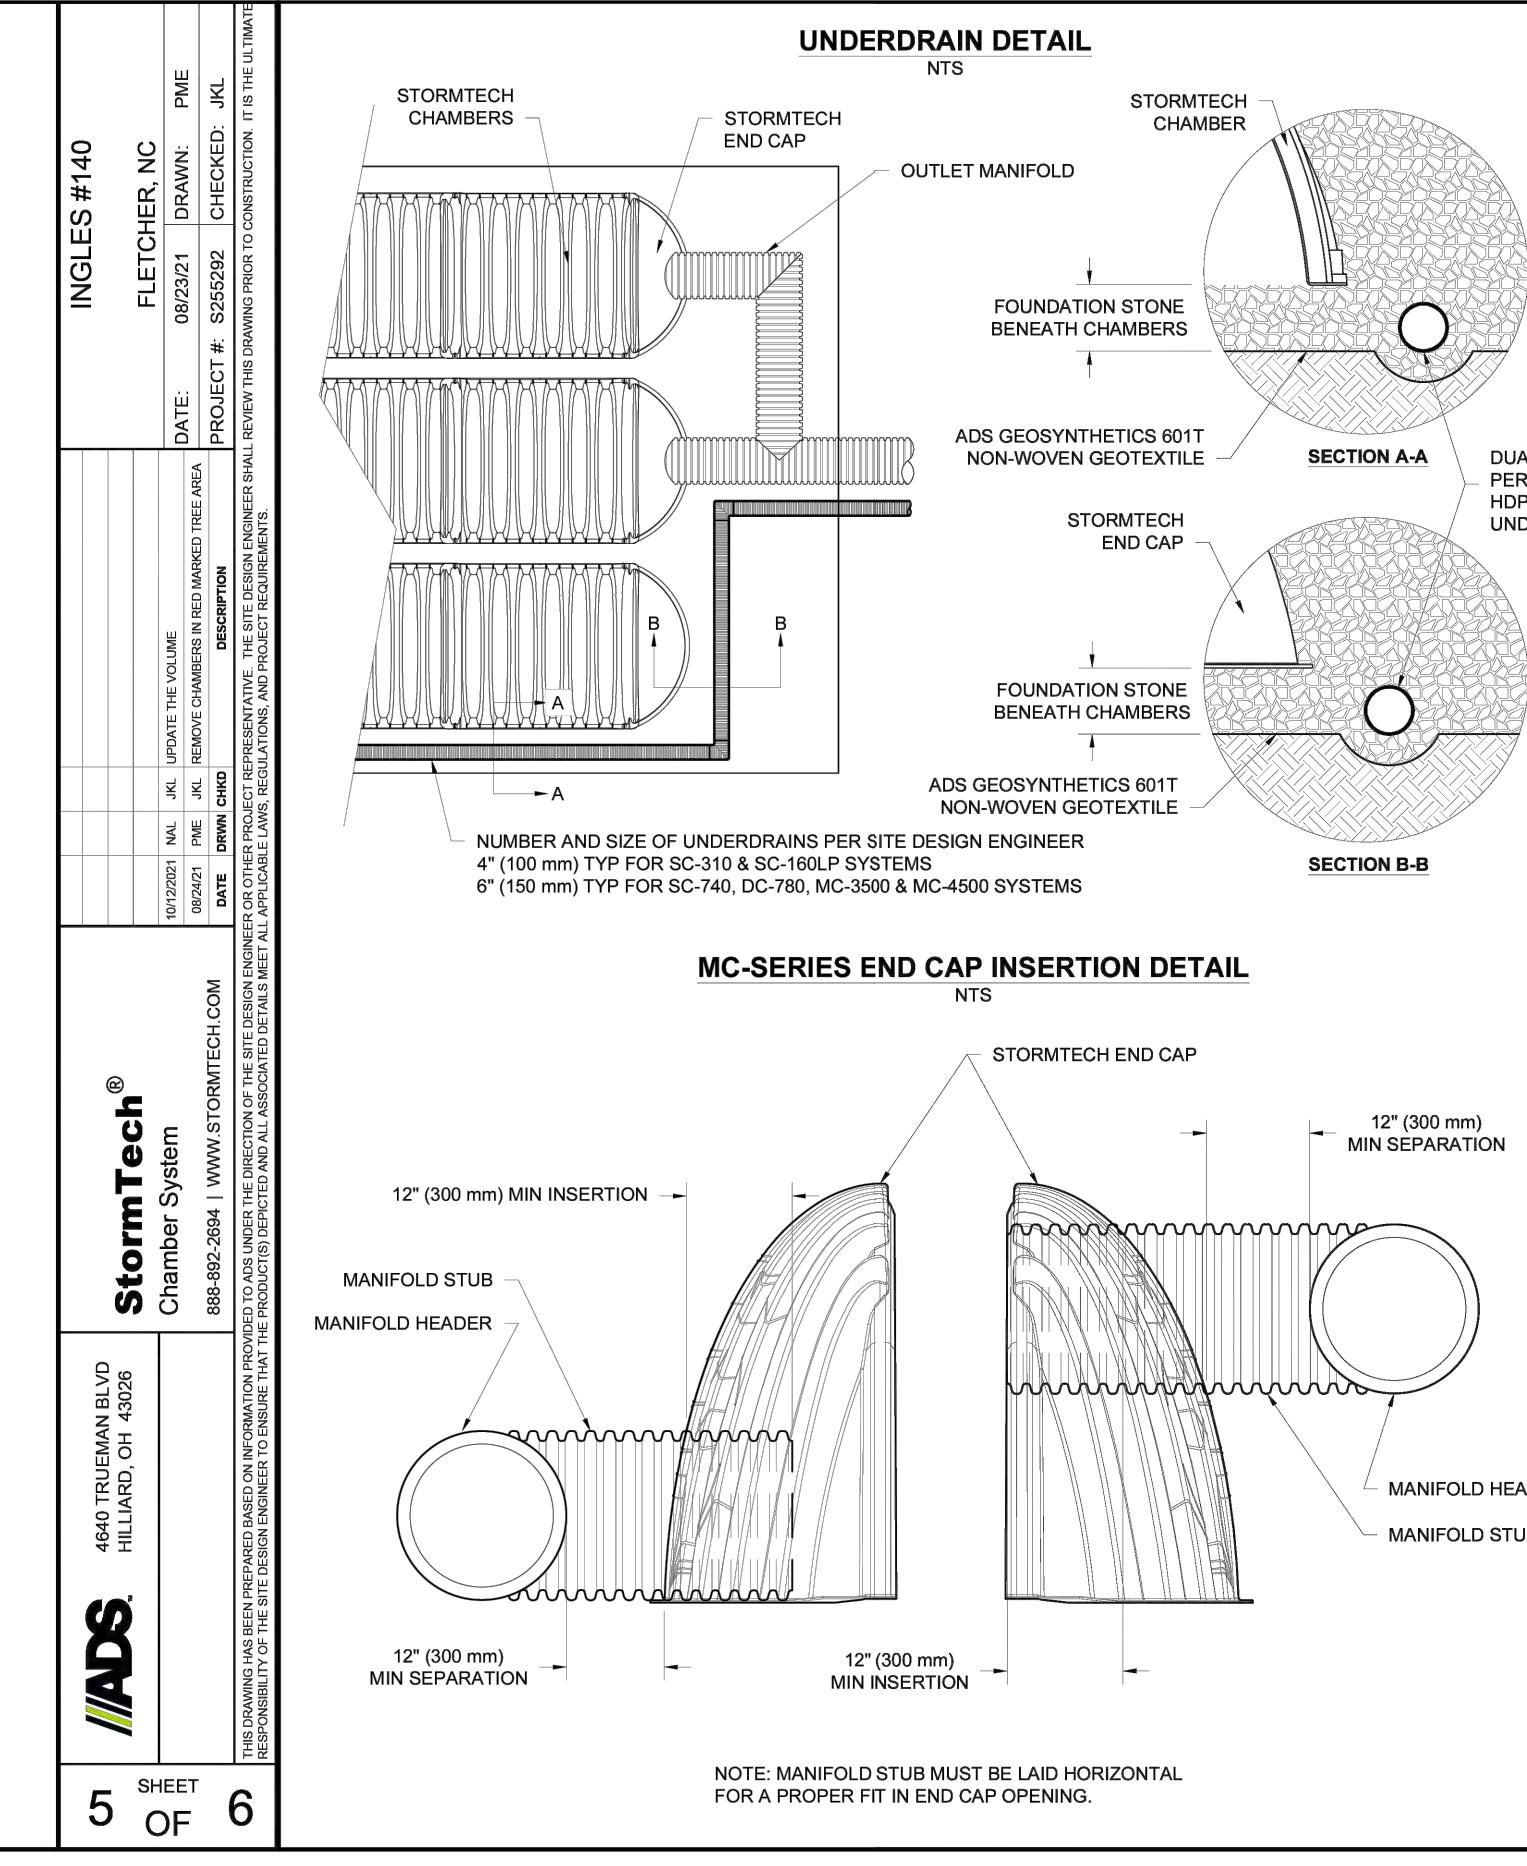

NOTE: ALL DIMENSIONS ARE NOMINAL

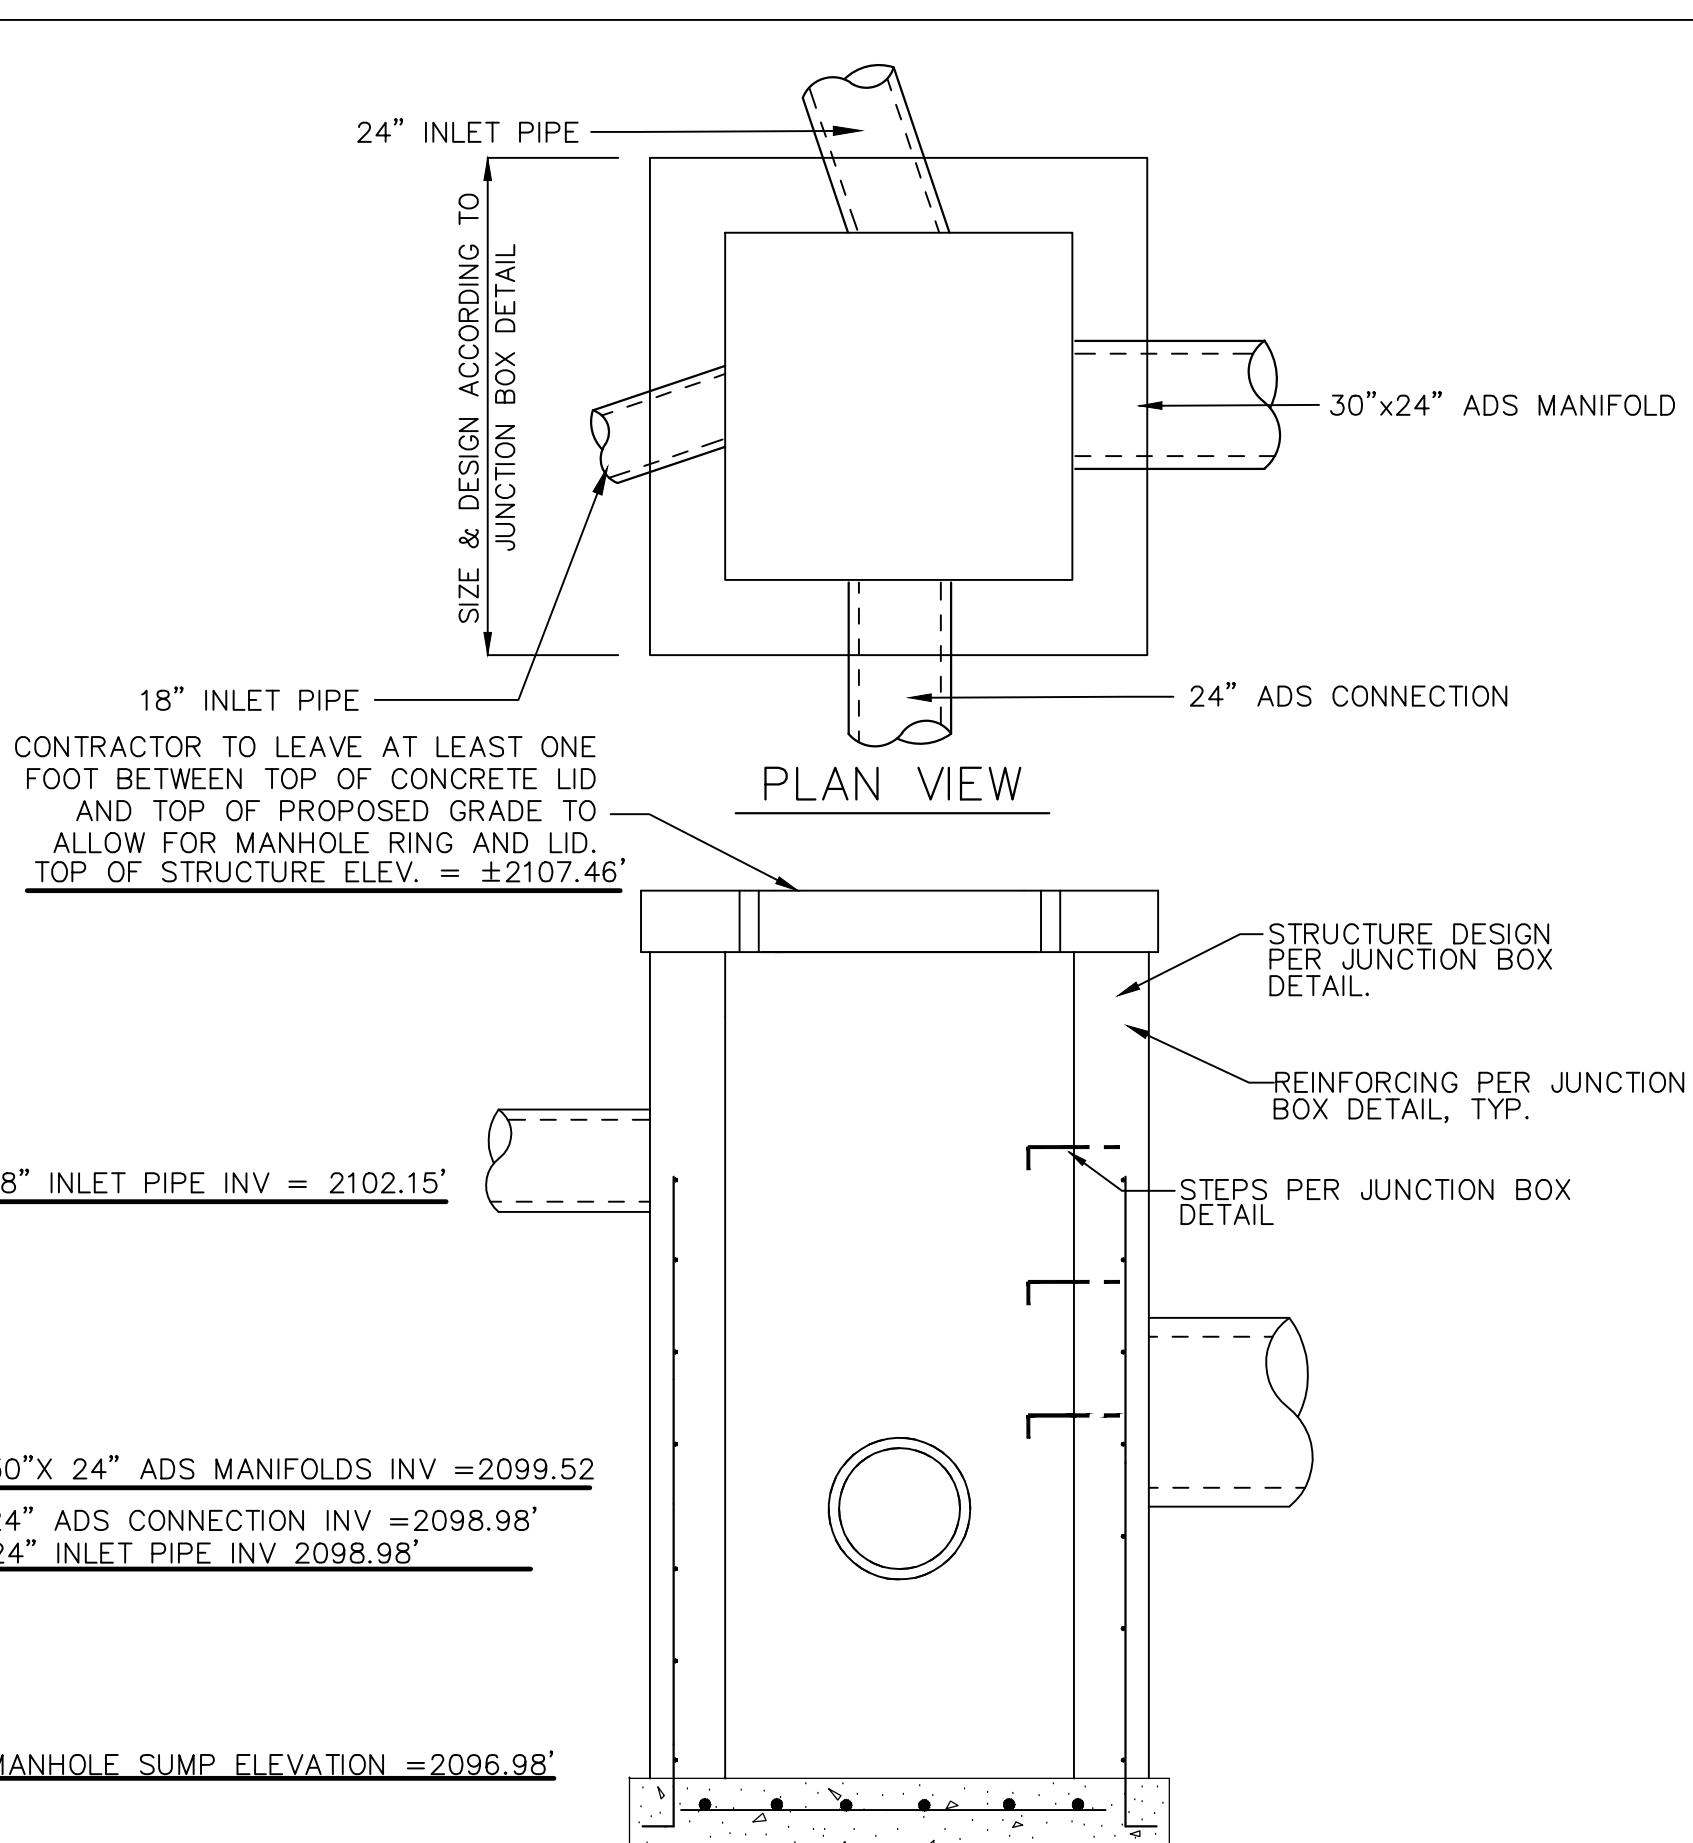

UNDERGROUND DETENTION FACILITY
INLET STRUCTURE A6.0
(N.T.S.)

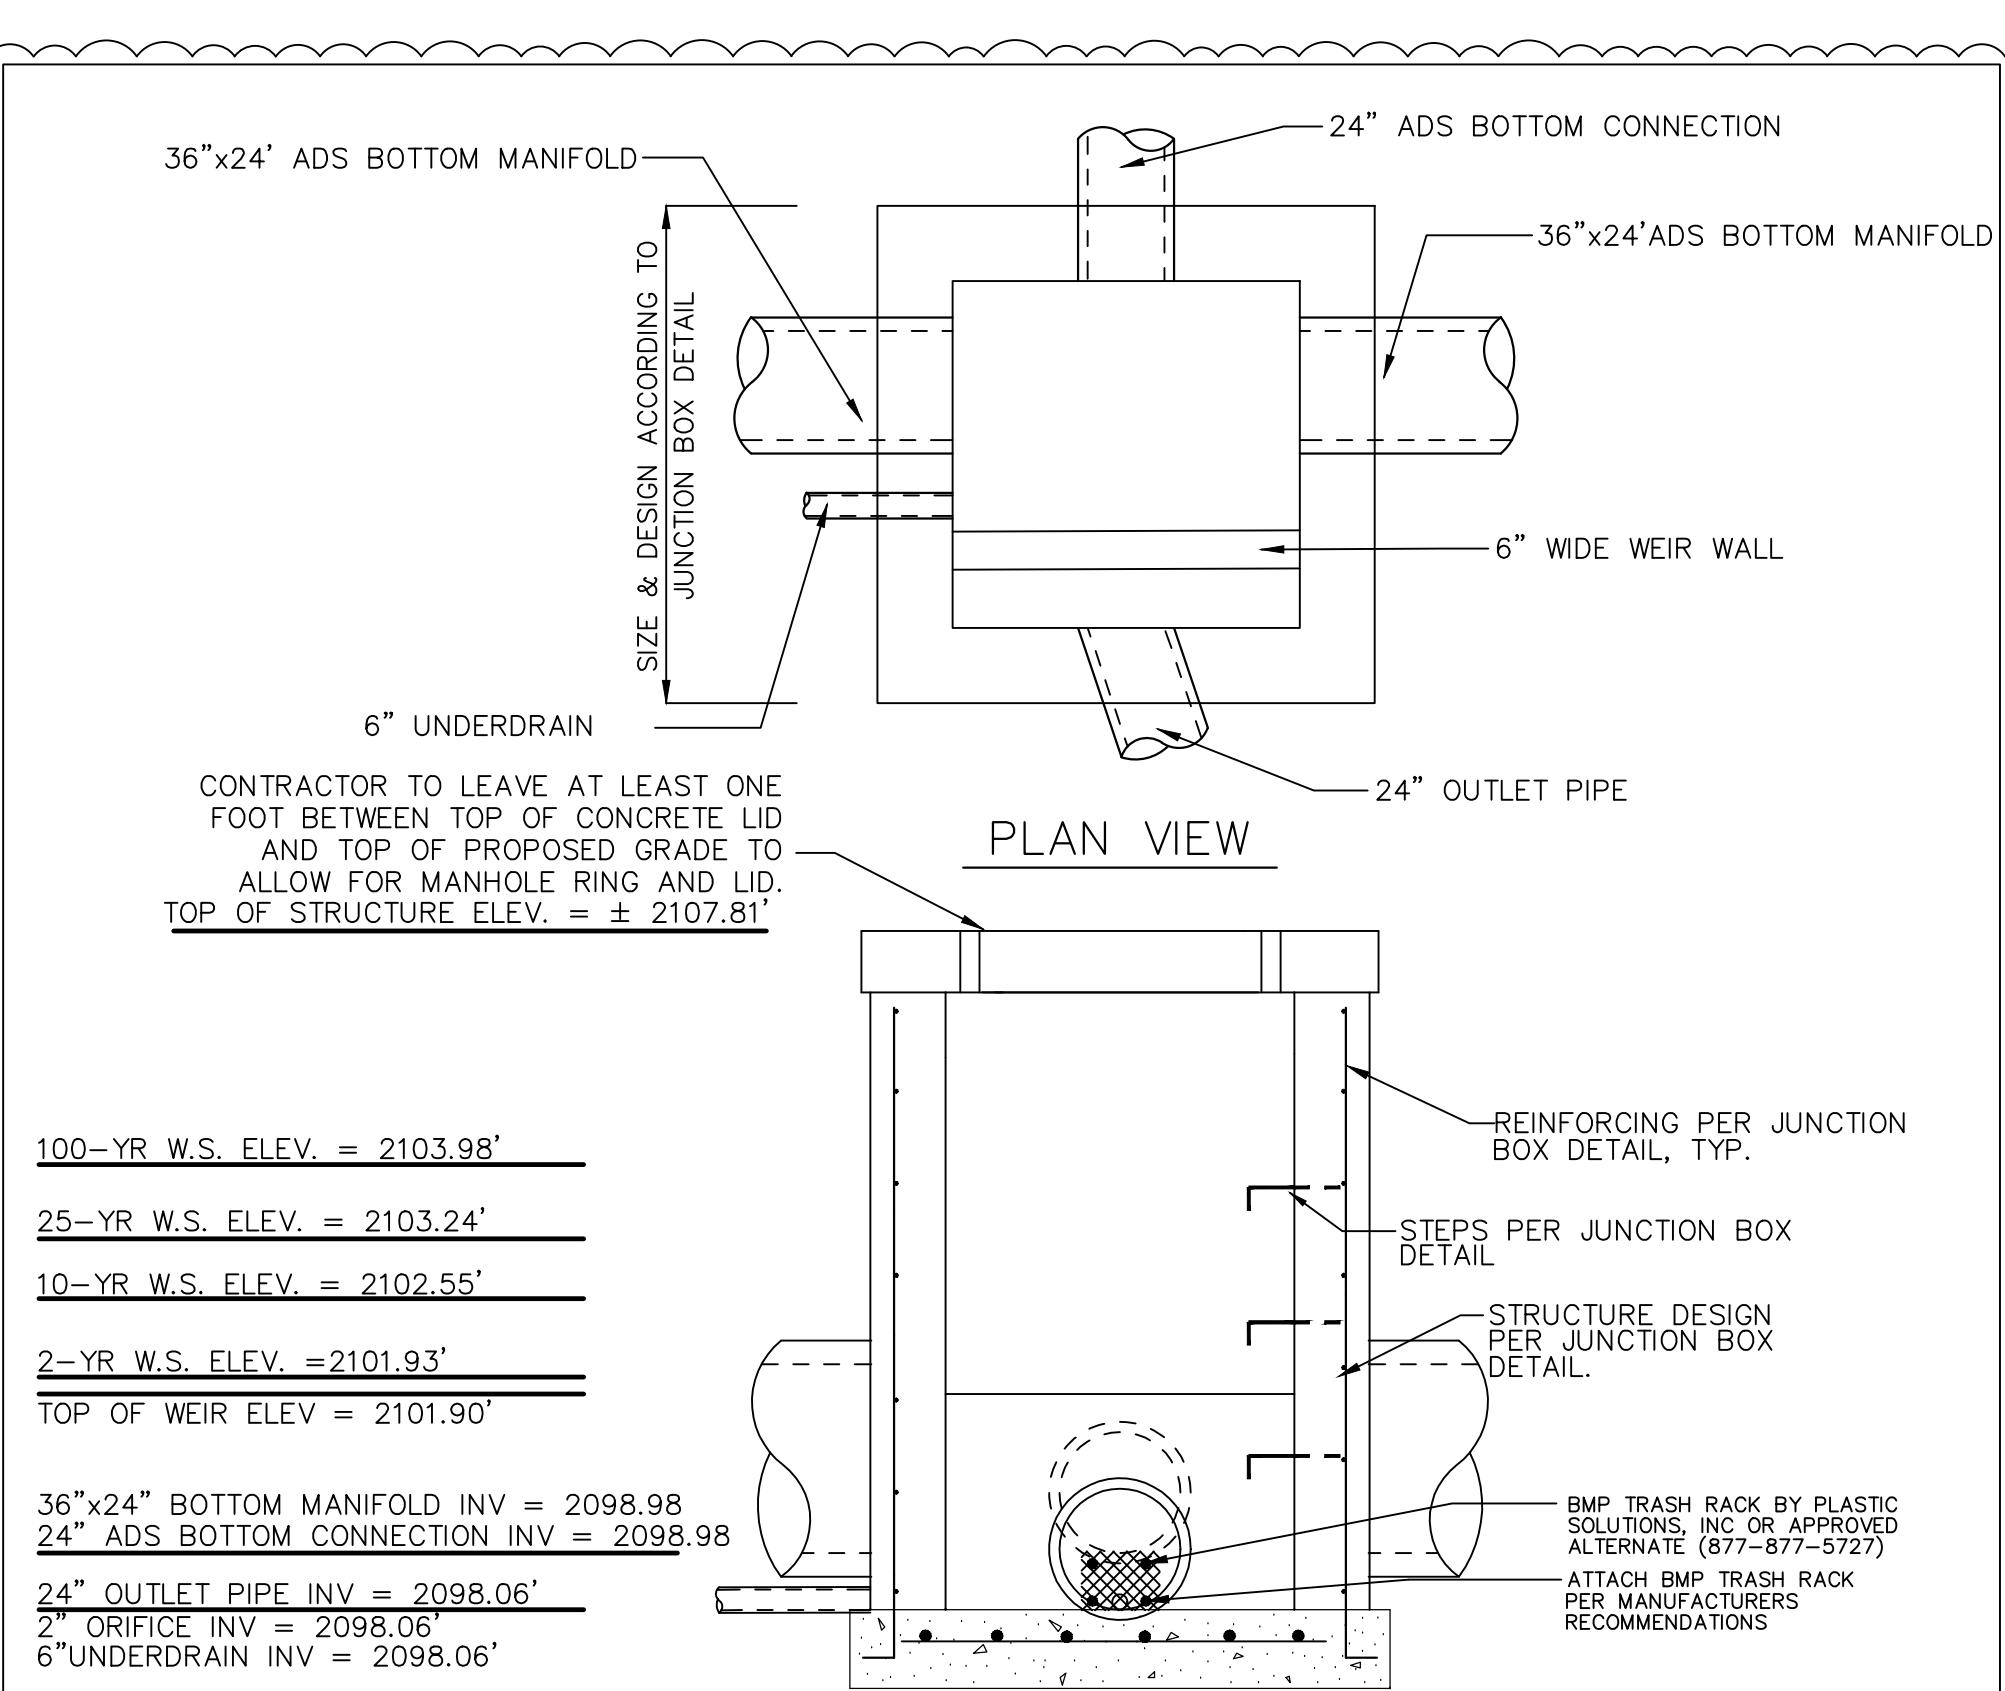

UNDERGROUND DETENTION FACILITY
OUTLET STRUCTURE A5.0
(N.T.S.)


DESIGN ASSOCIATES

LANDSCAPE ARCHITECTS
& LAND PLANNERS




Ingles #140
5620 Hendersonville Road
Fletcher, NC

Landscape & Zoning
Compliance
Plan

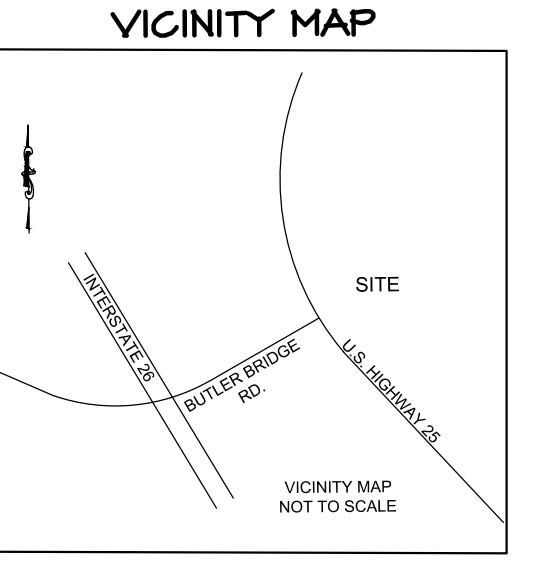


REVISIONS:
7-5-2023 REVISED

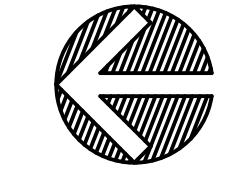

L1

4-26-2022

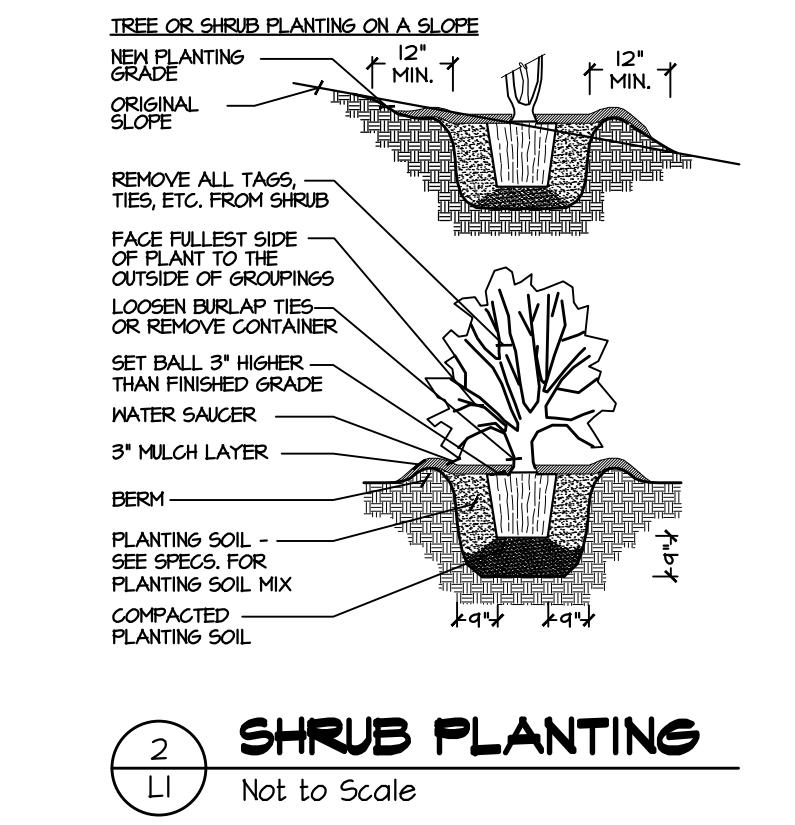

PLANTING SUMMARY:

1) PARKING LOT LANDSCAPING

1 DECIDUOUS TREE IS REQUIRED PER 5 PARKING SPACES
280 PARKING SPACES = 56 DECIDUOUS TREES REQUIRED
DECID TREES REQUIRED = 56
DECID TREES PROVIDED = 56

2) PLANTING STRIP


WHEN PARKING SPACES ARE WITHIN 20' OF THE PROPERTY LINE
A MIN 10' WIDE PLANTING STRIP IS REQUIRED
2 TREES ARE REQUIRED PER 100 LF OF PLANTING STRIP
16 LF OF PLANTING STRIP = 0 TREE REQUIRED
TREES REQUIRED = 0
TREES PROVIDED = 1

PLANTING LEGEND

PL = PARKING LOT LANDSCAPING
PS = PLANTING STRIP LANDSCAPING
OF PLANTS
PLANT KEY (SEE PLANT LIST)
4 ACER (PL) ZONING USE ABBREVIATION (SEE LEGEND)

PLANT SCHEDULE

KEY	QTY	BOTANICAL NAME / COMMON NAME	CALIPER	HEIGHT	CONTAINER	MATERIAL SPECIFICATIONS
ACER	5	Acer rubrum / Red Maple	2" min. cal.	12'-14' ht.	B&B	single, straight leader, well-branched
AMEA	13	Amelanchier arborea / Downy Serviceberry	1.5" min. cal.	8' to 10' ht.	B&B or cont.	multi-trunk, dense, uniform branching
BETN	9	Betula nigra / River Birch	2" min. cal.	12'-14' ht.	B&B or cont.	multi-stemmed, min. 3 stems
CRAP	11	Crateagus phaeopyrum / Washington Hawthorn	1.5" min. cal.	8' to 10' ht.	B&B or cont.	straight trunk, dense, uniform branching, min. 5' branching height
LAGN	15	Lagerstroemia indica 'Natchez' / Natchez Crape Myrtle	1.5" min. cal.	8' to 10' ht.	B&B	3 trunk min.
ULMP	4	Ulmus parvifolia / Lacebark Elm	2" min. cal.	12'-14' ht.	B&B or cont.	straight trunk, dense, uniform branching

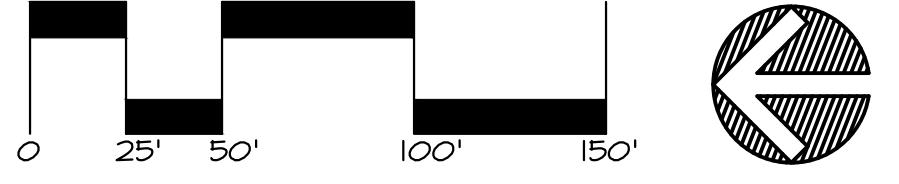

SCALE: 1" = 50'

NORTH