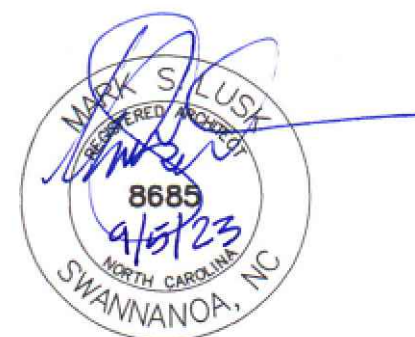


HCPS ROOF REPLACEMENTS AT WHHS, NHHS, HMS & FRMS

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**HCPS ROOF
REPLACEMENTS
AT WHHS, NHHS,
HMS & FRMS**

Project Number: 23002
Checked: _____
Drawn: A. Rognas
Date: 9/5/23
Revisions: _____

COVER SHEET

T101

OWNER

HENDERSON COUNTY
HENDERSON COUNTY PUBLIC SCHOOLS

CONTACTS

OWNER REPRESENTATIVE

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LIST OF DRAWINGS

T101	COVER SHEET
ARCHITECTURAL	
A201	BUILDING Z ROOF PLAN - WHHS
A202	BUILDING Z-1 ROOF PLAN - WHHS
A203	BUILDING Y-1 ROOF PLAN - WHHS
A204	MEDIA CENTER ROOF PLAN - WHHS
A205	HENDERSONVILLE MIDDLE WALK/ENTRY ROOFS
A206	FLAT ROCK MIDDLE WALKWAY ROOF PLAN
A207	NORTH HENDERSON HIGH WEIGHT RM ROOF PLAN
A301	DETAILS
A302	DETAILS

NORTH CAROLINA BUILDING CODE SUMMARY

- PER N.C.G.S. 143-138(b15): BUILDINGS CONSTRUCTED BEFORE 2012 ARE EXCLUDED FROM THE CURRENT CODE AND ARE SUBJECT TO THE 2009 NC ENERGY CONSERVATION CODE. R-VALUE MIN. SHALL BE R-15, FOR CLIMATE ZONE 4 (NON-MARINE)
- NC ENERGY CONSERVATION CODE 503.1 EXCEPTION 2.e: REROOF SHALL NOT BE LESS THAN THE CONDITIONS/DESIGN PRIOR TO ROOF REPLACEMENT
- 1511.1 EXCEPTIONS 1&2: REPLACEMENT SHALL NOT BE REQUIRED TO MEET THE SLOPE REQUIREMENT OF ¼" PER FOOT OR PROVIDE SECONDARY DRAINS OR SCUPPERS
- 1511.3.1.1 EXCEPTIONS 3: ROOF RECOVERING SHALL NOT BE PERMITTED OVER WATER SOAKED ROOFING OR OVER 2 OR MORE ROOF APPLICATIONS

NOTES:

- WHHS BLDG Z APPROXIMATE ROOF SQUARE FOOTAGE: 15,800 SF
- WHHS BLDG Z-1 APPROXIMATE ROOF SQUARE FOOTAGE: 4,500 SF
- WHHS BLDG Y-1 APPROXIMATE ROOF SQUARE FOOTAGE: 8,500 SF
- WHHS MEDIA CENTER APPROXIMATE ROOF SQUARE FOOTAGE: 7,300 SF
- NHHS WEIGHT ROOM APPROXIMATE ROOF SQUARE FOOTAGE: 1,200 SF
- FRMS WALKWAY CANOPY APPROXIMATE ROOF SQUARE FOOTAGE: 2,100 SF
- HMS WALK/ENTRY APPROXIMATE ROOF SQUARE FOOTAGE: 2,300 SF

BID ALTERNATES

- ALTERNATE NO. 1 - BUILDING Y-1 ROOF
ALTERNATE NO. 2 - HMS WALK/ENTRY ROOFS

ABBREVIATIONS:

- REPLACE= REMOVE EXISTING AND PROVIDE AS SHOWN AND SPECIFIED
- RD= ROOF DRAIN
- CMU= CONCRETE MASONRY UNITS
- CWFD= CEMENTITIOUS WOOD FIBER DECK
- POLYISO= POLYISOCYANURATE
- DS= DOWNSPOUT
- SPM= SINGLE PLY MEMBRANE
- EPS= EXPANDED POLYSTYRENE
- BUR= BUILT UP ROOFING



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GENERAL NOTES

- EXISTING WOOD NAILER SHALL REMAIN UNLESS DETERMINED TO BE DAMAGED BY OWNER. REMOVAL AND REPLACEMENT SHALL BE PERFORMED AT UNIT PRICE.
- VERIFY DIMENSIONS, QUANTITIES, SIZES, AND OTHER EXISTING CONDITIONS PRIOR TO DEMOLITION WORK. DISCREPANCIES BETWEEN DOCUMENTS AND EXISTING CONDITIONS SHALL BE REPORTED TO THE ARCHITECT.
- RAISE EXISTING VP'S AND MECHANICAL CURBS TO 8" ABOVE ROOFING. ELECTRICAL WORK, IF REQUIRED TO REMOVE VENTILATORS, SHALL BE PERFORMED BY LICENSED CONTRACTOR.
- CRICKETS SHALL SLOPE AT 1/2" PER FOOT.
- EXISTING ELECTRIC COMPONENTS, REFRIGERANT LINES, MECHANICAL UNITS, SHALL BE TEMPORARILY RELOCATED FOR FULL ROOFING INSTALLATION.
- SITE ACCESS, STAGING AND SCHEDULE TO BE COORDINATED WITH PRINCIPAL.
- PROVIDE 18-8 OR 304 STAINLESS STEEL FASTENERS WHERE IN CONTACT WITH PRESSURE TREATED WOOD.
- CONTRACTOR SHALL TAKE MEASURES TO PROTECT EXISTING ROOFING NIC AND SHALL BE RESPONSIBLE FOR ANY DAMAGES INCURRED DURING WORK TO PROVIDE WARRANTY REPAIR.
- CONTRACTOR SHALL PERFORM ALL WORK IN COMPLIANCE WITH THE AHJ. COSTS FOR PERMITS SHALL BE INCLUDED IN WORK. PROVIDE INSPECTION DOCUMENTS TO THE OWNER.

ROOFING NOTES

- EXISTING ROOFING COMPONENTS:
 FULLY ADHERED SPM (EPDM) MEMBRANE
 1/2" FIBERBOARD
 BUILT-UP ROOFING
 TAPERED PERLITE INSULATION (1 1/2"-5 1/4"±)
 VAPOR BARRIER
 CWFD
- DEMOLITION: REMOVE EXISTING SPM & FIBERBOARD. REMOVE EXISTING ROOFING SYSTEM COMPONENTS INCLUDING TERMINATION BARS & FLASHING. THE EXISTING VAPOR BARRIER, PERLITE INSULATION, AND B.U. ROOFING SHALL REMAIN.
- PROVIDE FULLY ADHERED 60 MIL TPO MEMBRANE ROOFING SYSTEM, AND 1/4" COVER BOARD OVER EXISTING B.U. ROOFING. ATTACH TAPERED INSULATION THROUGH INTO EXISTING CWFD.

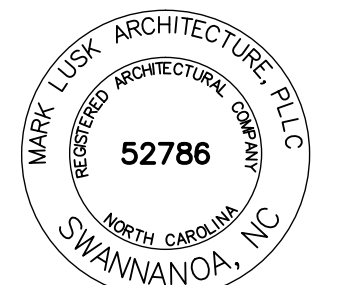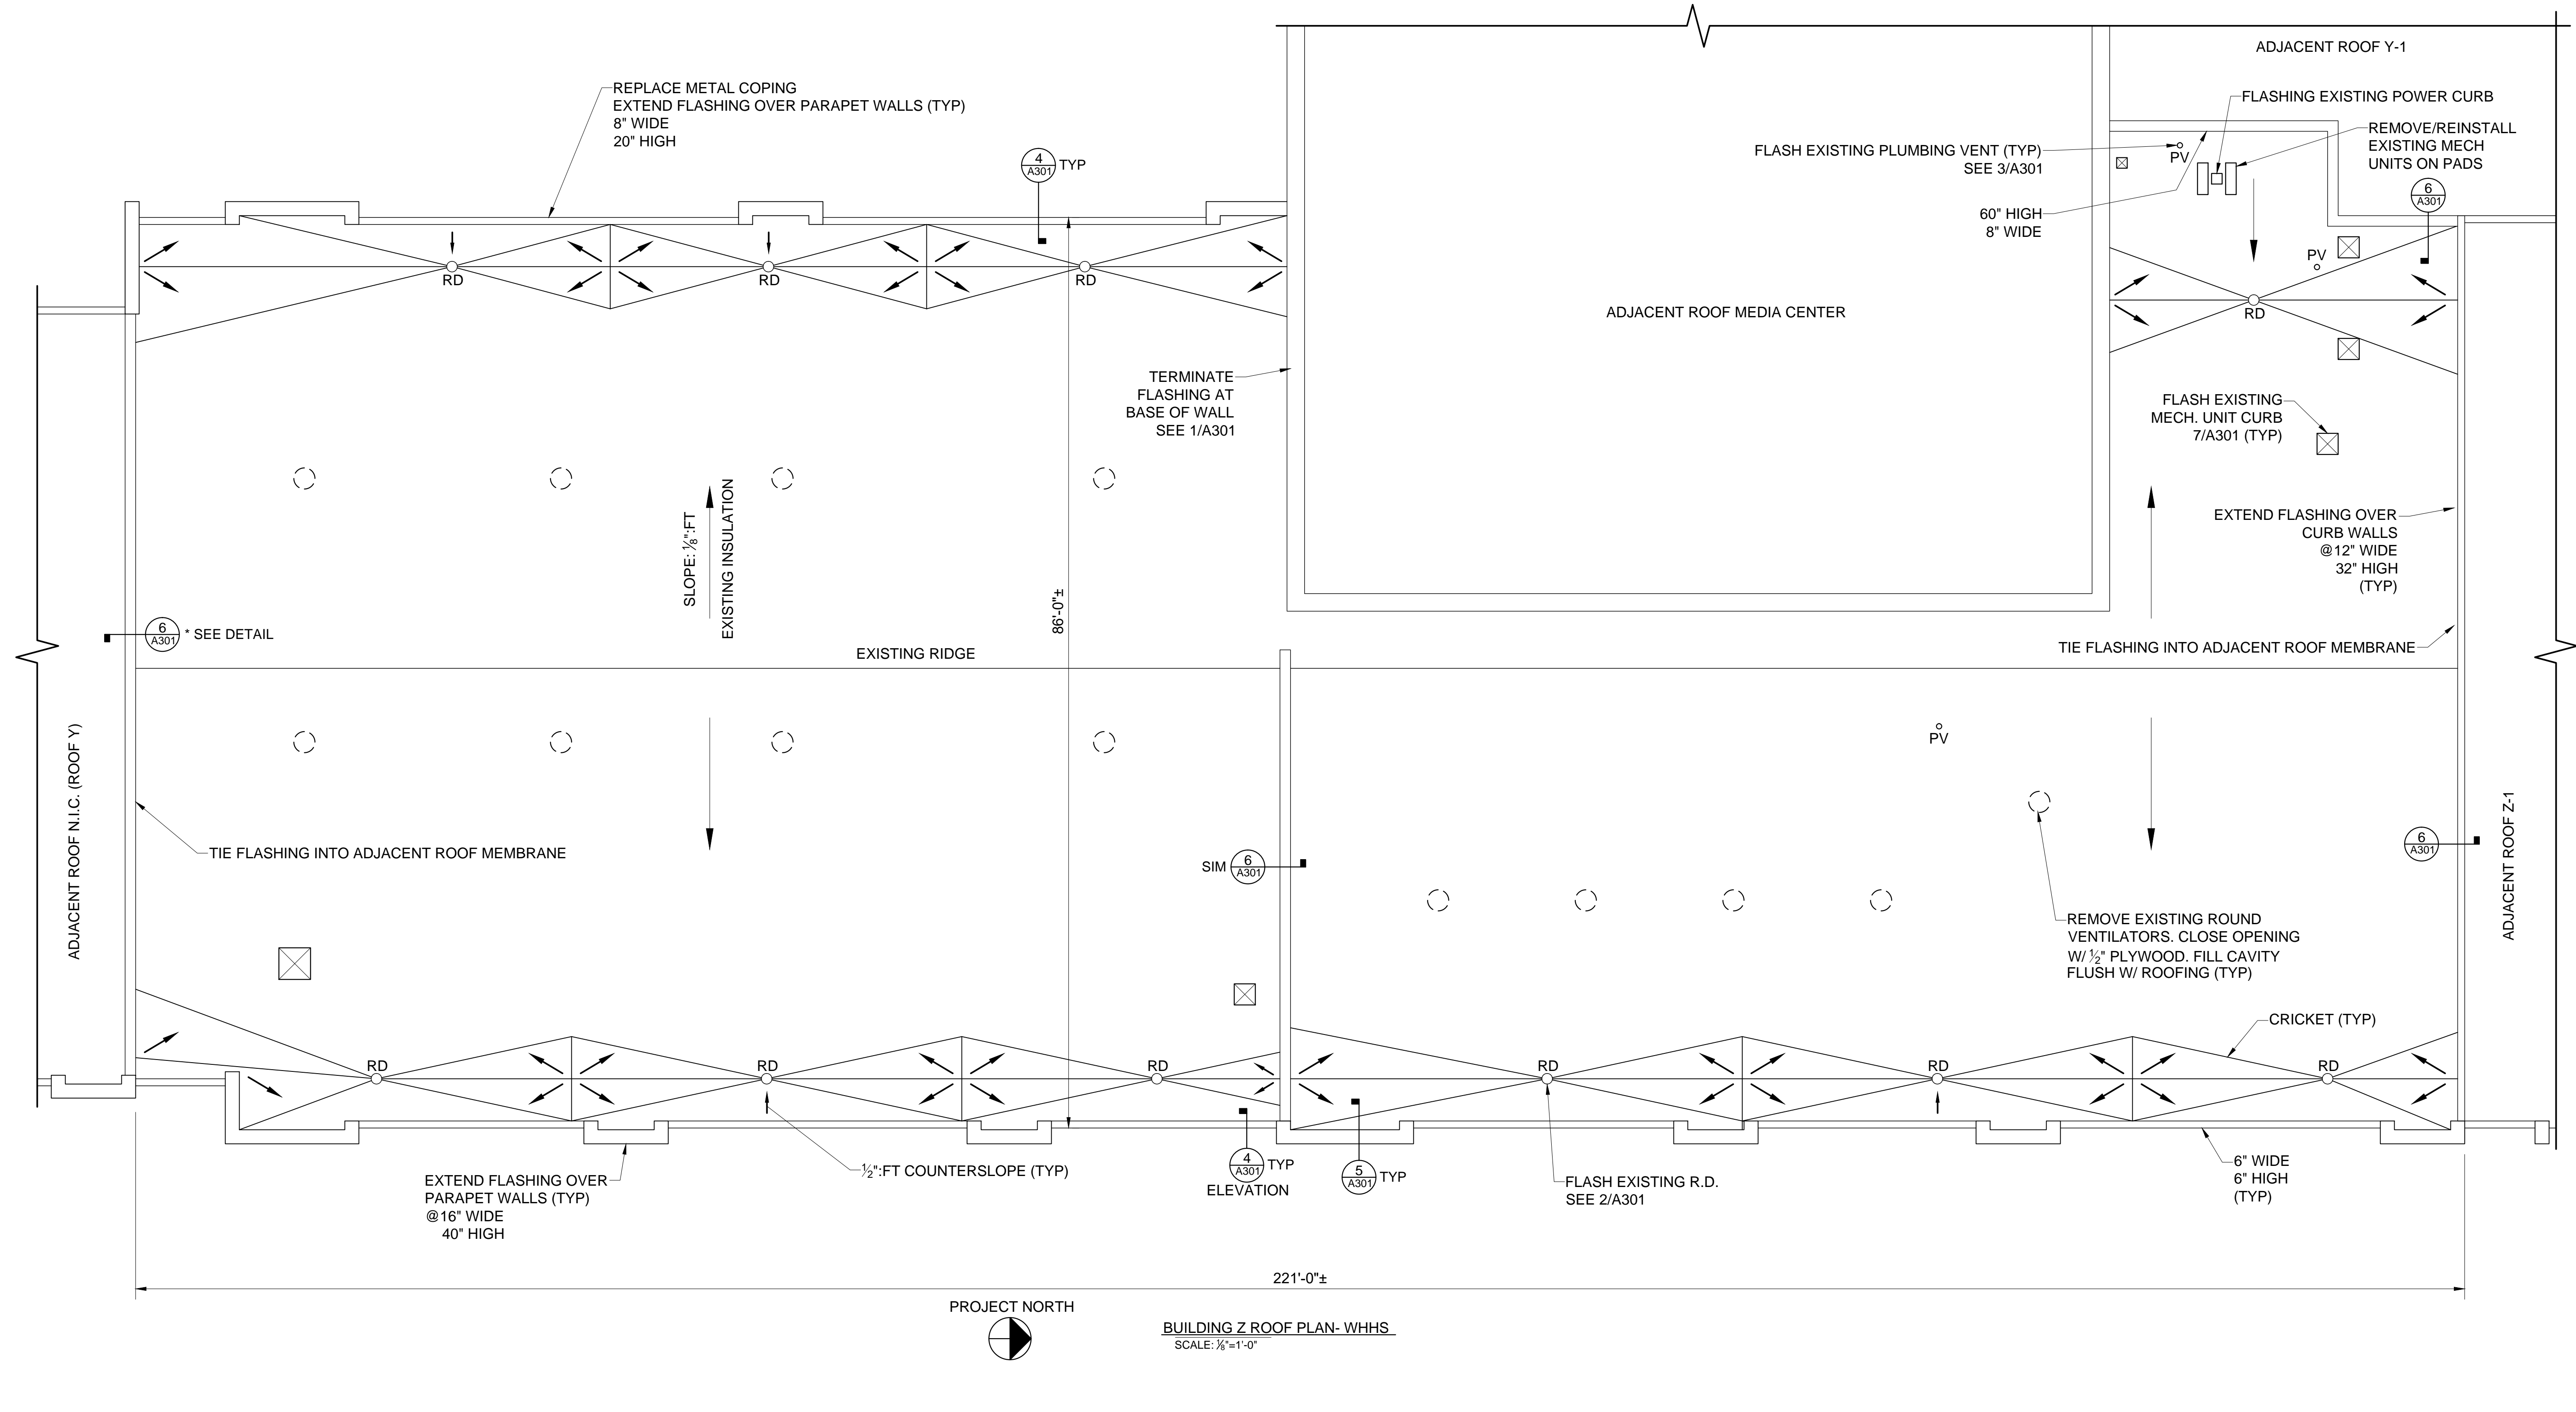

HCPS ROOF REPLACEMENTS AT WHHS, NHHS, HMS & FRMS

Project Number: 23002
 Checked:
 Drawn: A. Rognas
 Date: 9/5/23
 Revisions:

BUILDING Z ROOF PLAN- WEST HENDERSON HIGH

A201


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GENERAL NOTES


- EXISTING WOOD NAILER SHALL REMAIN UNLESS DETERMINED TO BE DAMAGED BY OWNER. REMOVAL AND REPLACEMENT SHALL BE PERFORMED AT UNIT PRICE.
- VERIFY DIMENSIONS, QUANTITIES, SIZES, AND OTHER EXISTING CONDITIONS PRIOR TO DEMOLITION WORK. DISCREPANCIES BETWEEN DOCUMENTS AND EXISTING CONDITIONS SHALL BE REPORTED TO THE ARCHITECT.
- RAISE EXISTING VP'S AND MECHANICAL CURBS TO 8" ABOVE ROOFING. ELECTRICAL WORK, IF REQUIRED TO REMOVE VENTILATORS, SHALL BE PERFORMED BY LICENSED CONTRACTOR.
- CRICKETS SHALL SLOPE AT 1/2" PER FOOT.
- EXISTING ELECTRIC COMPONENTS AND MECHANICAL UNITS SHALL BE TEMPORARILY RELOCATED FOR FULL ROOFING INSTALLATION.
- SITE ACCESS, STAGING AND SCHEDULE TO BE COORDINATED WITH PRINCIPAL.
- PROVIDE 18-8 OR 304 STAINLESS STEEL FASTENERS WHERE IN CONTACT WITH PRESSURE TREATED WOOD.
- CONTRACTOR SHALL TAKE MEASURES TO PROTECT EXISTING ROOFING NIC AND SHALL BE RESPONSIBLE FOR ANY DAMAGES INCURRED DURING WORK TO PROVIDE WARRANTY REPAIR.
- CONTRACTOR SHALL PERFORM ALL WORK IN COMPLIANCE WITH THE AHJ. COSTS FOR PERMITS SHALL BE INCLUDED IN WORK. PROVIDE INSPECTION DOCUMENTS TO THE OWNER.

ROOFING NOTES

- EXISTING ROOFING COMPONENTS:
 - STONE BALLAST
 - LOOSE LAID SPM (EPDM) MEMBRANE
 - 1/2" FIBERBOARD
 - 2" POLYISO INSULATION
 - 1/2" GYPSUM BOARD
 - METAL ROOF DECK (SLOPES)
- DEMOLITION: REMOVE EXISTING STONE BALLAST. REMOVE EXISTING ROOFING SYSTEM COMPONENTS INCLUDING TERMINATION BARS & FLASHING. EXISTING SPM (AND BELOW) ROOFING SHALL REMAIN.
- PROVIDE FULLY ADHERED 60 MIL TPO MEMBRANE ROOFING SYSTEM, AND 1/4" COVER BOARD OVER EXISTING SPM ROOFING. ATTACH 1/4" COVER BOARD THROUGH INTO EXISTING METAL ROOF DECK. CUT OPEN EXISTING EPDM.

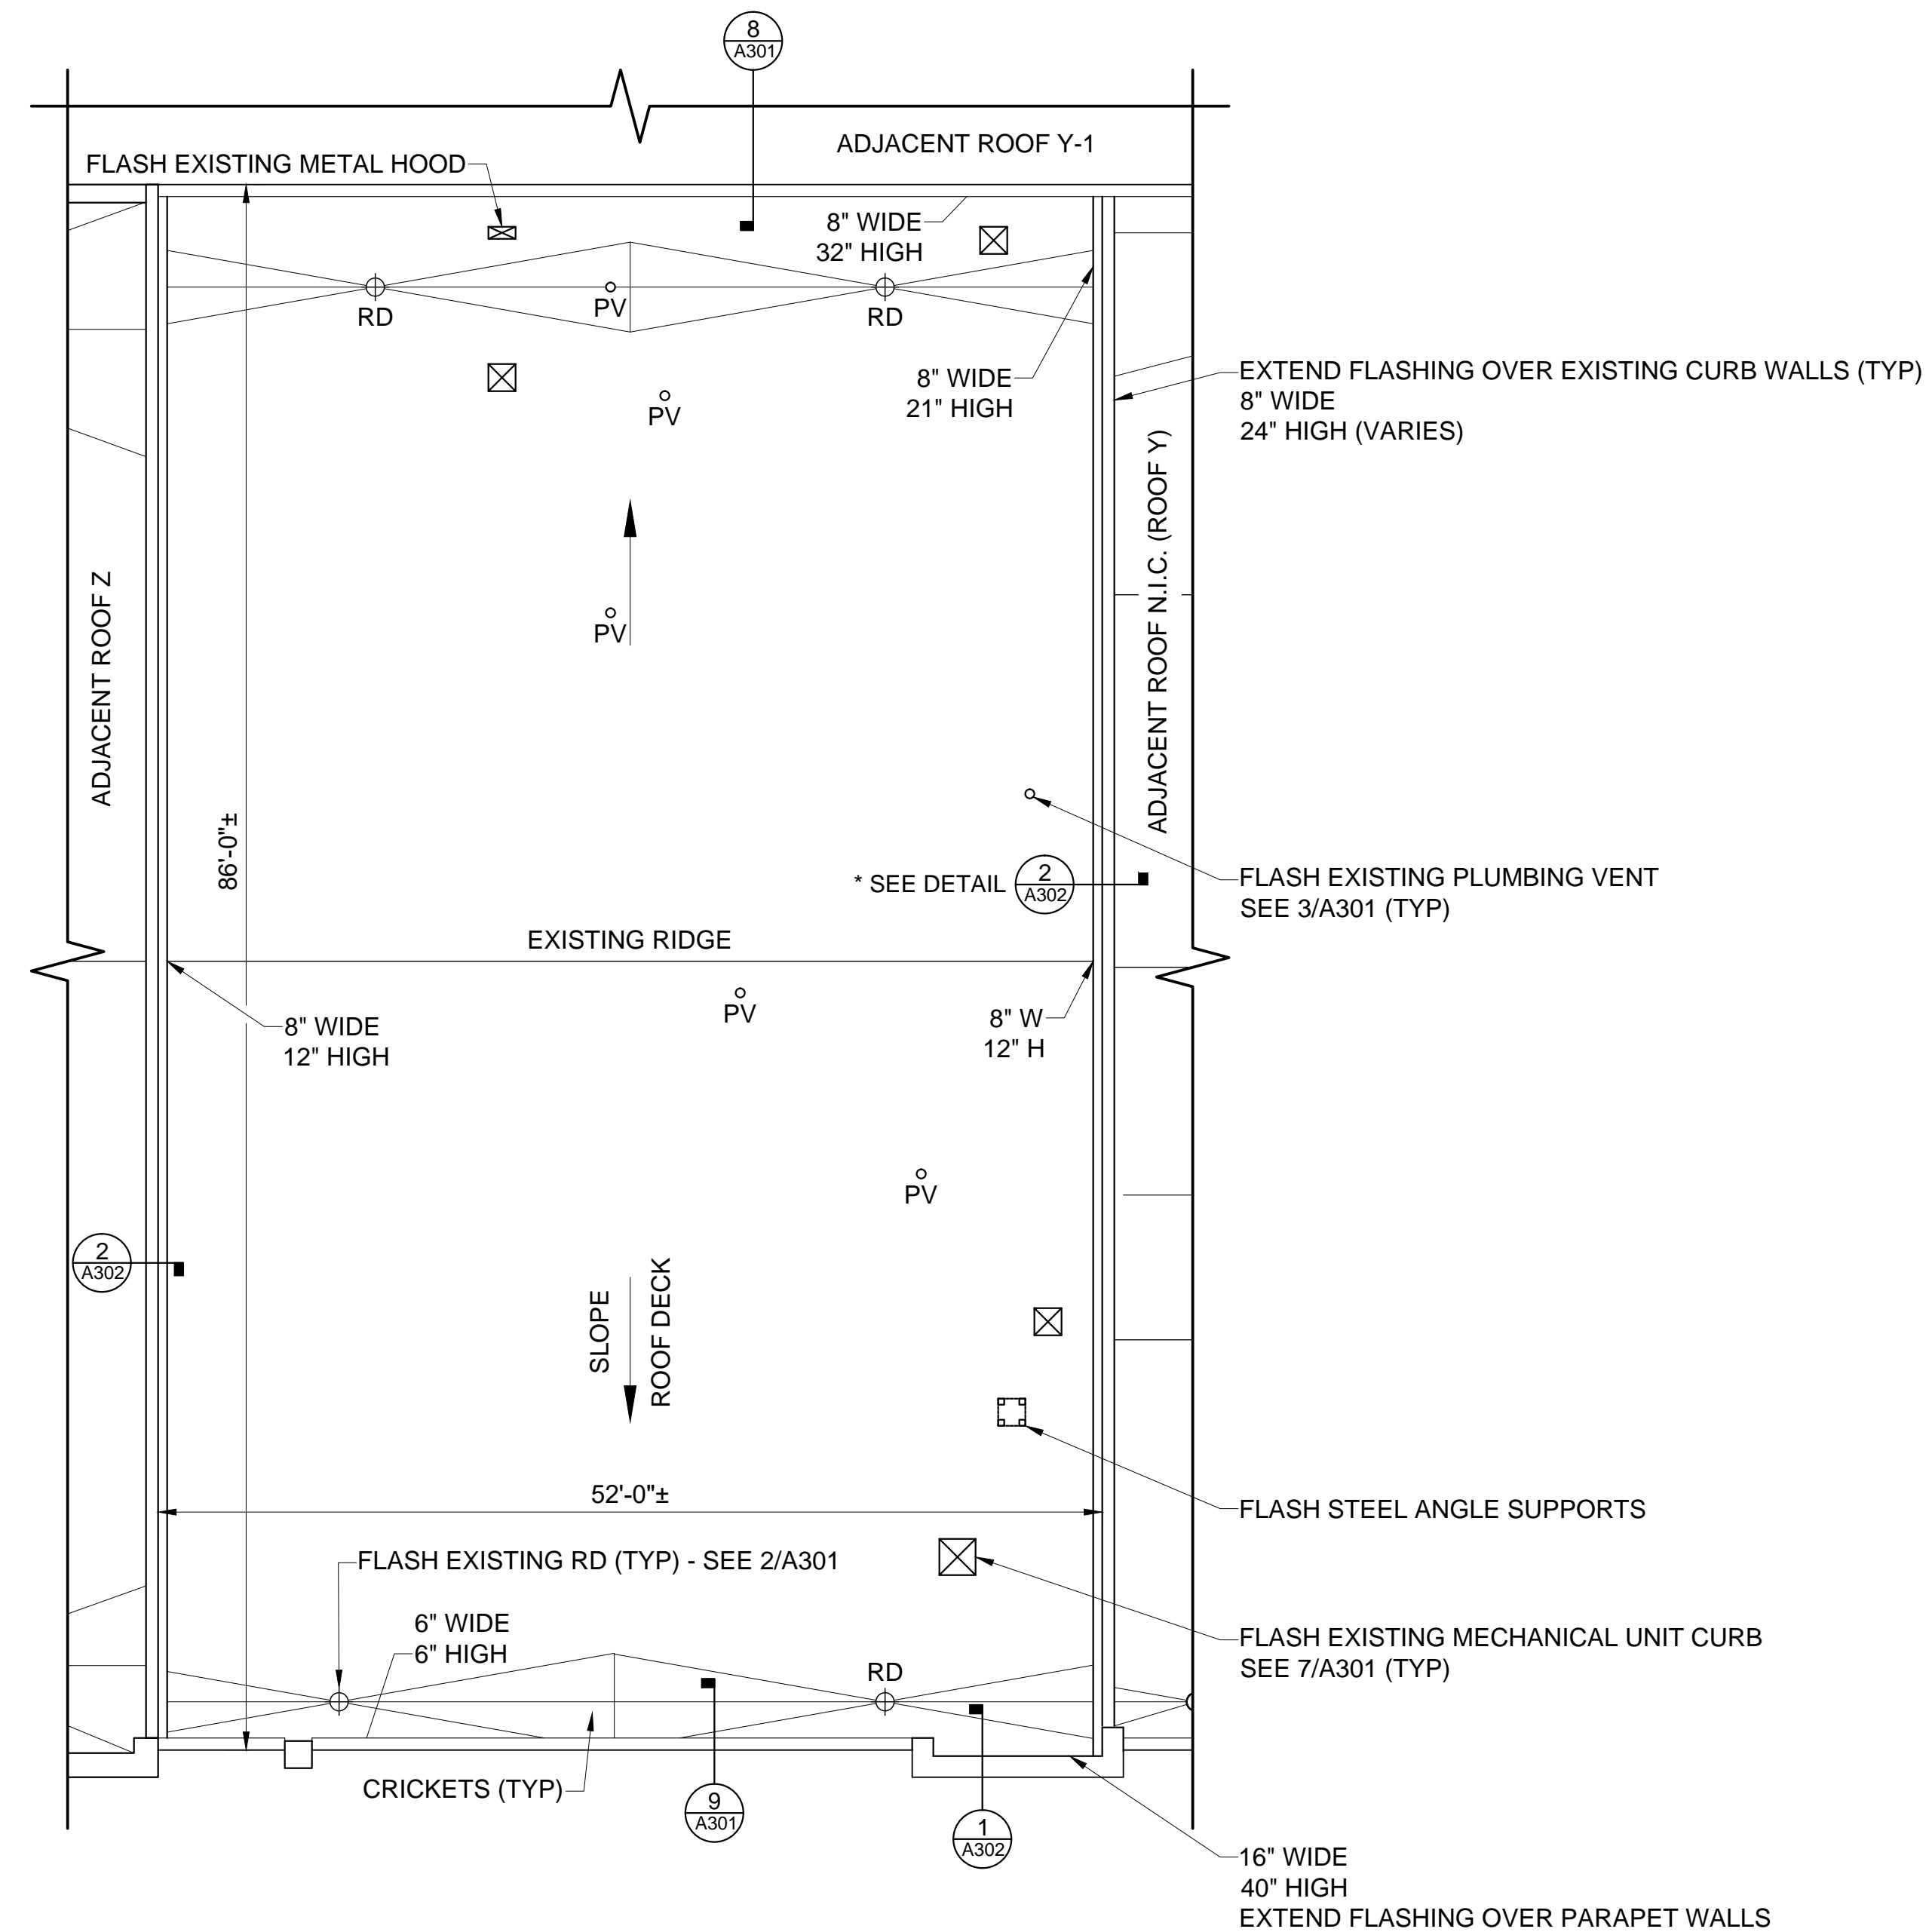

BUILDING Z-1 ROOF PLAN- WHHS
SCALE: 1/8"=1'-0"

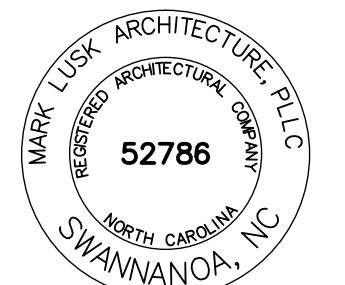

HCPS ROOF REPLACEMENTS AT WHHS, NHHS, HMS & FRMS

Project Number: 23002
Checked:
Drawn: A. Rognas
Date: 9/5/23
Revisions:

BUILDING Z-1 ROOF PLAN- WEST HENDERSON HIGH

A202


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GENERAL NOTES

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- VERIFY DIMENSIONS, QUANTITIES, SIZES, AND OTHER EXISTING CONDITIONS PRIOR TO DEMOLITION WORK. DISCREPANCIES BETWEEN DOCUMENTS AND EXISTING CONDITIONS SHALL BE REPORTED TO THE ARCHITECT.
- RAISE EXISTING VP'S AND MECHANICAL CURBS TO 8" ABOVE ROOFING. ELECTRICAL WORK, IF REQUIRED TO REMOVE VENTILATORS, SHALL BE PERFORMED BY LICENSED CONTRACTOR.
- CRICKETS SHALL SLOPE AT 1/2" PER FOOT.
- EXISTING ELECTRIC COMPONENTS AND MECHANICAL UNITS SHALL BE TEMPORARILY RELOCATED FOR FULL ROOFING INSTALLATION.
- SITE ACCESS, STAGING AND SCHEDULE TO BE COORDINATED WITH PRINCIPAL.
- PROVIDE 18-8 OR 304 STAINLESS STEEL FASTENERS WHERE IN CONTACT WITH PRESSURE TREATED WOOD.
- CONTRACTOR SHALL TAKE MEASURES TO PROTECT EXISTING ROOFING NIC AND SHALL BE RESPONSIBLE FOR ANY DAMAGES INCURRED DURING WORK TO PROVIDE WARRANTY REPAIR.
- CONTRACTOR SHALL PERFORM ALL WORK IN COMPLIANCE WITH THE AHJ. COSTS FOR PERMITS SHALL BE INCLUDED IN WORK. PROVIDE INSPECTION DOCUMENTS TO THE OWNER.

ROOFING NOTES

- EXISTING ROOFING COMPONENTS:
 - STONE BALLAST
 - LOOSE LAID SPM (EPDM) MEMBRANE
 - 1/2" FIBERBOARD
 - 1 1/2" POLYISO INSULATION
 - 1/2" GYPSUM BOARD
 - METAL ROOF DECK(SLOPES)
- DEMOLITION: REMOVE EXISTING STONE BALLAST. REMOVE EXISTING ROOFING SYSTEM COMPONENTS INCLUDING TERMINATION BARS & FLASHING. EXISTING SPM (AND BELOW) ROOFING SHALL REMAIN.
- PROVIDE FULLY ADHERED 60 MIL TPO MEMBRANE ROOFING SYSTEM, AND 1/4" COVER BOARD OVER EXISTING SPM ROOFING. ATTACH 1/4" COVER BOARD THROUGH INTO EXISTING METAL ROOF DECK. CUT OPEN EXISTING EPDM.

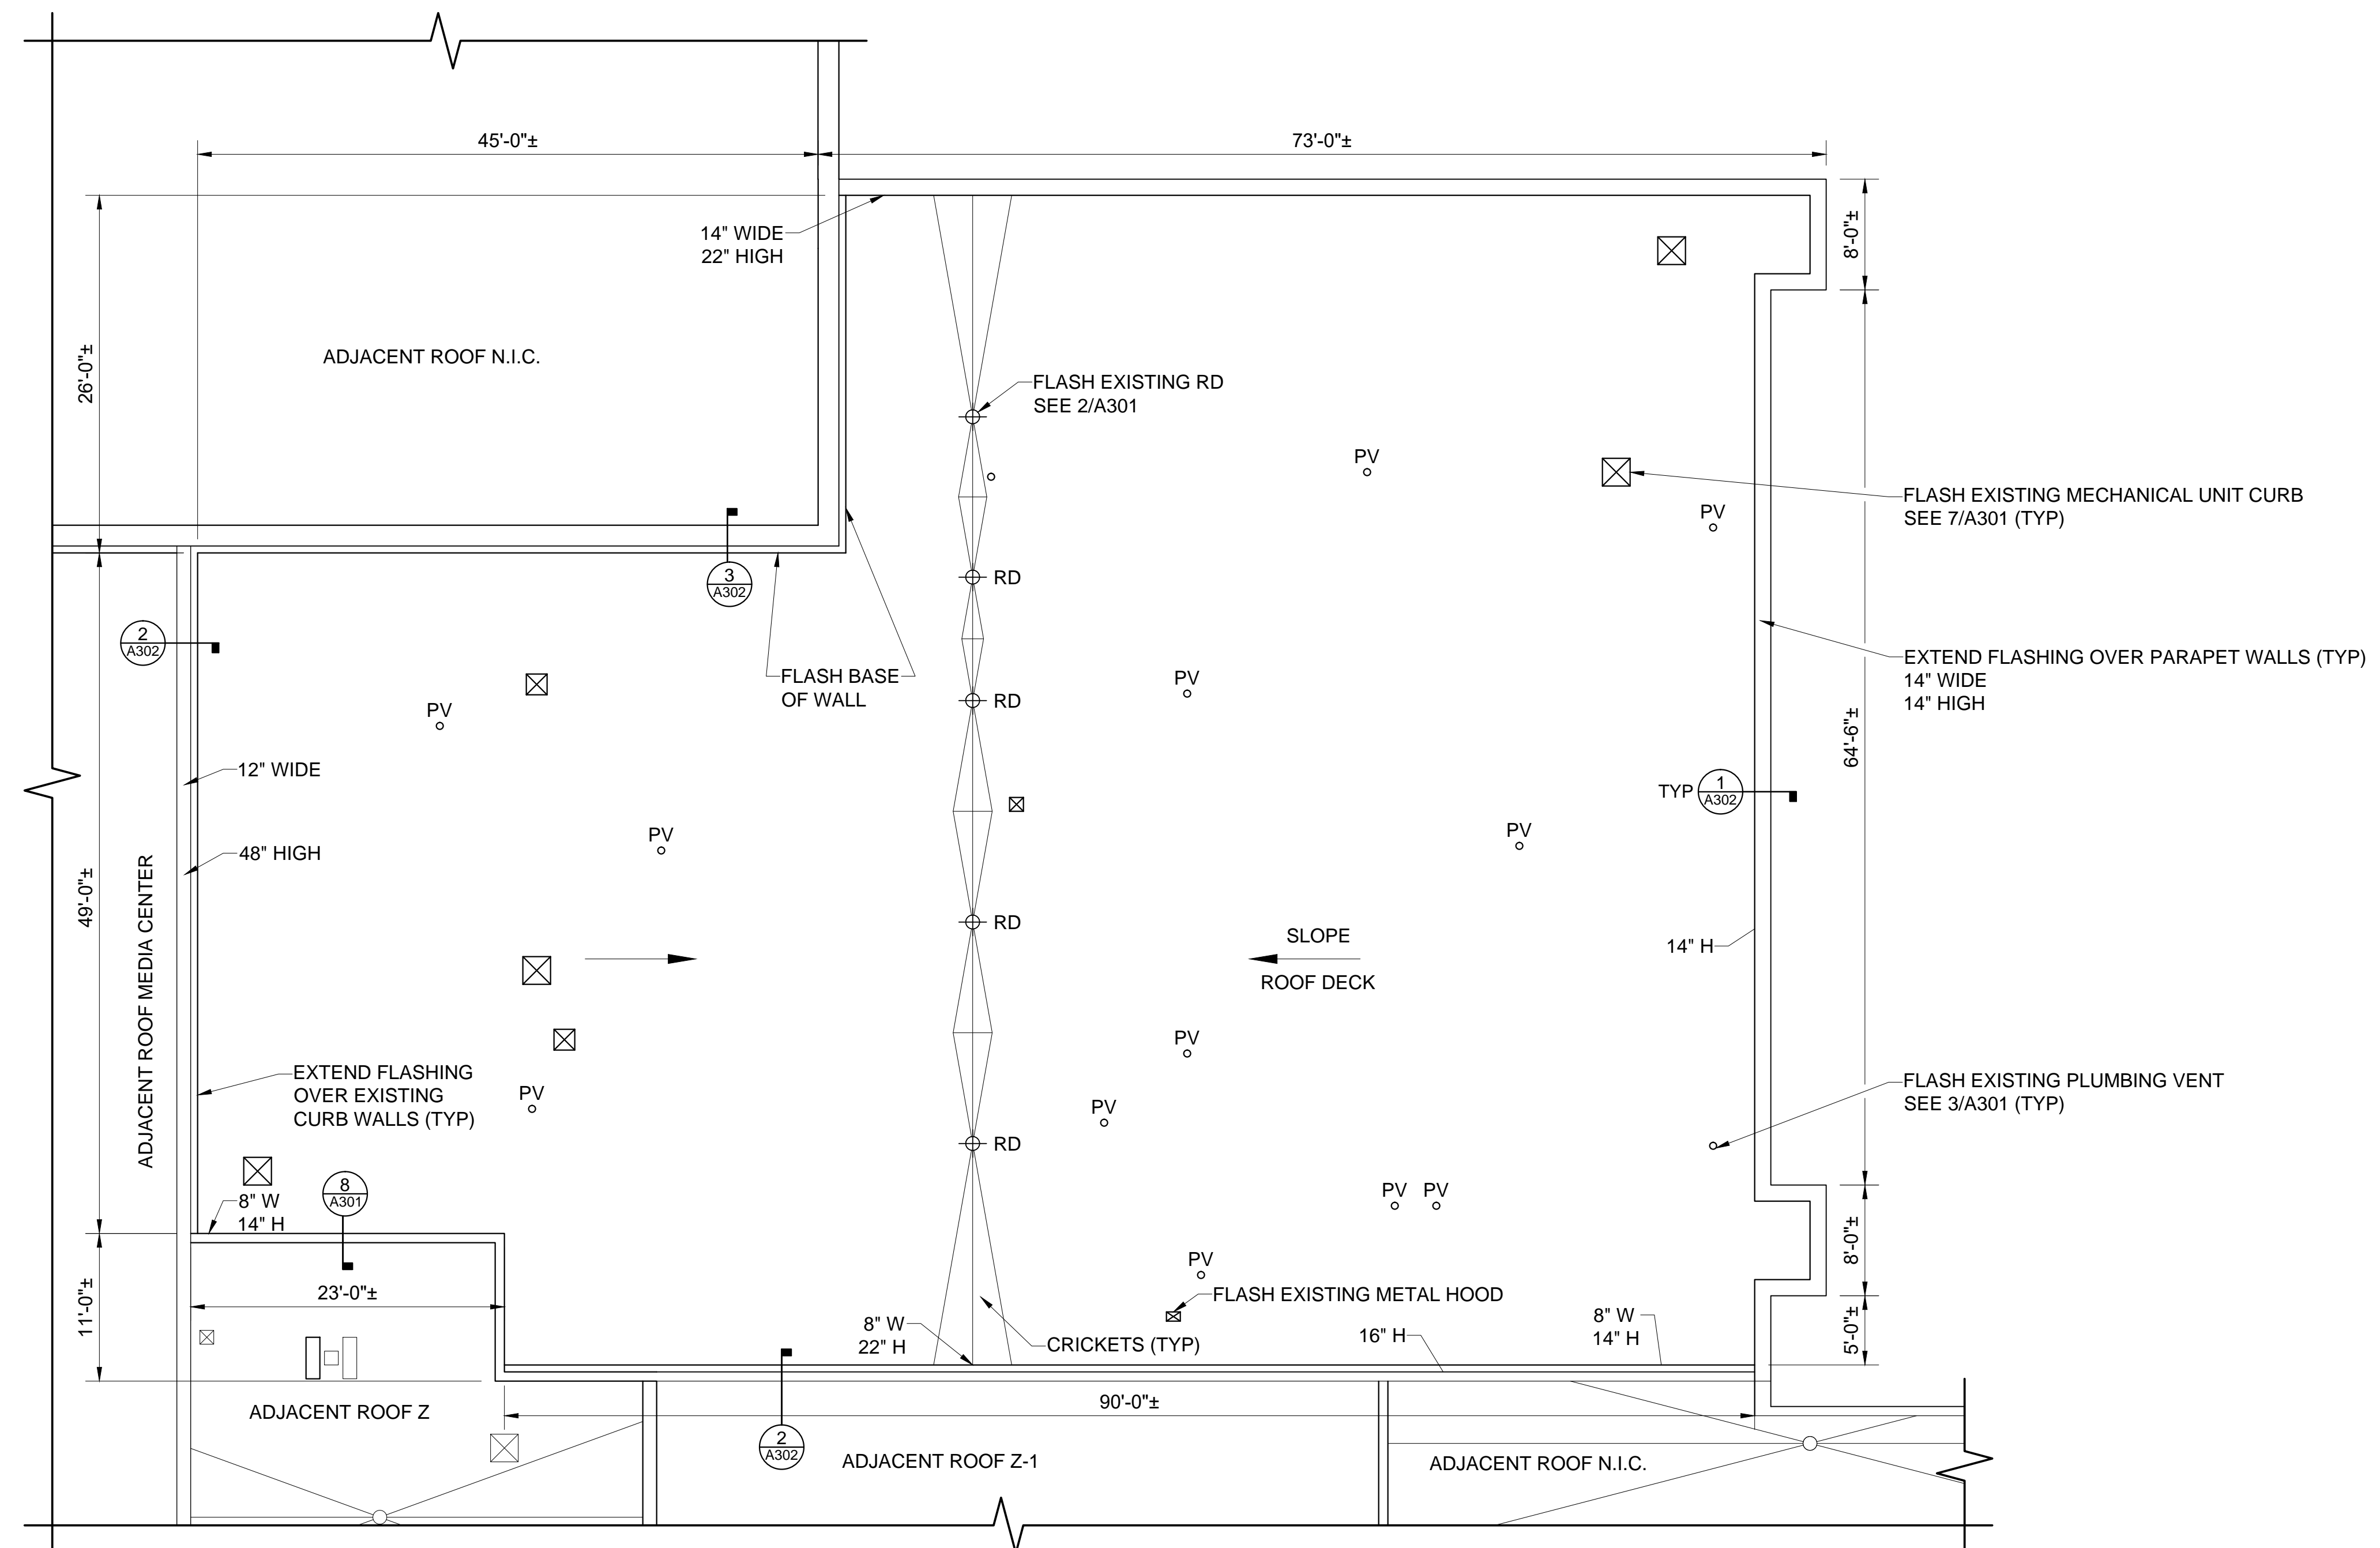

BUILDING Y-1 ROOF PLAN-WHHS
SCALE: 1/8"=1'-0"

THIS SHEET IS ALTERNATE NO. 1

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HCPS ROOF REPLACEMENTS AT WHHS, NHHS, HMS & FRMS

Project Number: 23002
Checked:
Drawn: A. Rognas
Date: 9/5/23
Revisions:

BUILDING Y-1 ROOF PLAN-WEST HENDERSON HIGH


A203

GENERAL NOTES

- EXISTING WOOD NAILER SHALL REMAIN UNLESS DETERMINED TO BE DAMAGED BY OWNER. REMOVAL AND REPLACEMENT SHALL BE PERFORMED AT UNIT PRICE.
- VERIFY DIMENSIONS, QUANTITIES, SIZES, AND OTHER EXISTING CONDITIONS PRIOR TO DEMOLITION WORK. DISCREPANCIES BETWEEN DOCUMENTS AND EXISTING CONDITIONS SHALL BE REPORTED TO THE ARCHITECT.
- RAISE EXISTING VP'S TO 8" ABOVE ROOFING. .
- CRICKETS SHALL SLOPE AT 1/2" PER FOOT.
- SITE ACCESS, STAGING AND SCHEDULE TO BE COORDINATED WITH PRINCIPAL.
- PROVIDE 18-8 OR 304 STAINLESS STEEL FASTENERS WHERE IN CONTACT WITH PRESSURE TREATED WOOD.
- CONTRACTOR SHALL TAKE MEASURES TO PROTECT EXISTING ROOFING NIC AND SHALL BE RESPONSIBLE FOR ANY DAMAGES INCURRED DURING WORK TO PROVIDE WARRANTY REPAIR.
- CONTRACTOR SHALL PERFORM ALL WORK IN COMPLIANCE WITH THE AHJ. COSTS FOR PERMITS SHALL BE INCLUDED IN WORK. PROVIDE INSPECTION DOCUMENTS TO THE OWNER.

ROOFING NOTES

- EXISTING ROOFING COMPONENTS:
 - STONE BALLAST
 - LOOSE LAID SPM (EPDM) MEMBRANE
 - 1/2" FIBERBOARD
 - SPM (PVC) MEMBRANE
 - 1/2" EPS
 - 1 1/2" POLYISO INSULATION
 - 5/8" GYPSUM BOARD
 - METAL ROOF DECK
- DEMOLITION: REMOVE EXISTING STONE BALLAST, EPDM MEMBRANE, 1/2" FIBERBOARD, PVC MEMBRANE, AND 1/2" EPS. REMOVE EXISTING ROOFING SYSTEM COMPONENTS INCLUDING TERMINATION BARS & FLASHING. EXISTING 1 1/2" POLYISO INSULATION (AND BELOW) SHALL REMAIN.
- PROVIDE FULLY ADHERED 60 MIL TPO MEMBRANE ROOFING SYSTEM, AND 1/4" COVER BOARD OVER EXISTING 1 1/2" POLYISO INSULATION. ATTACH 1/4" COVER BOARD THROUGH INTO EXISTING METAL ROOF DECK.

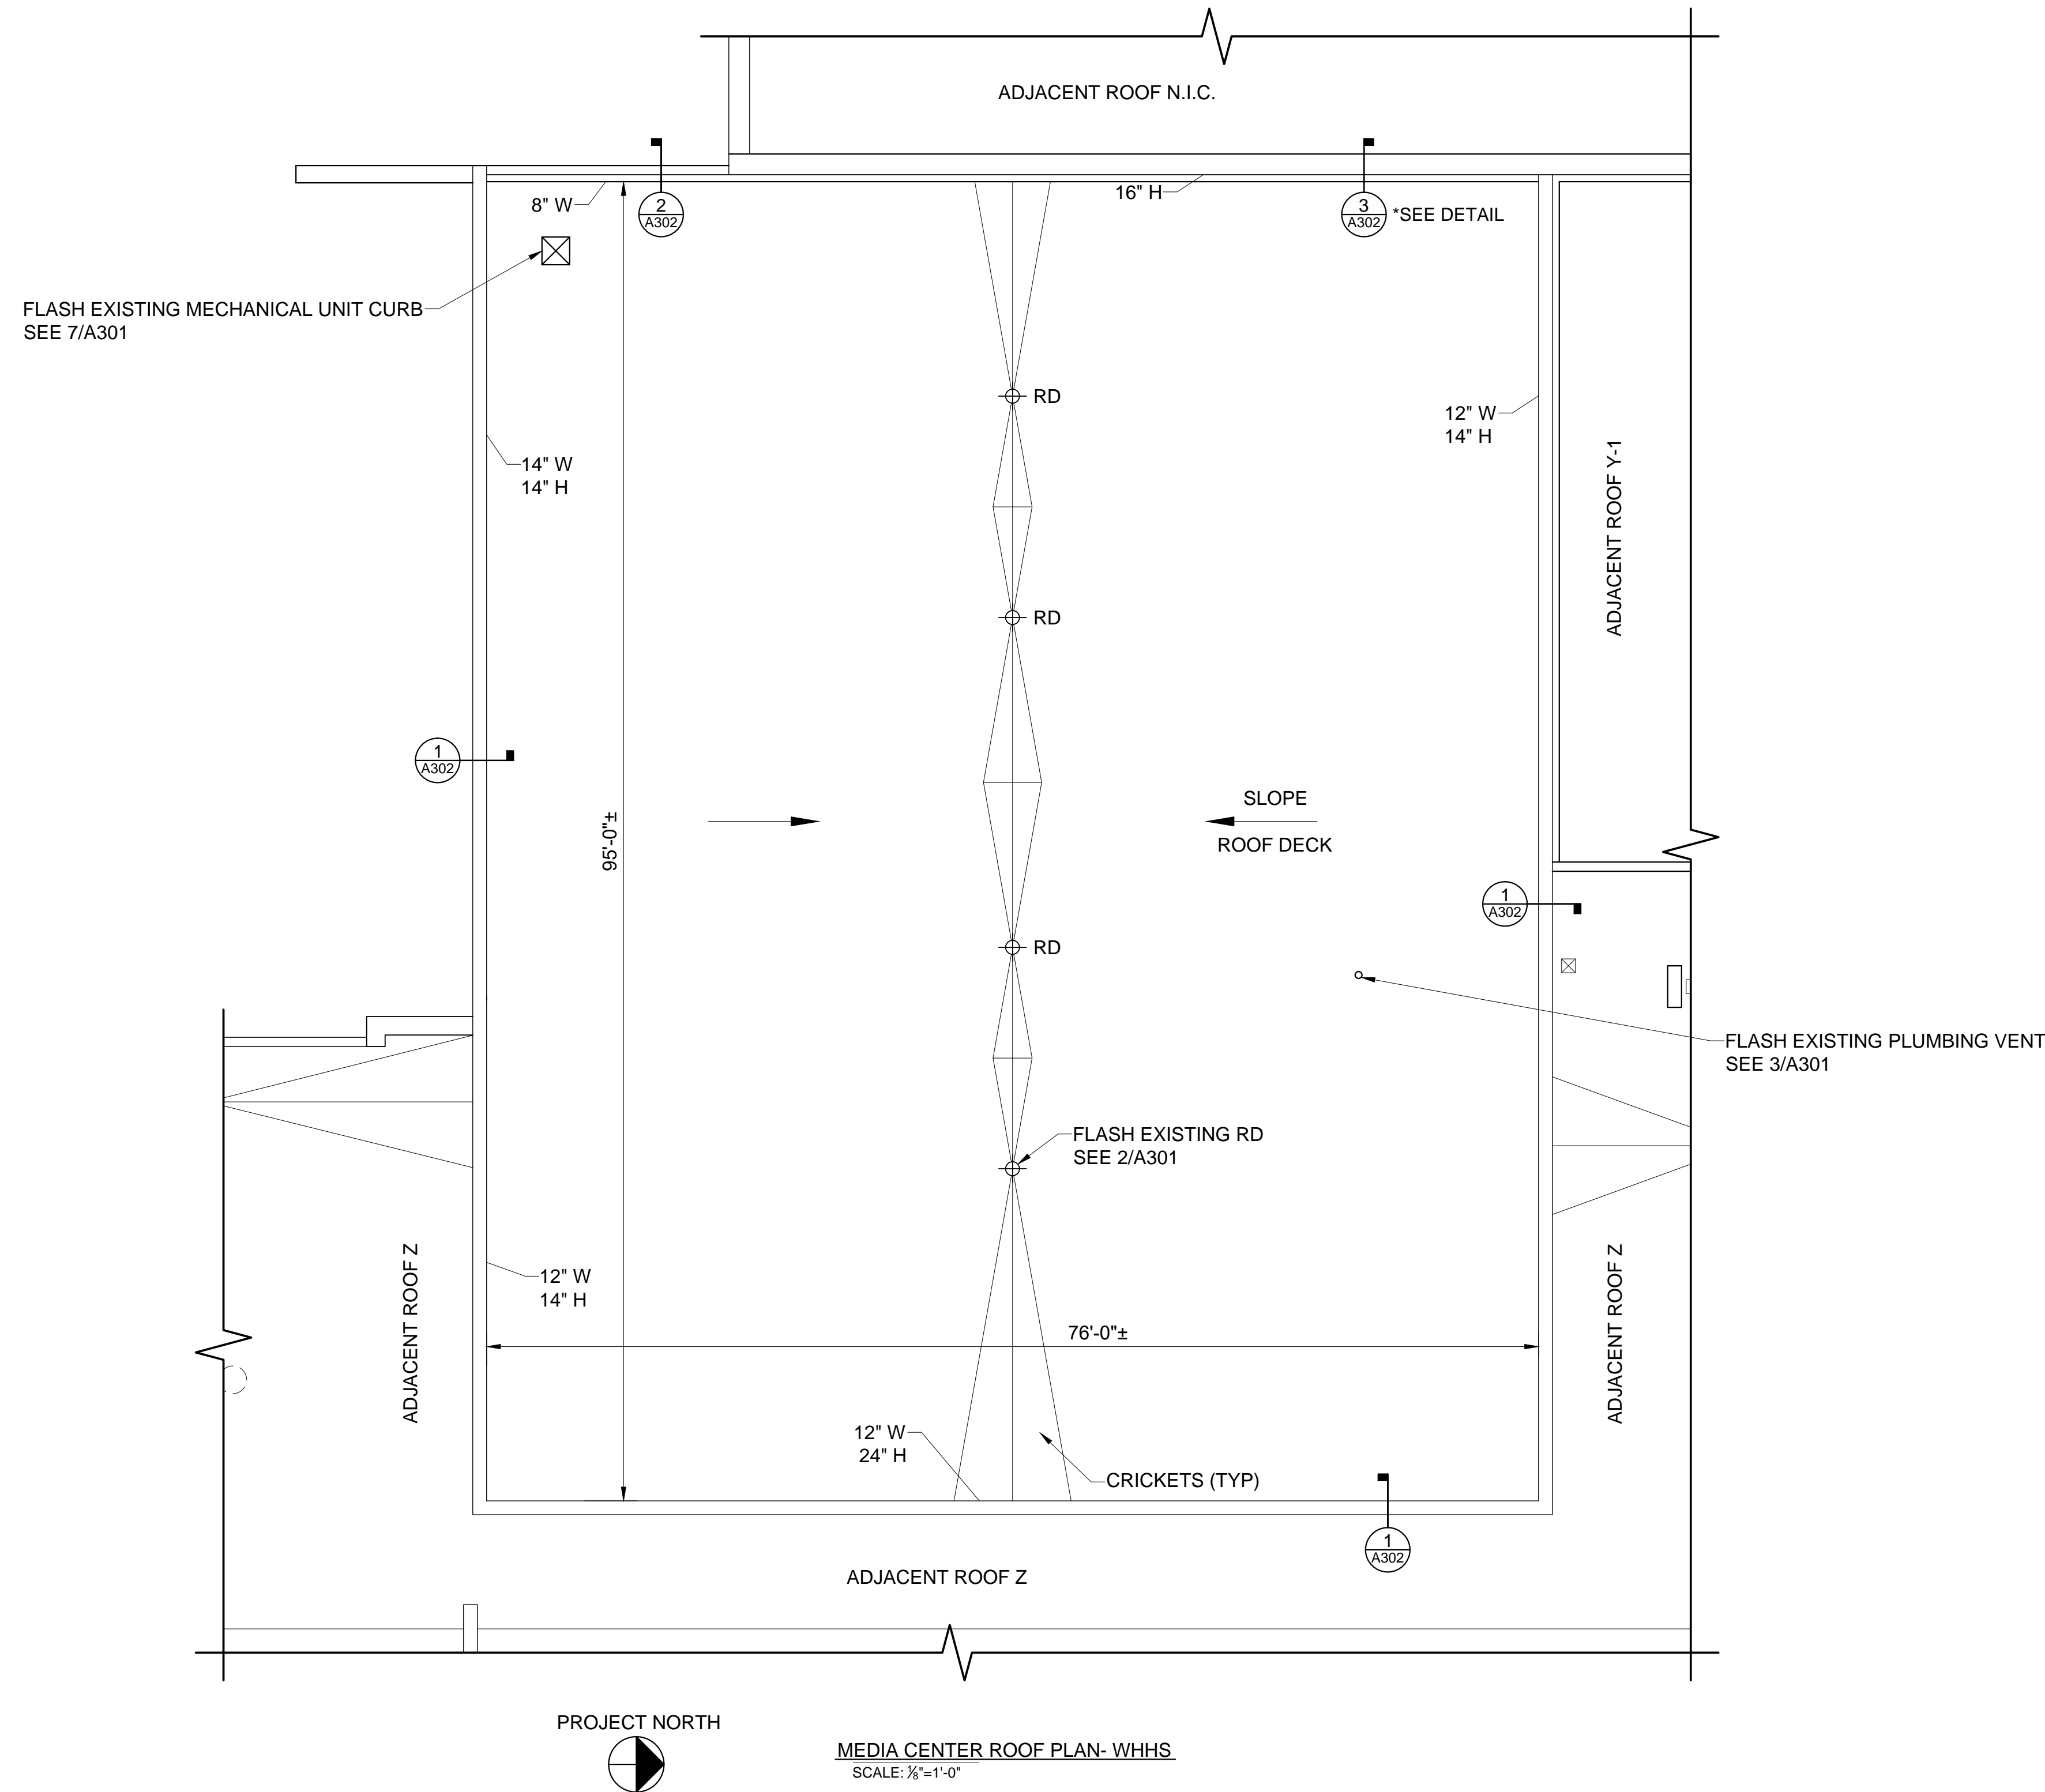

MEDIA CENTER ROOF PLAN- WHHS
SCALE: 1/8"=1'-0"



HCPS ROOF REPLACEMENTS AT WHHS, NHHS, HMS & FRMS

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Drawn: A. Rognas
Date: 9/5/23
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MEDIA CENTER ROOF PLAN- WEST HENDERSON HIGH

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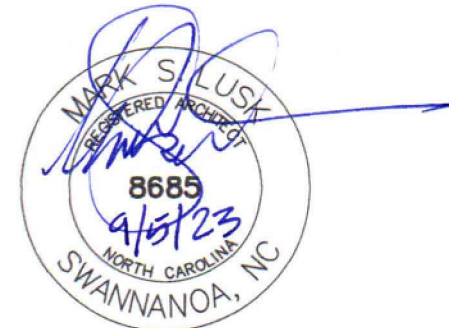
GENERAL NOTES

- EXISTING WOOD NAILER SHALL REMAIN UNLESS DETERMINED TO BE DAMAGED BY OWNER. REMOVAL AND REPLACEMENT SHALL BE PERFORMED AT UNIT PRICE.
- VERIFY DIMENSIONS, QUANTITIES, SIZES, AND OTHER EXISTING CONDITIONS PRIOR TO DEMOLITION WORK. DISCREPANCIES BETWEEN DOCUMENTS AND EXISTING CONDITIONS SHALL BE REPORTED TO THE ARCHITECT.
- CRICKETS SHALL SLOPE AT 1/2" PER FOOT.
- SITE ACCESS, STAGING AND SCHEDULE TO BE COORDINATED WITH PRINCIPAL.
- PROVIDE 18-8 OR 304 STAINLESS STEEL FASTENERS WHERE IN CONTACT WITH PRESSURE TREATED WOOD.
- CONTRACTOR SHALL PERFORM ALL WORK IN COMPLIANCE WITH THE AHJ. COSTS FOR PERMITS SHALL BE INCLUDED IN WORK. PROVIDE INSPECTION DOCUMENTS TO THE OWNER.

ROOFING NOTES

- EXISTING ROOFING COMPONENTS:
 - FULLY ADHERED SPM (EPDM) MEMBRANE
 - TAPERED INSULATION (3"-7 1/2"±)
 - METAL ROOF DECK
- DEMOLITION: REMOVE EXISTING ROOFING SYSTEM COMPONENTS INCLUDING TERMINATION BARS & FLASHING. EXISTING SPM (AND BELOW) SHALL REMAIN.
- PROVIDE FULLY ADHERED 60 MIL TPO MEMBRANE ROOFING SYSTEM, AND 1/4" COVER BOARD OVER EXISTING SPM ROOFING. ATTACH 1/4" COVER BOARD THROUGH INTO EXISTING METAL ROOF DECK. CUT OPEN EXISTING EPDM.

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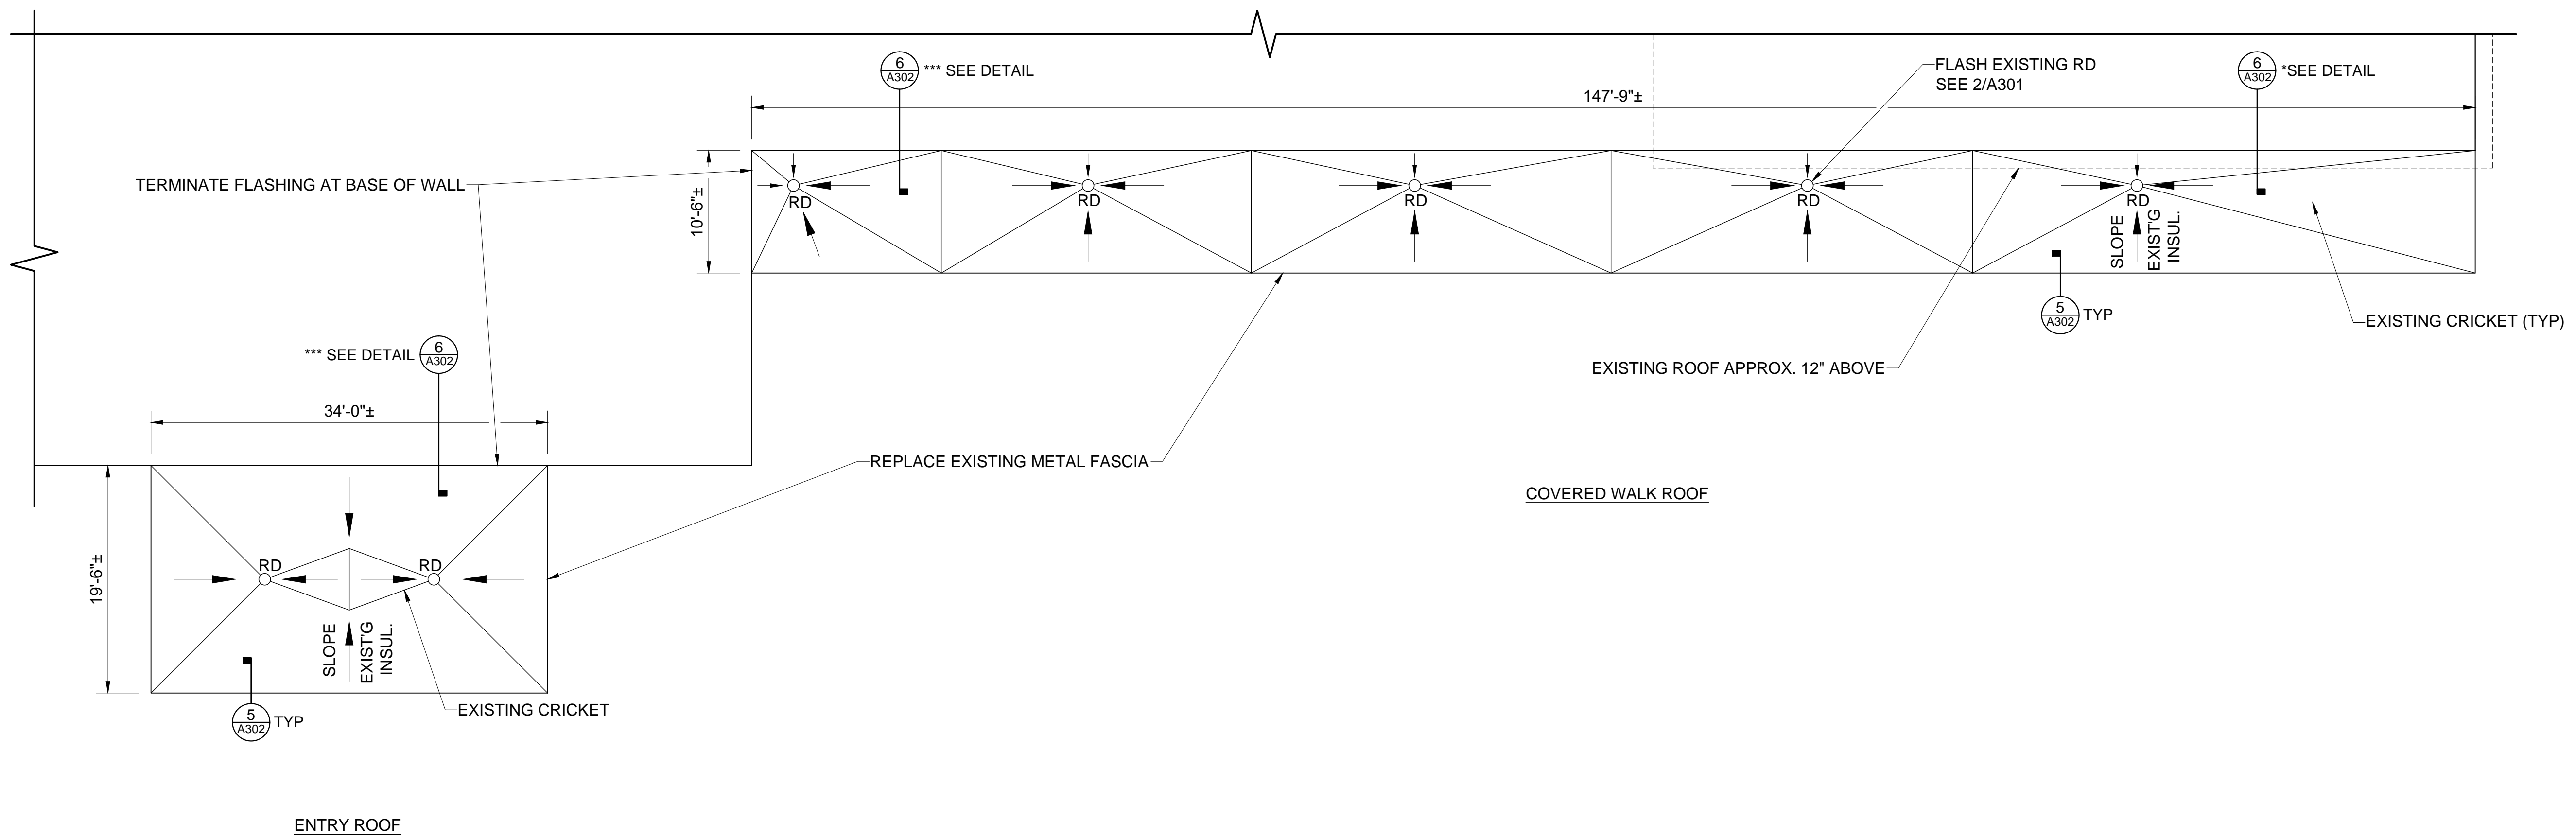


HCPS ROOF REPLACEMENTS AT WHHS, NHHS, HMS & FRMS

Project Number: 23002
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 Drawn: A. Rognas
 Date: 9/5/23
 Revisions: _____

HENDERSONVILLE MIDDLE WALK/ENTRY ROOFS

A205



HENDERSONVILLE MIDDLE- WALK/ENTRY ROOFS
 SCALE: 1/8"=1'-0"

THIS SHEET IS ALTERNATE NO. 2

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GENERAL NOTES



1. VERIFY DIMENSIONS, QUANTITIES, SIZES, AND OTHER EXISTING CONDITIONS PRIOR TO DEMOLITION WORK. DISCREPANCIES BETWEEN DOCUMENTS AND EXISTING CONDITIONS SHALL BE REPORTED TO THE ARCHITECT.
2. SITE ACCESS, STAGING AND SCHEDULE TO BE COORDINATED WITH PRINCIPAL.
3. PROVIDE 18-8 OR 304 STAINLESS STEEL FASTENERS WHERE IN CONTACT WITH PRESSURE TREATED WOOD.
4. CONTRACTOR SHALL PERFORM ALL WORK IN COMPLIANCE WITH THE AHJ. COSTS FOR PERMITS SHALL BE INCLUDED IN WORK. PROVIDE INSPECTION DOCUMENTS TO THE OWNER.

ROOFING NOTES

1. EXISTING ROOFING COMPONENTS:
 - BUILT-UP ROOFING
 - VAPOR BARRIER
 - CWFD
2. A. EXISTING VAPOR BARRIER AND B.U. ROOFING SHALL REMAIN
 B. PROVIDE FULLY ADHERED 60 MIL TPO MEMBRANE ROOFING SYSTEM, AND 3/4" PLYWOOD. ATTACH 3/4" PLYWOOD TO 2x4's THROUGH INTO EXISTING CWFD AND STEEL FRAMING.


METAL SOFFIT NOTES

1. PROVIDE PREFINISHED ALUMINUM SOFFIT BELOW WALKWAY ROOF STRUCTURE AND FASCIA CLADDING
2. ATTACH TO EXISTING STEEL STRUCTURE. PROVIDE PRESSURE TREATED WOOD BLOCKING AND NAILERS

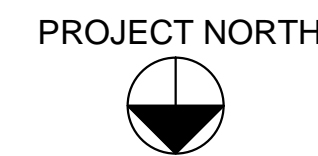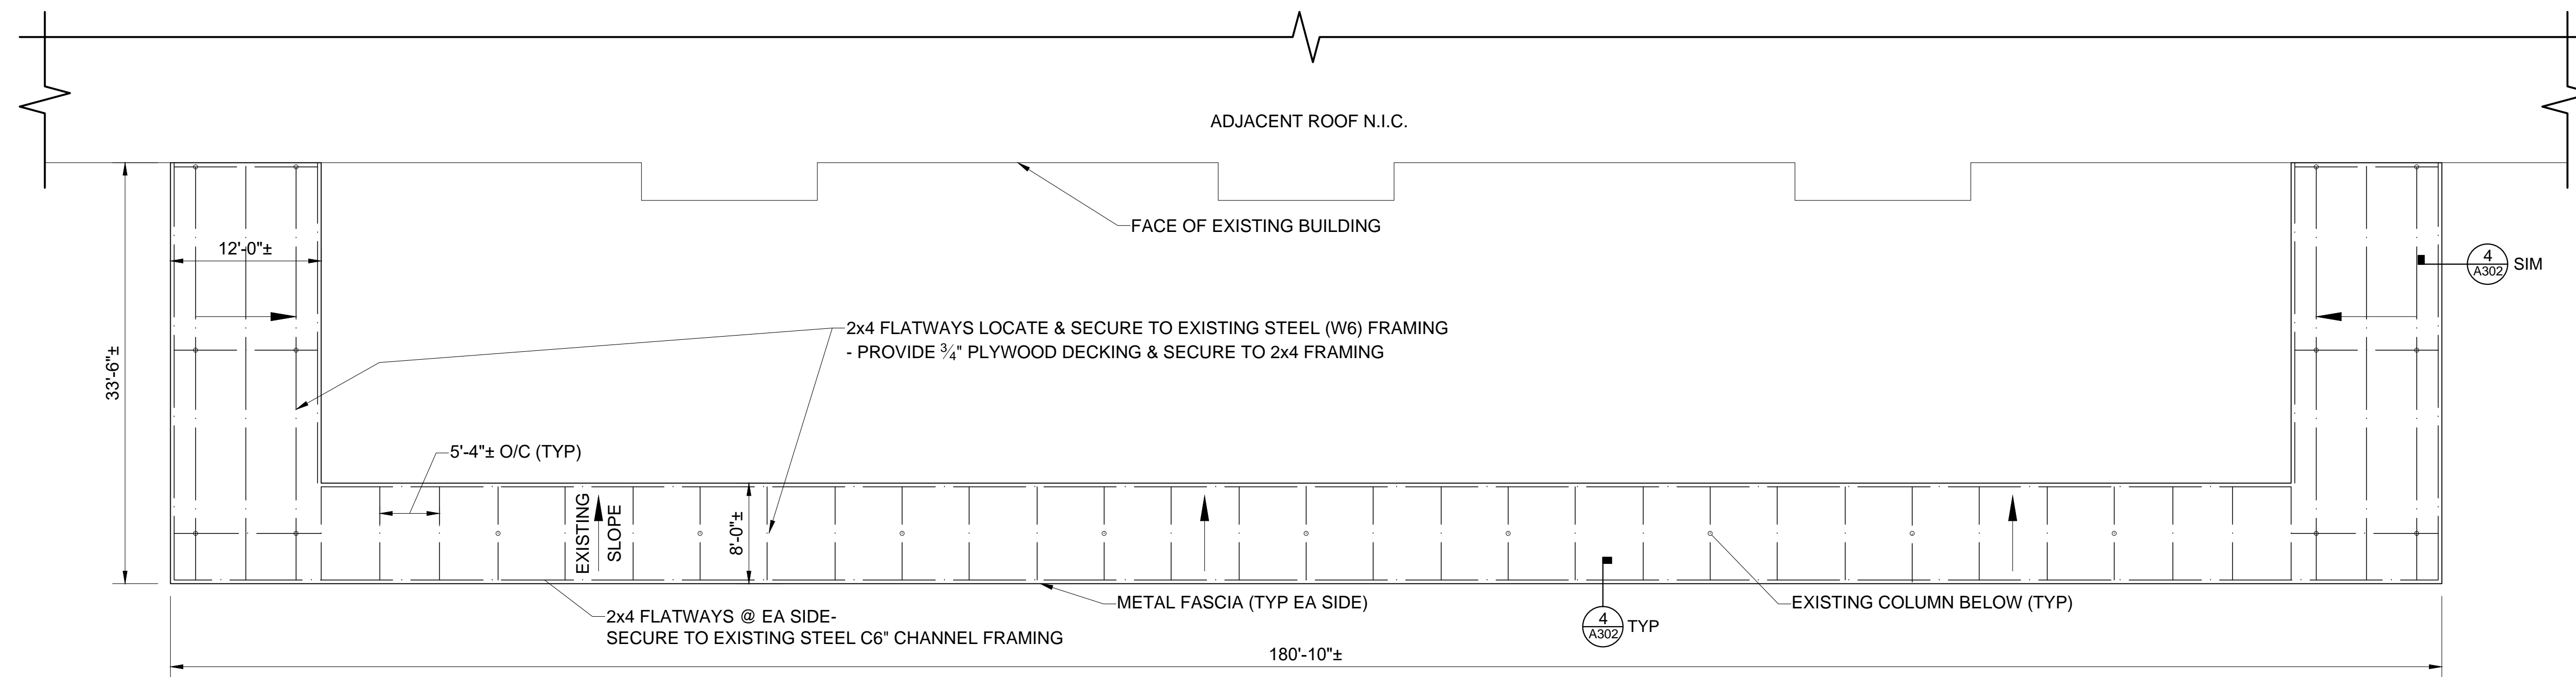

FLAT ROCK MIDDLE WALKWAY ROOF PLAN
SCALE: 1/8" = 1'-0"

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HCPS ROOF REPLACEMENTS AT WHHS, NHHS, HMS & FRMS

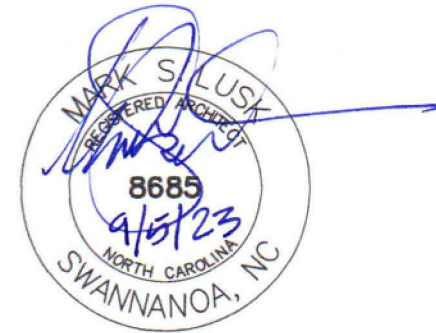Project Number: 23002
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 Drawn: A. Rognas
 Date: 9/5/23
 Revisions: _____

FLAT ROCK MIDDLE WALKWAY ROOF PLAN


A206

GENERAL NOTES

- EXISTING WOOD NAILER SHALL REMAIN UNLESS DETERMINED TO BE DAMAGED BY OWNER. REMOVAL AND REPLACEMENT SHALL BE PERFORMED AT UNIT PRICE.
- VERIFY DIMENSIONS, QUANTITIES, SIZES, AND OTHER EXISTING CONDITIONS PRIOR TO DEMOLITION WORK. DISCREPANCIES BETWEEN DOCUMENTS AND EXISTING CONDITIONS SHALL BE REPORTED TO THE ARCHITECT.
- CRICKETS SHALL SLOPE AT 1/2" PER FOOT.
- SITE ACCESS, STAGING AND SCHEDULE TO BE COORDINATED WITH PRINCIPAL.
- PROVIDE 18-8 OR 304 STAINLESS STEEL FASTENERS WHERE IN CONTACT WITH PRESSURE TREATED WOOD.
- CONTRACTOR SHALL PERFORM ALL WORK IN COMPLIANCE WITH THE AHJ. COSTS FOR PERMITS SHALL BE INCLUDED IN WORK. PROVIDE INSPECTION DOCUMENTS TO THE OWNER.

ROOFING NOTES

- EXISTING ROOFING COMPONENTS:
 - FULLY ADHERED SPM (PVC) MEMBRANE
 - FULLY ADHERED SPM (PVC) MEMBRANE (SECOND LAYER)
 - 1 1/2" POLYISO INSULATION
 - METAL ROOF DECK
- DEMOLITION: REMOVE EXISTING SPM (2 LAYERS). REMOVE EXISTING ROOFING SYSTEM COMPONENTS INCLUDING TERMINATION BARS & FLASHING. EXISTING 1 1/2" POLYISO INSULATION SHALL REMAIN.
- PROVIDE FULLY ADHERED 60 MIL TPO MEMBRANE ROOFING SYSTEM, AND 1/4" COVER BOARD OVER EXISTING 1 1/2" POLYISO INSULATION. ATTACH 1/4" COVER BOARD THROUGH INTO EXISTING METAL ROOF DECK.

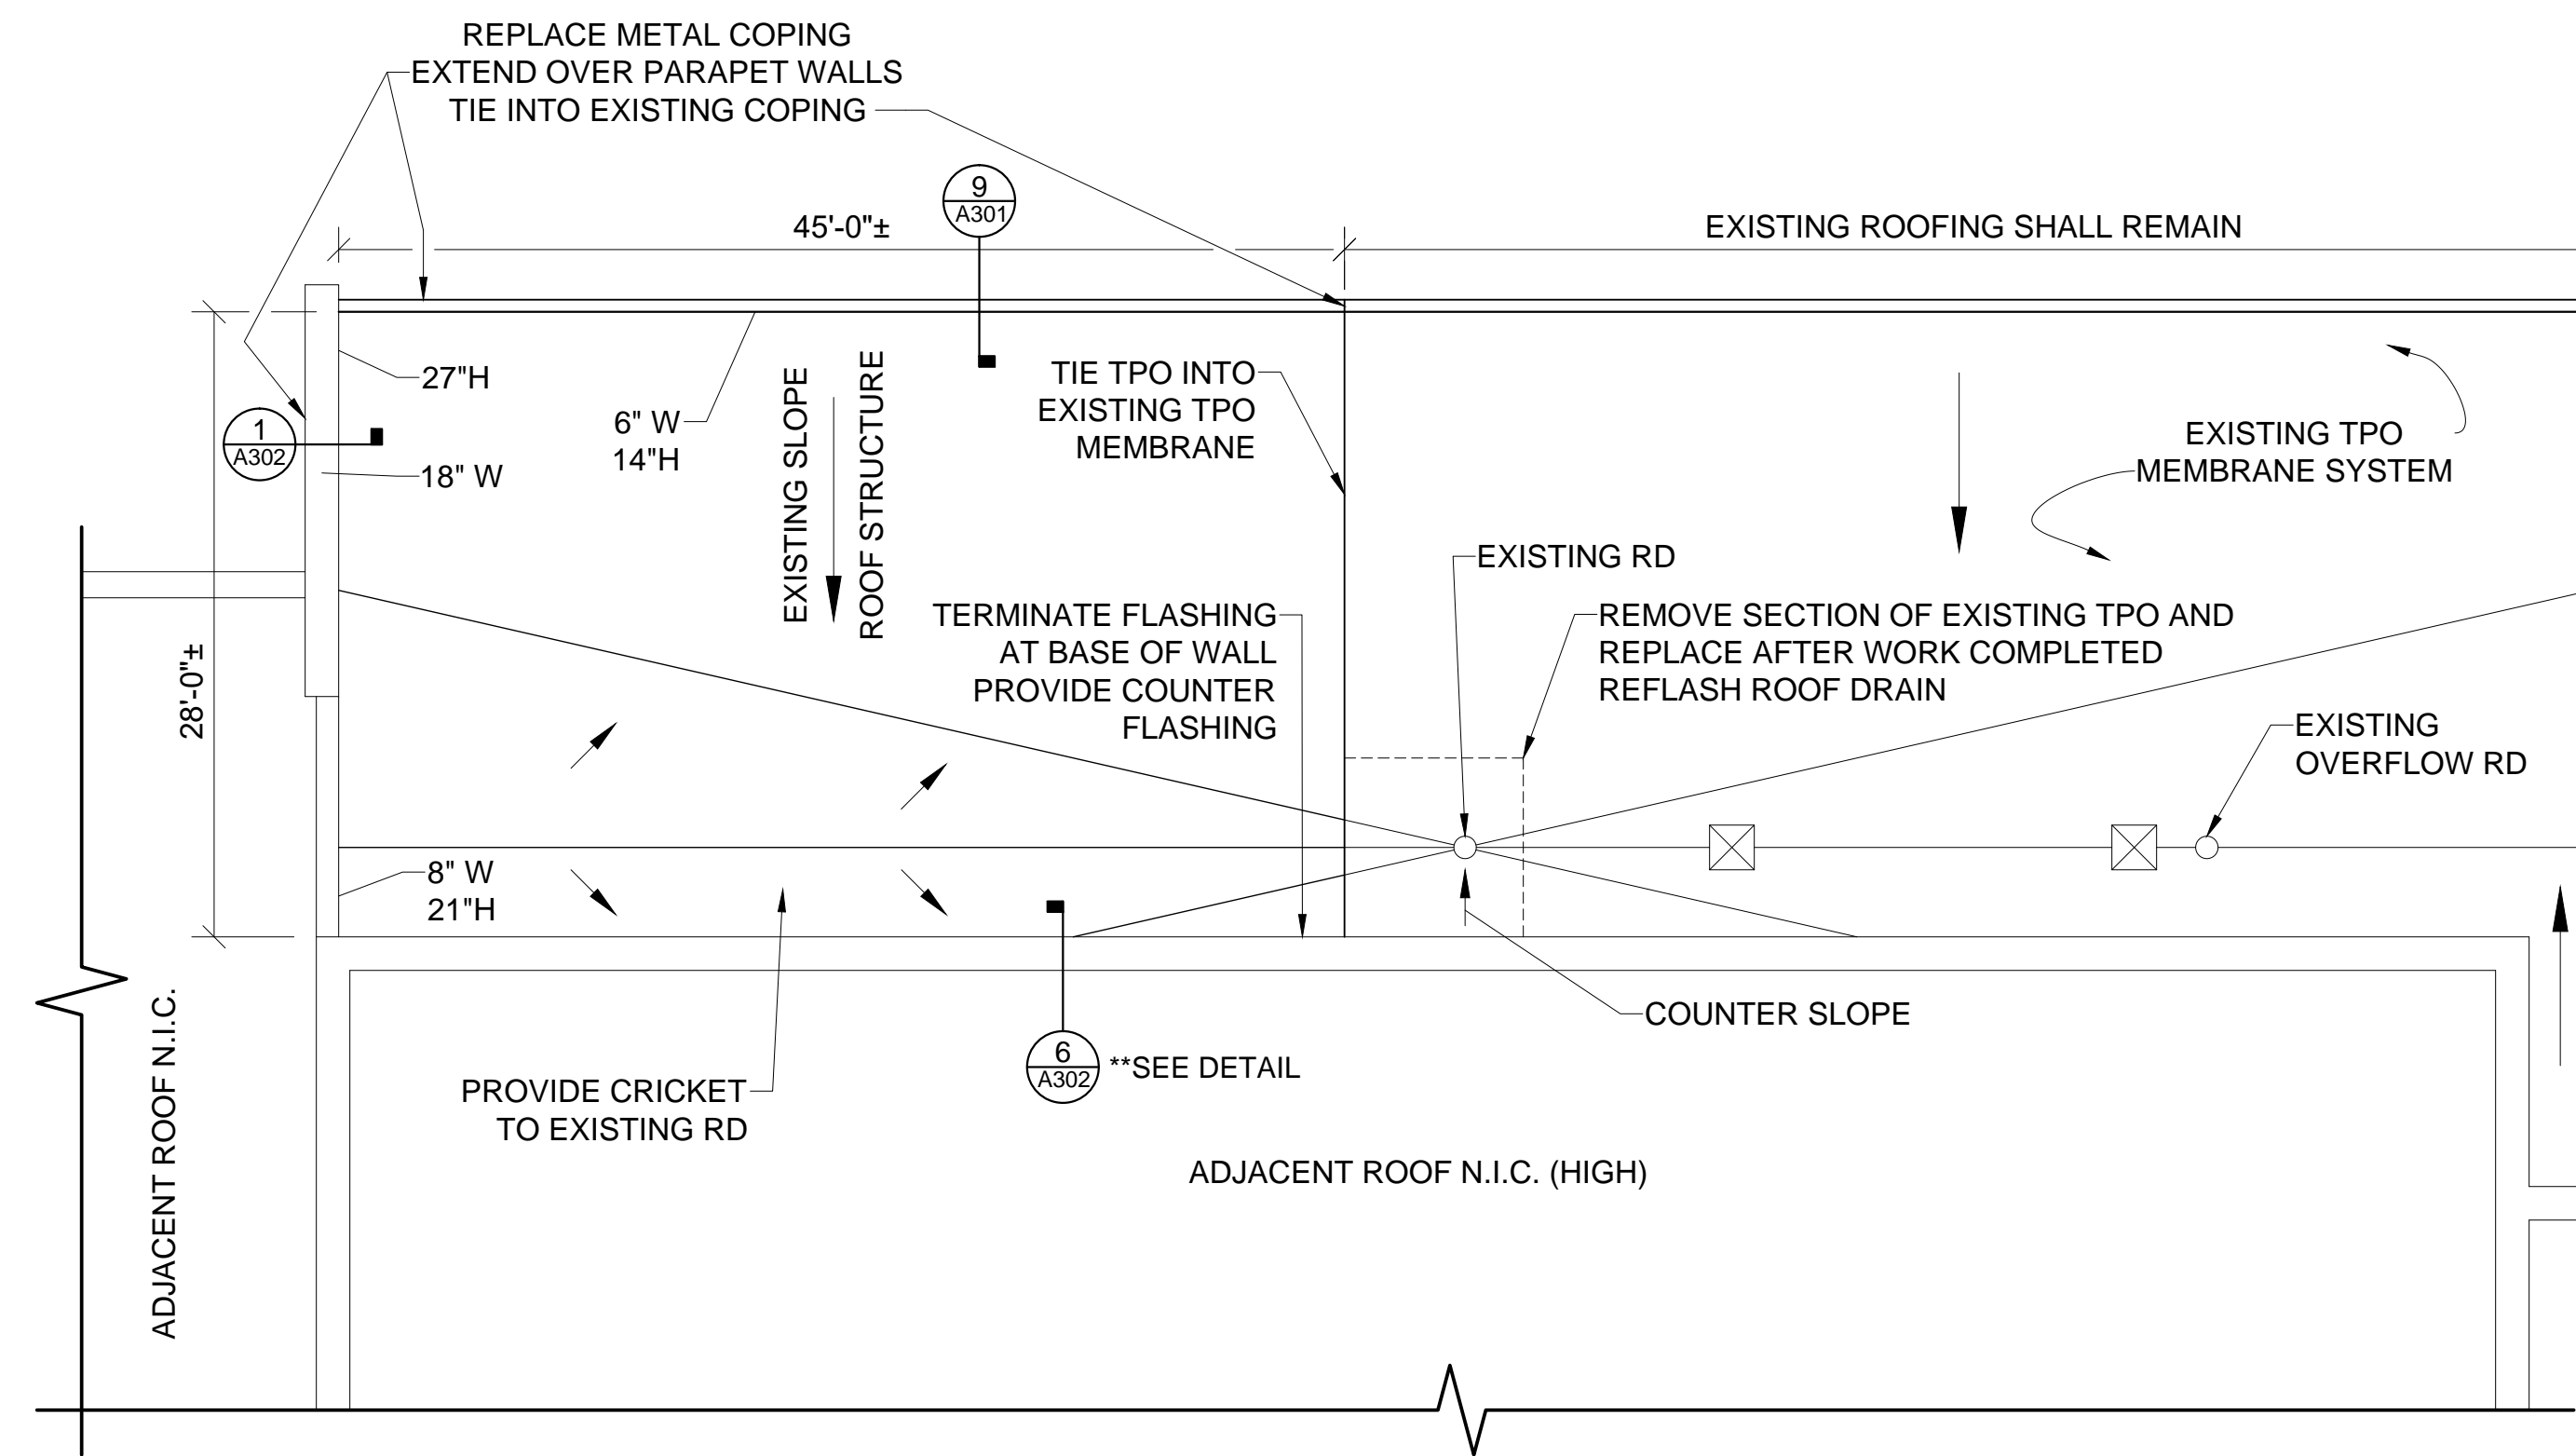

NORTH HENDERSON HIGH WEIGHT RM ROOF PLAN
SCALE: 1/4" = 1'-0"

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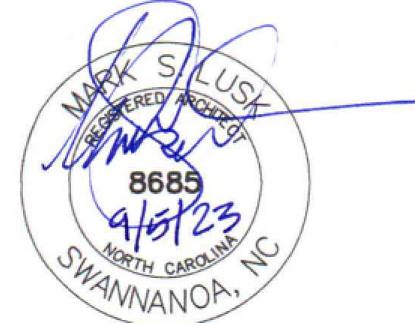


HCPS ROOF REPLACEMENTS AT WHHS, NHHS, HMS & FRMS

Project Number: 23002
Checked: _____
Drawn: A. Rognas
Date: 9/5/23
Revisions: _____

NORTH HENDERSON HIGH WEIGHT RM ROOF PLAN

A207




HCPS ROOF REPLACEMENTS AT WHHS, NHHS, HMS & FRMS

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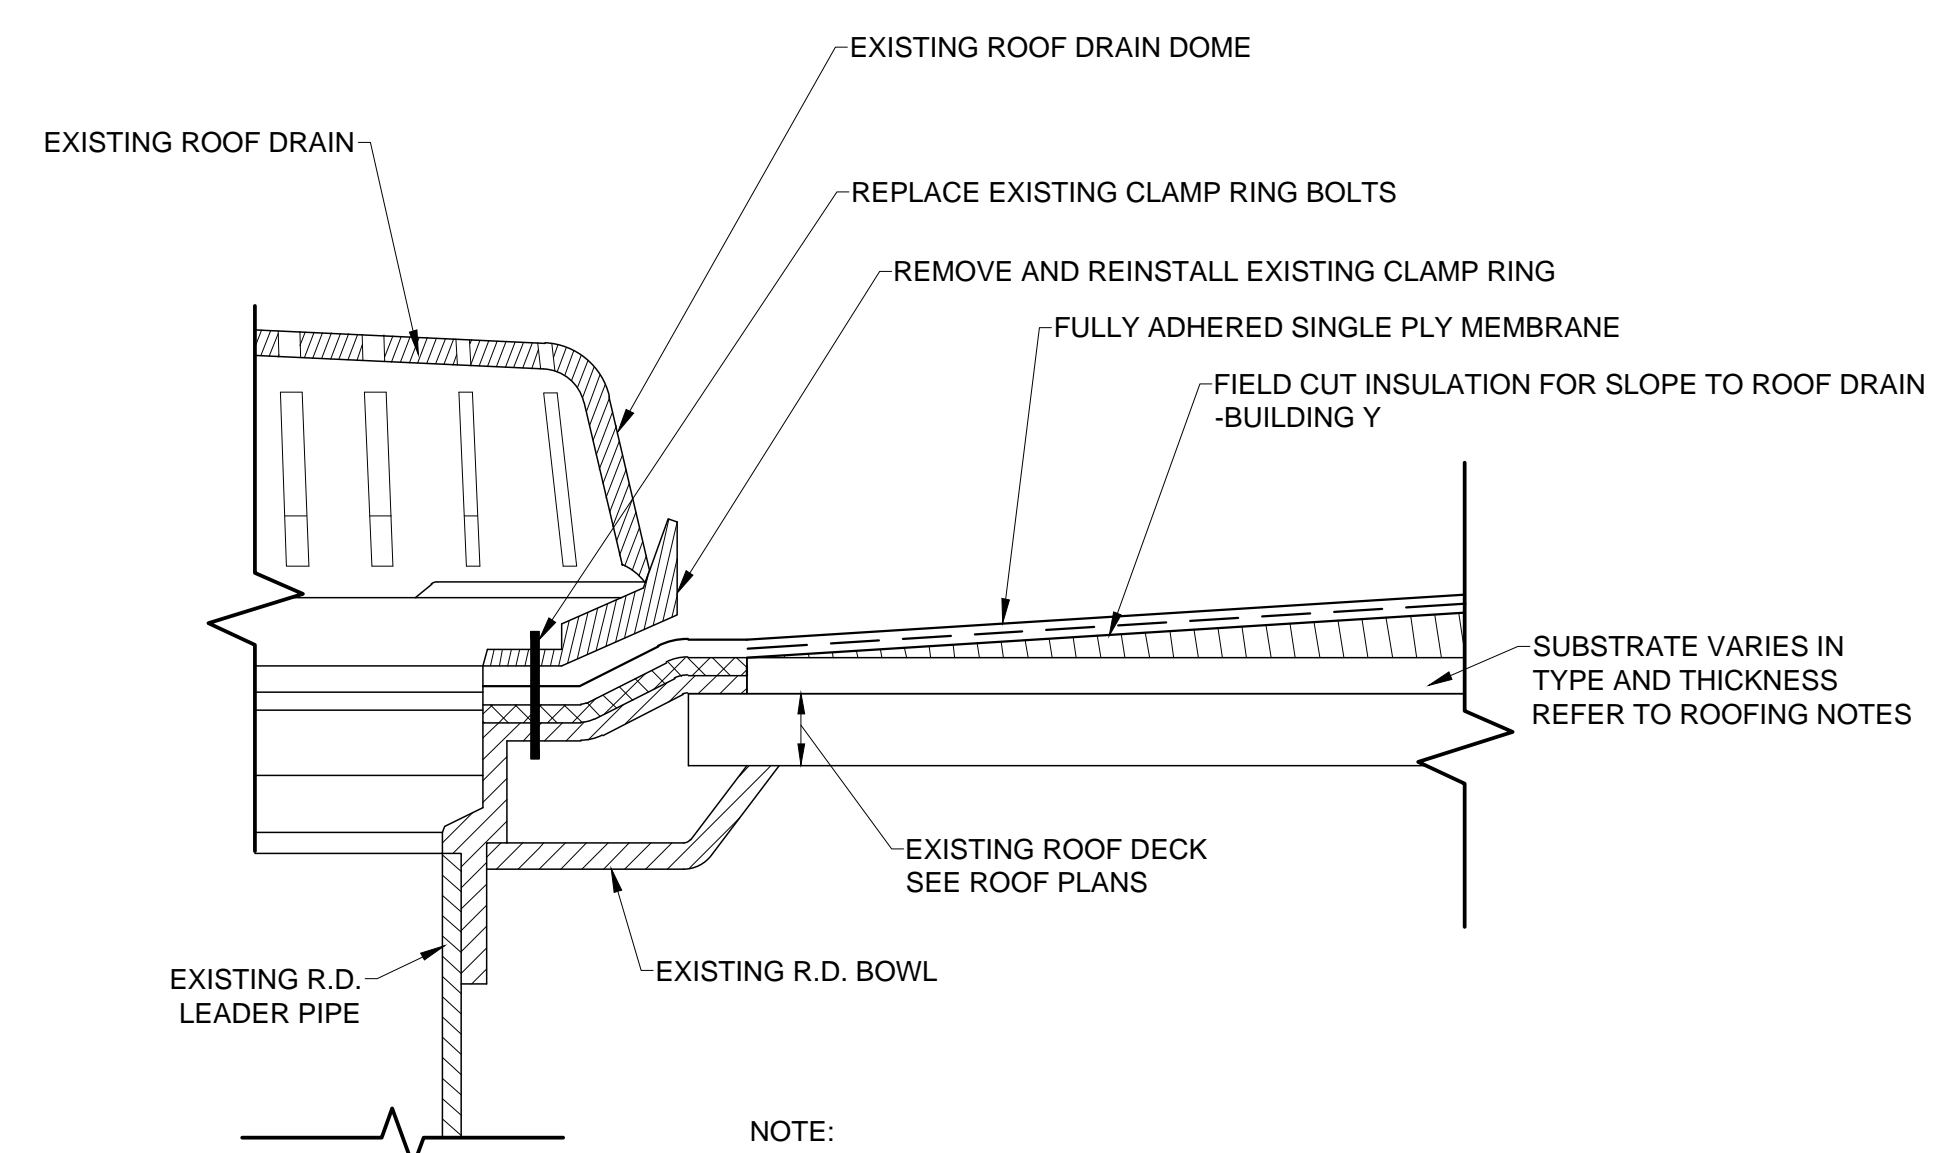
DETAILS

A301

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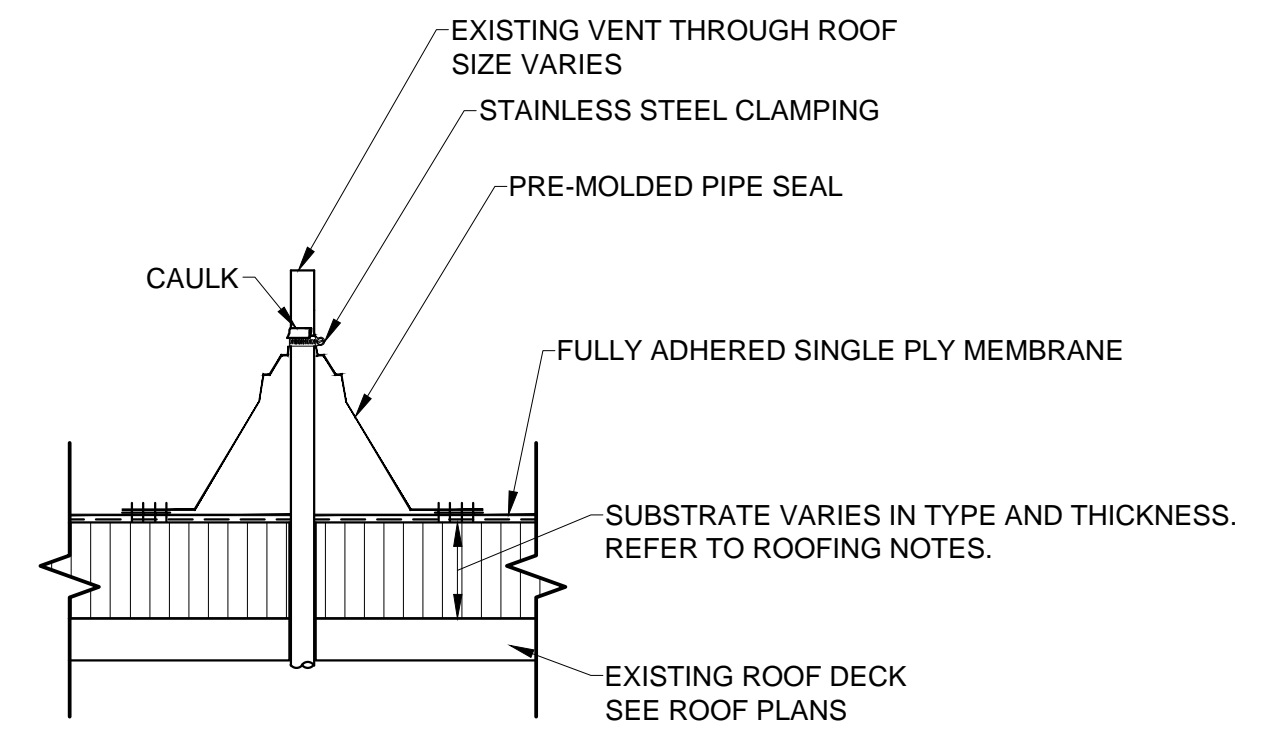


1 BASE OF WALL DETAIL
 SCALE: 1/2" = 1'-0"

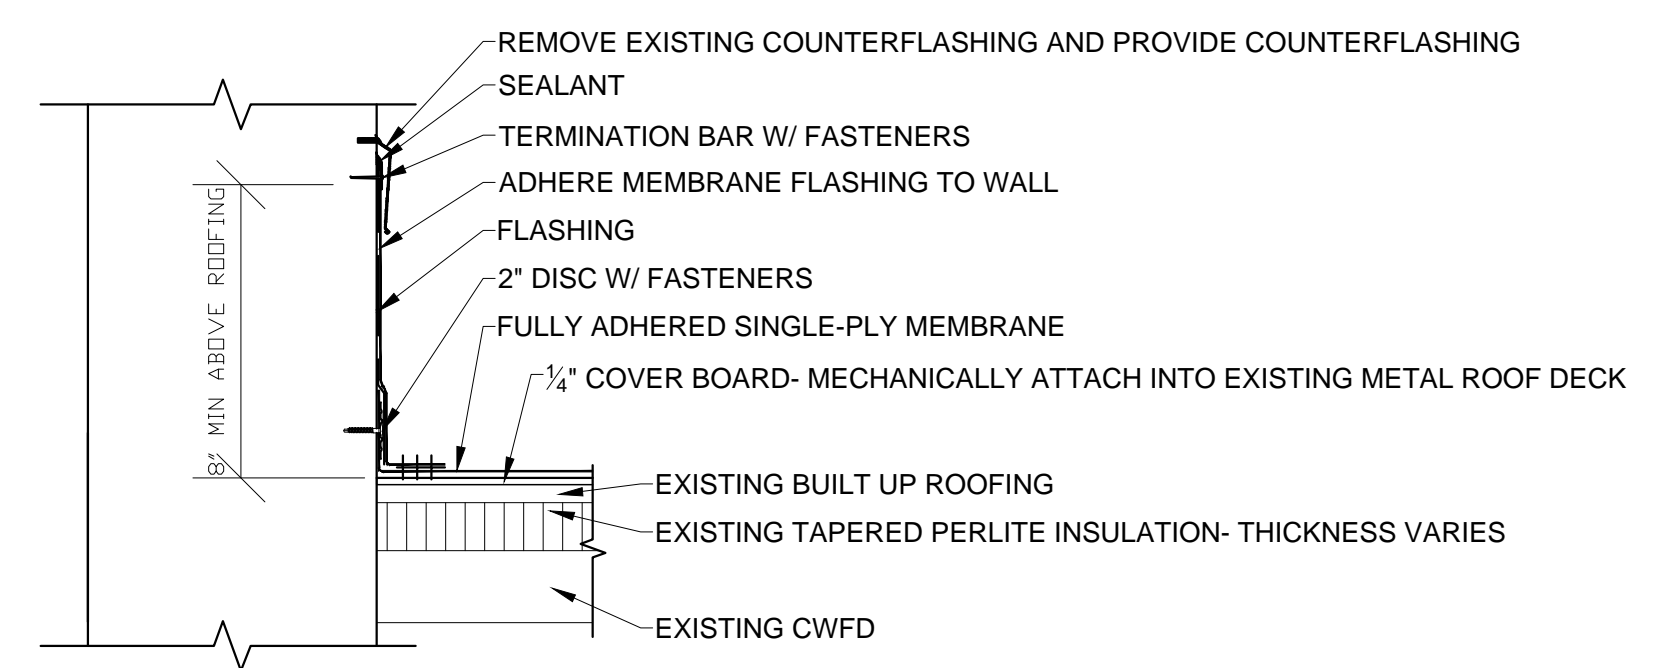

2 ROOF DRAIN DETAIL
 SCALE: 1/2" = 1'-0"


NOTE: 1. SEE ROOFING NOTES ON ROOF PLANS




3 PLUMBING VENT DETAIL
 SCALE: 1/2" = 1'-0"

NOTE: RAISE VENT PIPE TO 8" ABOVE ROOFING


NOTE: SEE ROOFING NOTES ON ROOF PLANS

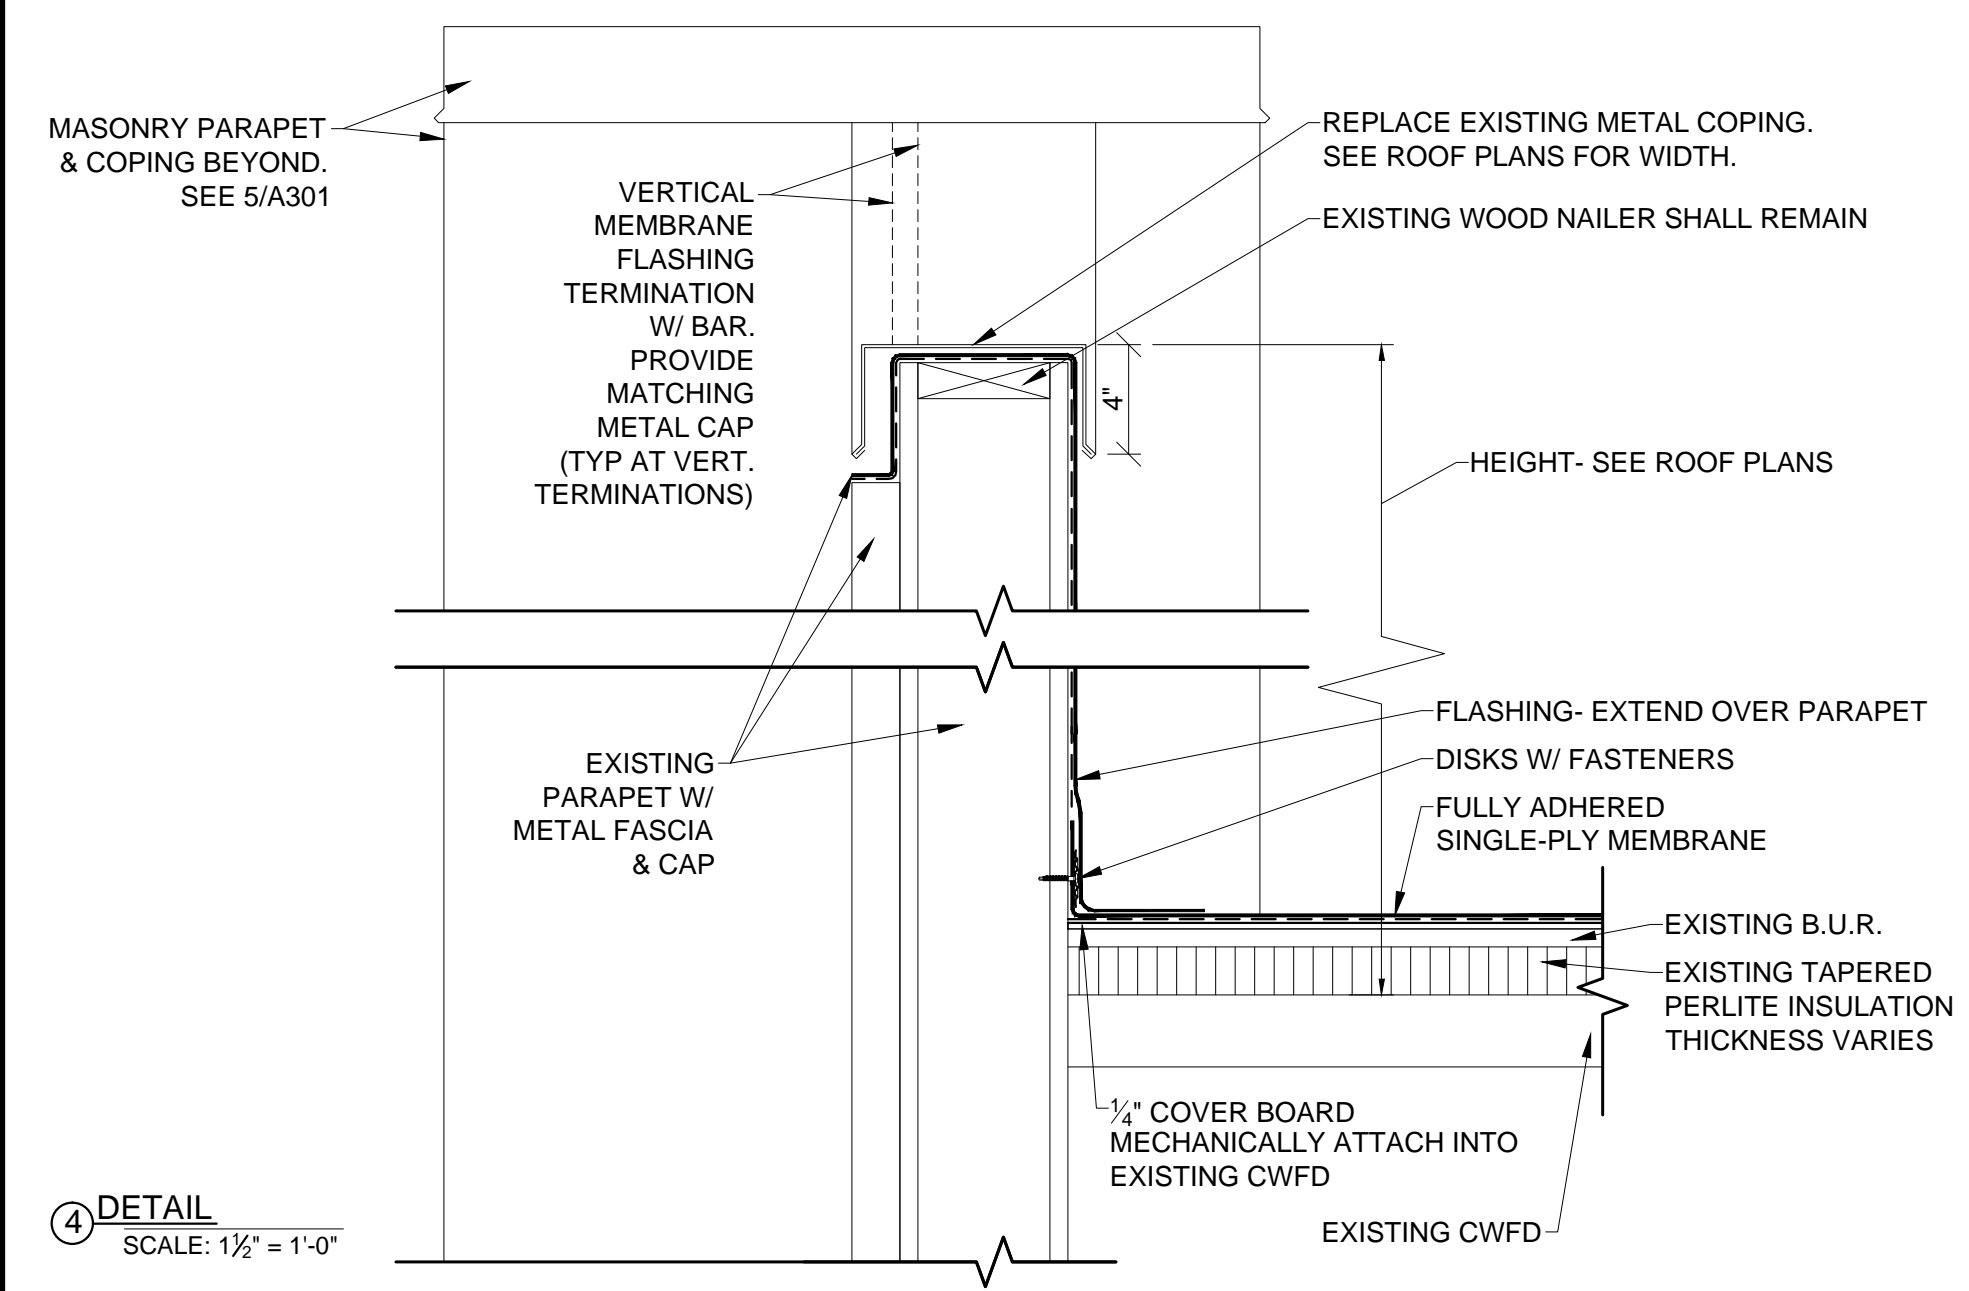


4 DETAIL
 SCALE: 1/2" = 1'-0"

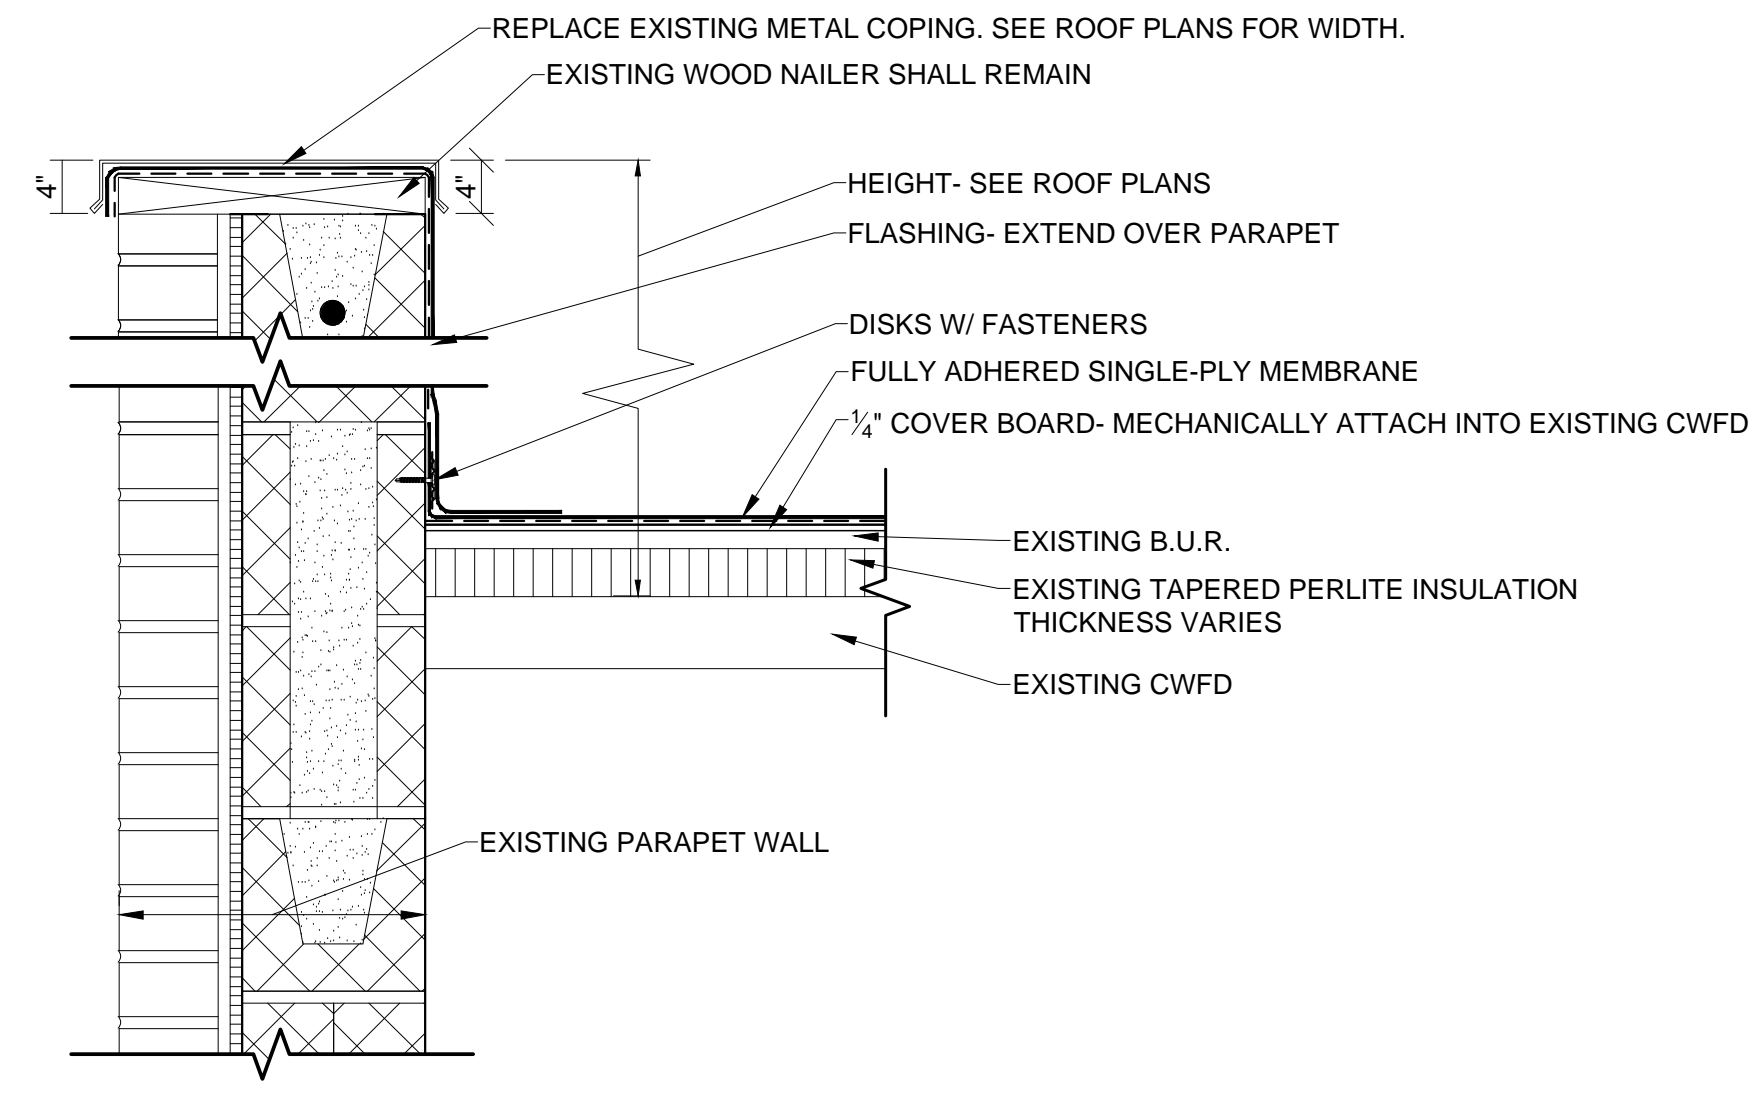

5 DETAIL
 SCALE: 1/2" = 1'-0"

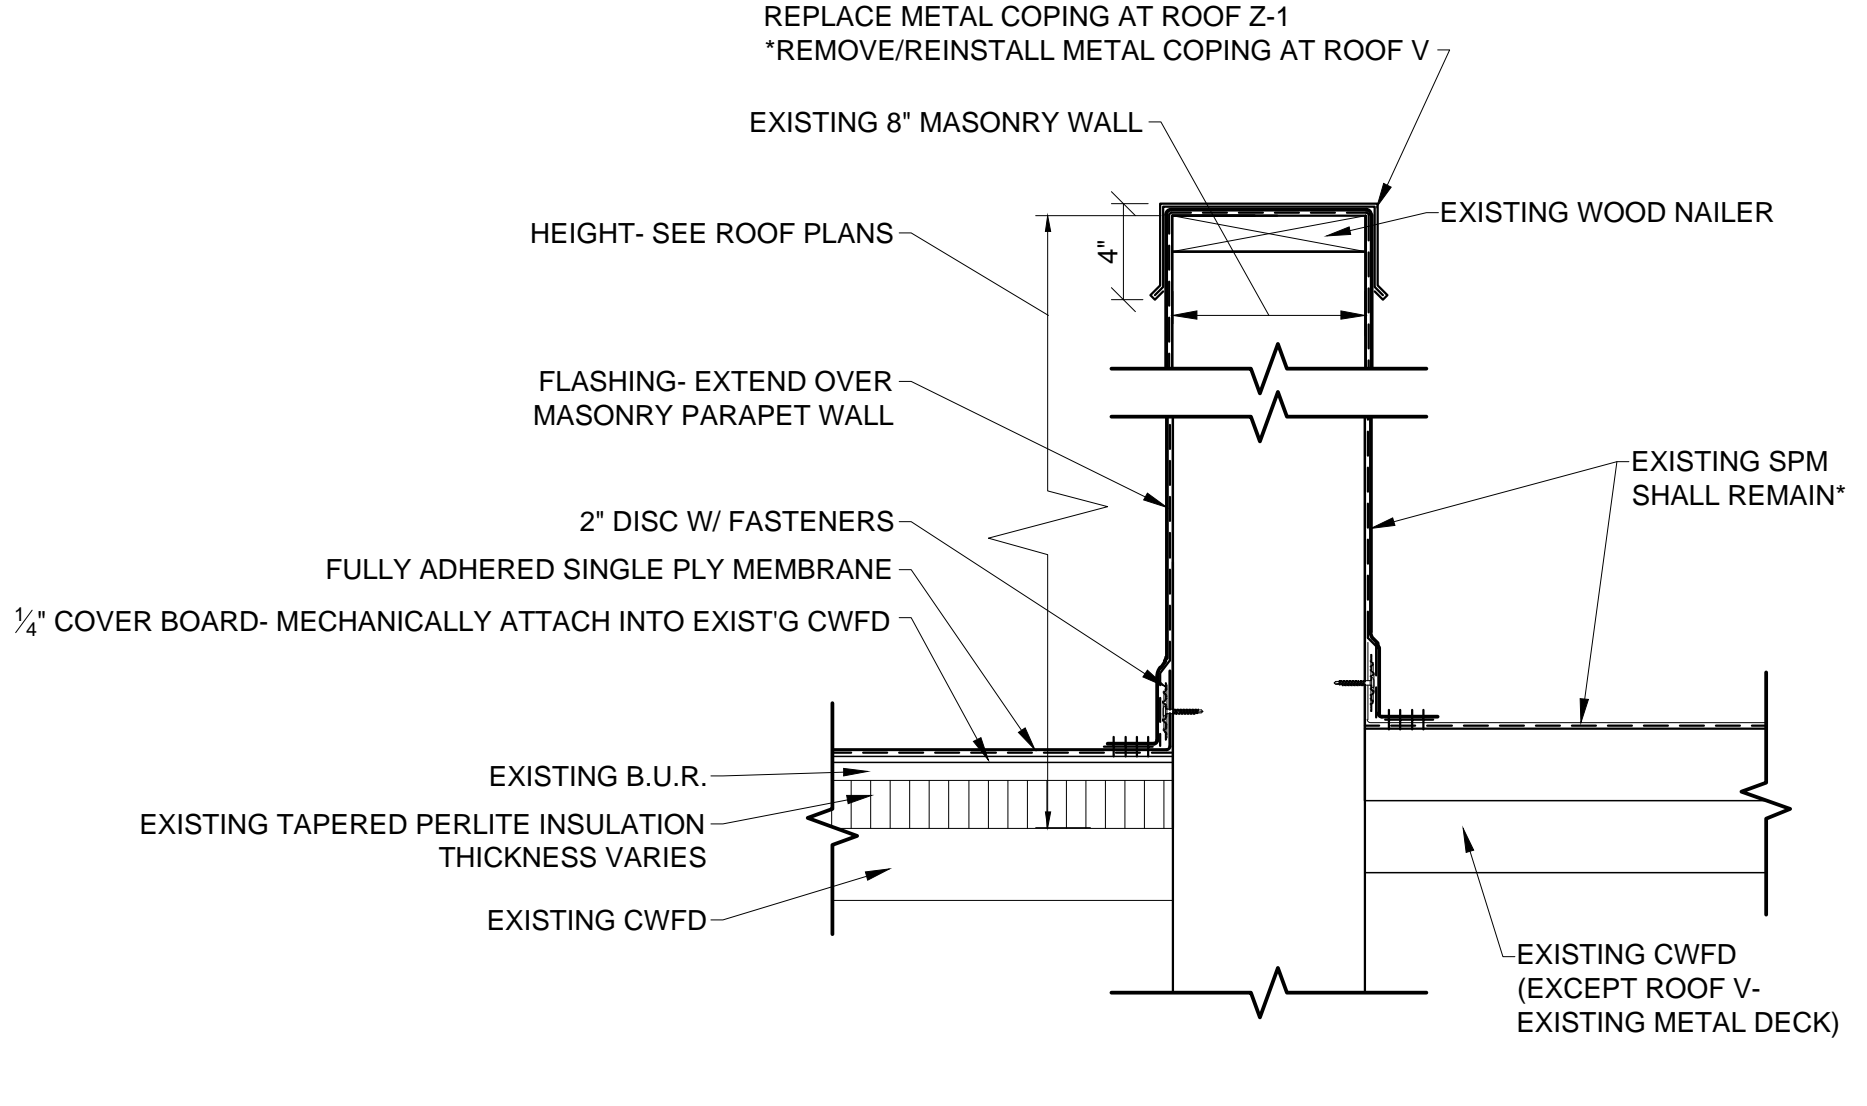


6 PARAPET WALL
 SCALE: 1/2" = 1'-0"

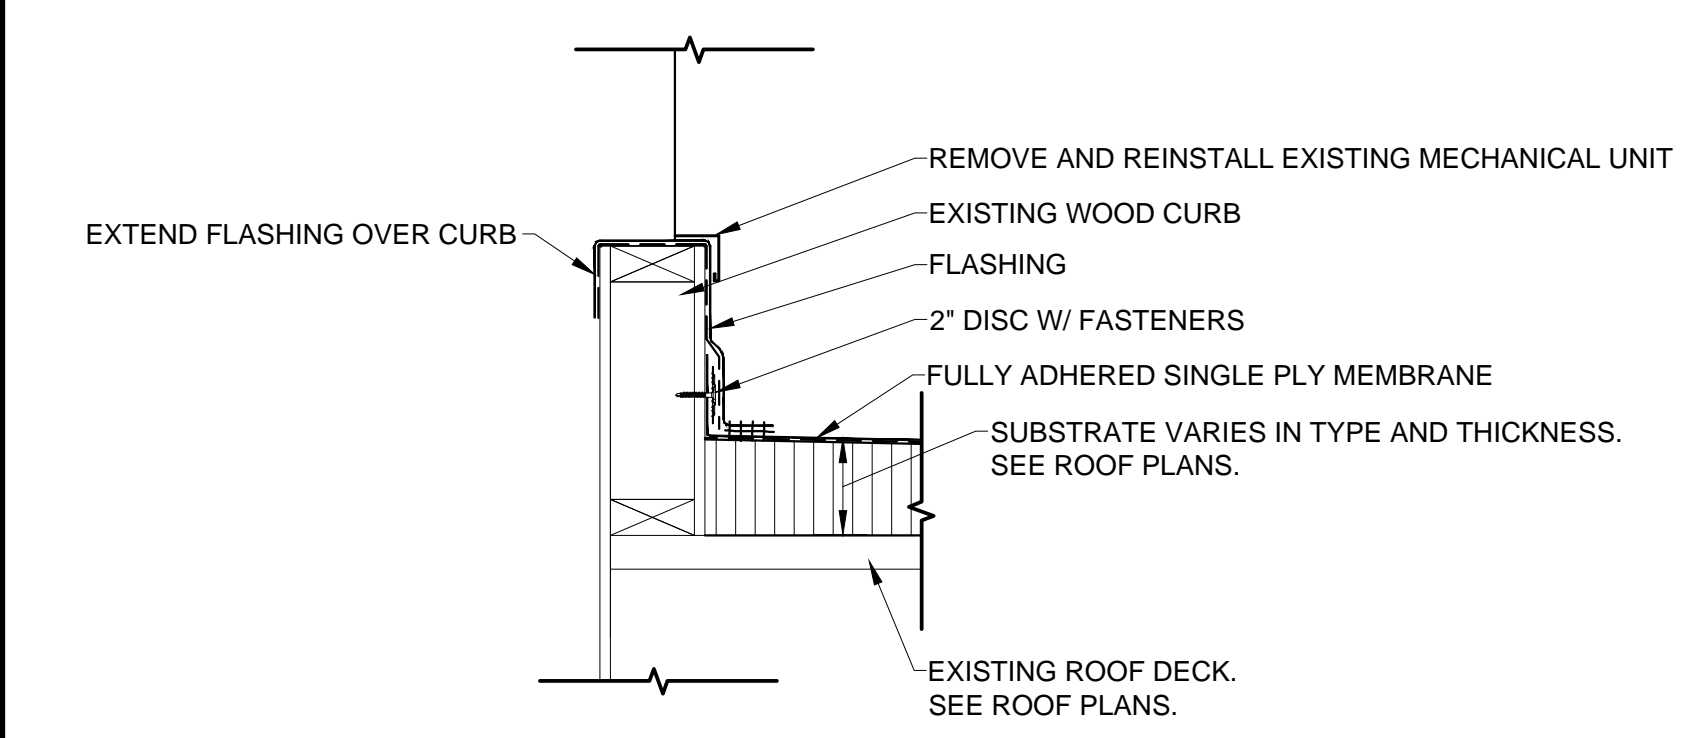


7 MECHANICAL CURB DETAIL
 SCALE: 1/2" = 1'-0"


NOTE: RAISE CURB TO 8" ABOVE ROOFING AT ANY LOCATION WHERE EXISTING CONDITION IS LESS THAN 8"
 NOTE: SEE ROOFING NOTES ON ROOF PLANS

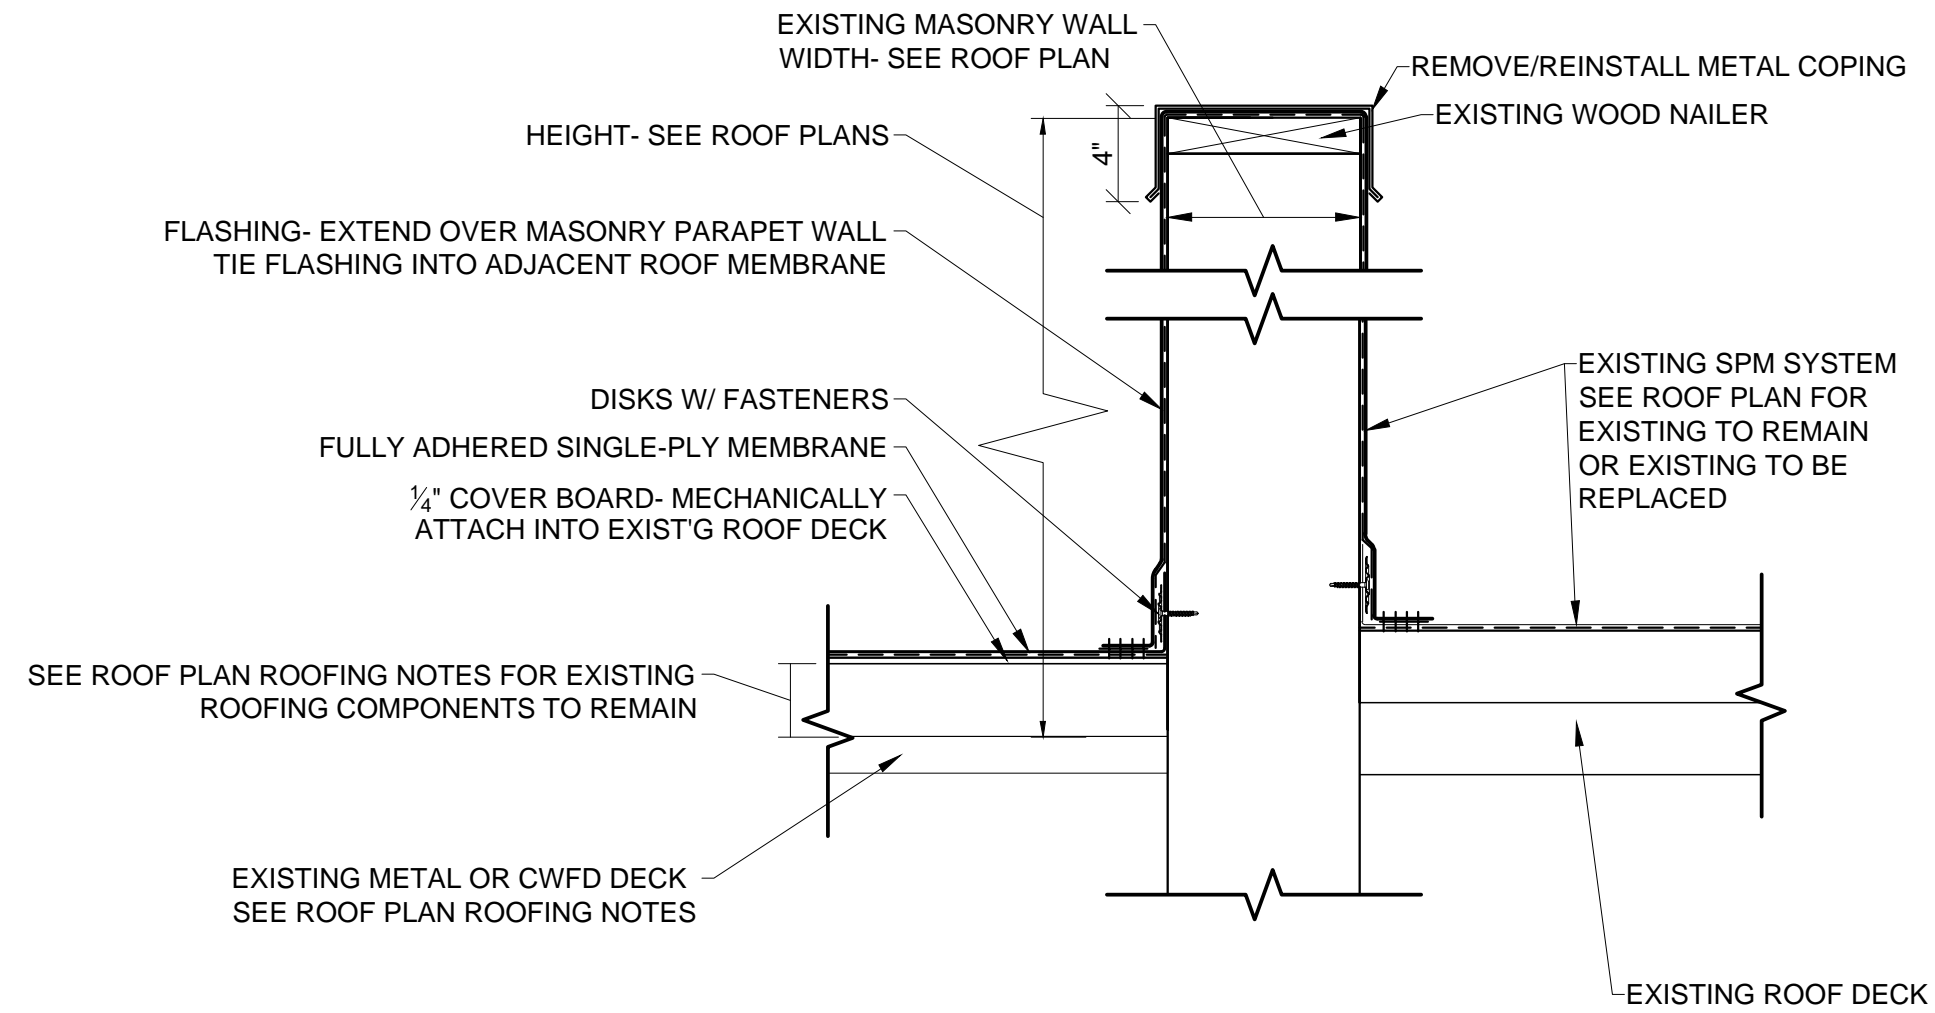


8 CURB WALL
 SCALE: 1/2" = 1'-0"

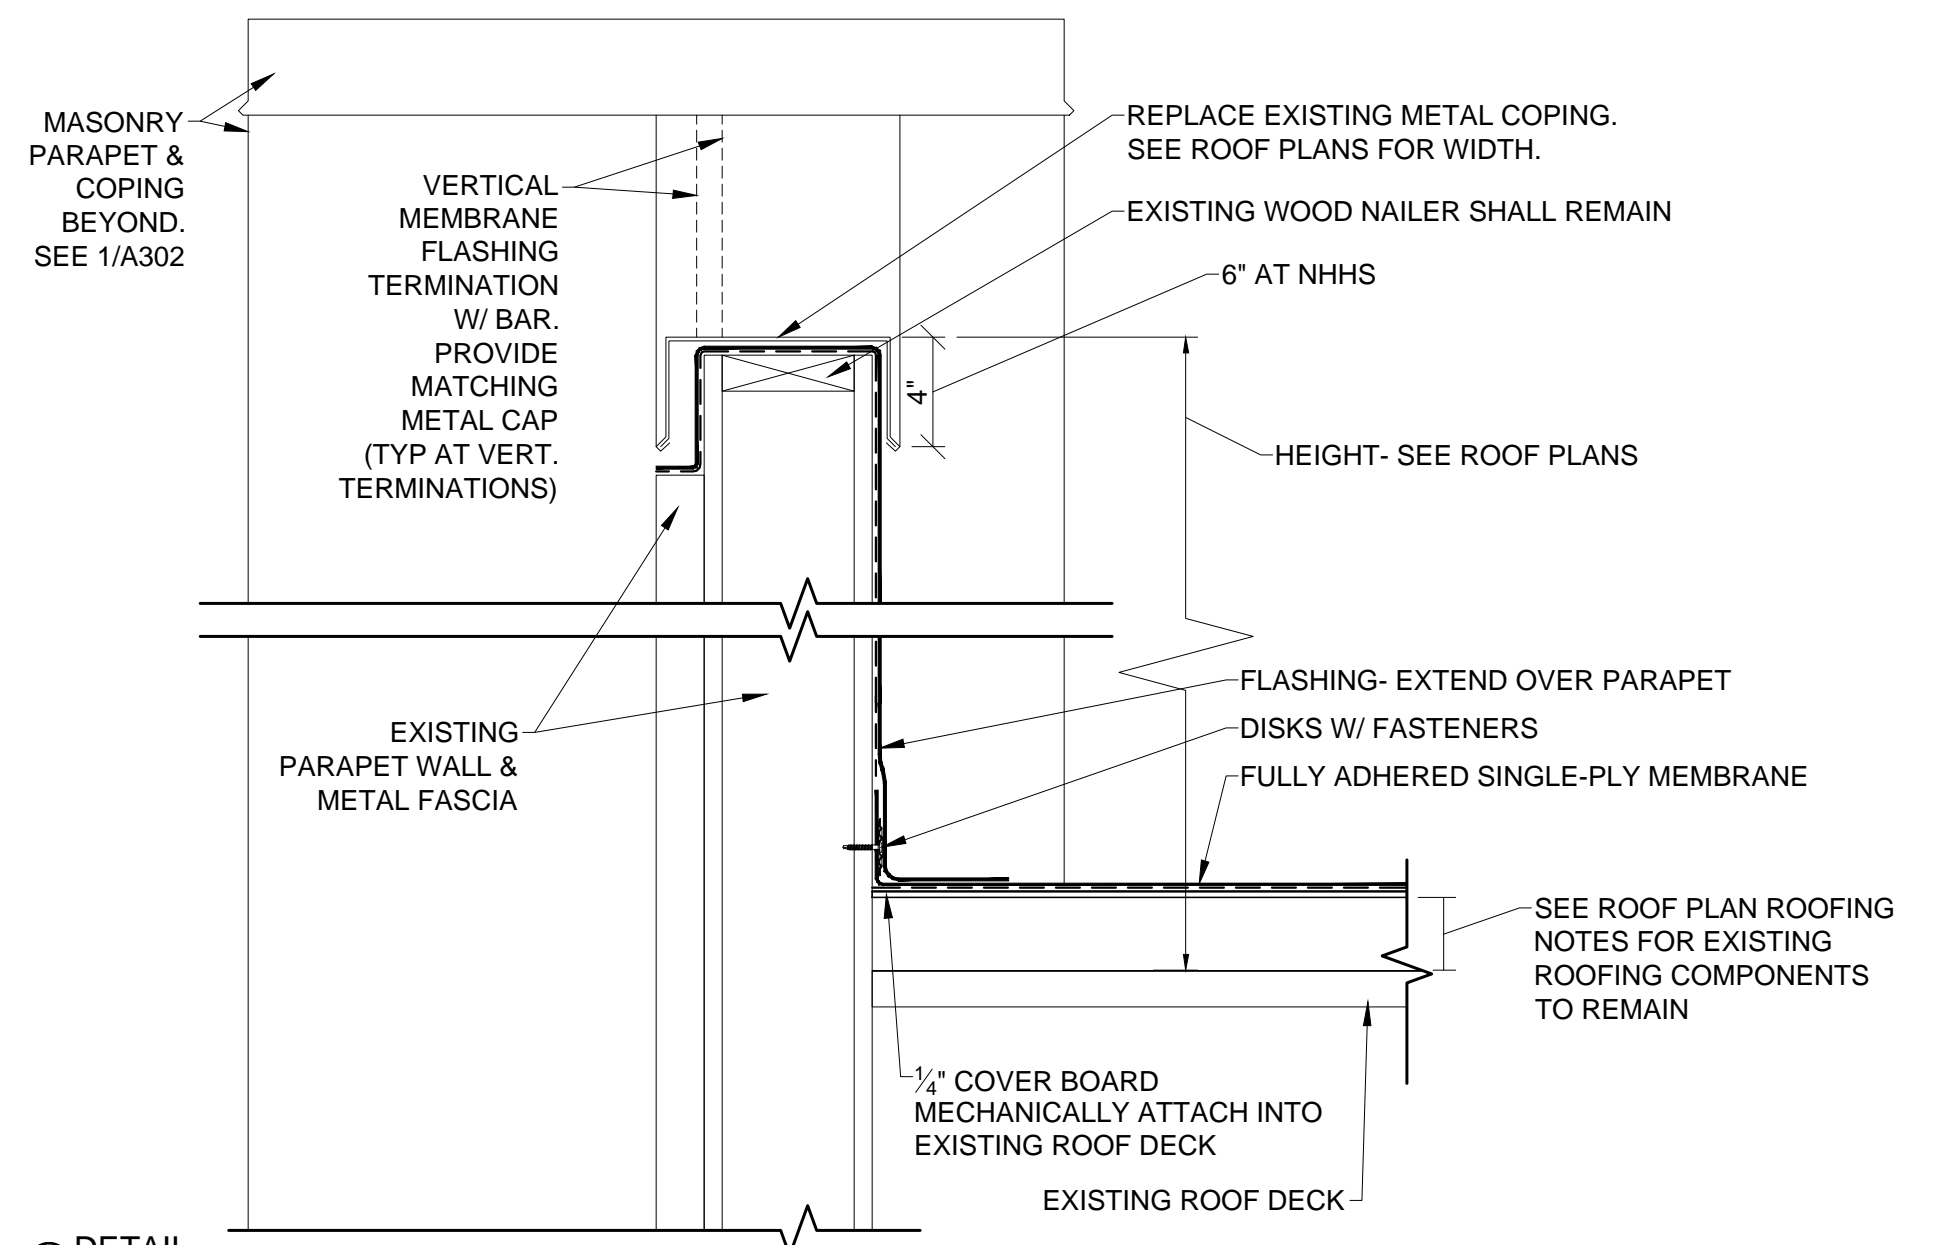


9 DETAIL
 SCALE: 1/2" = 1'-0"

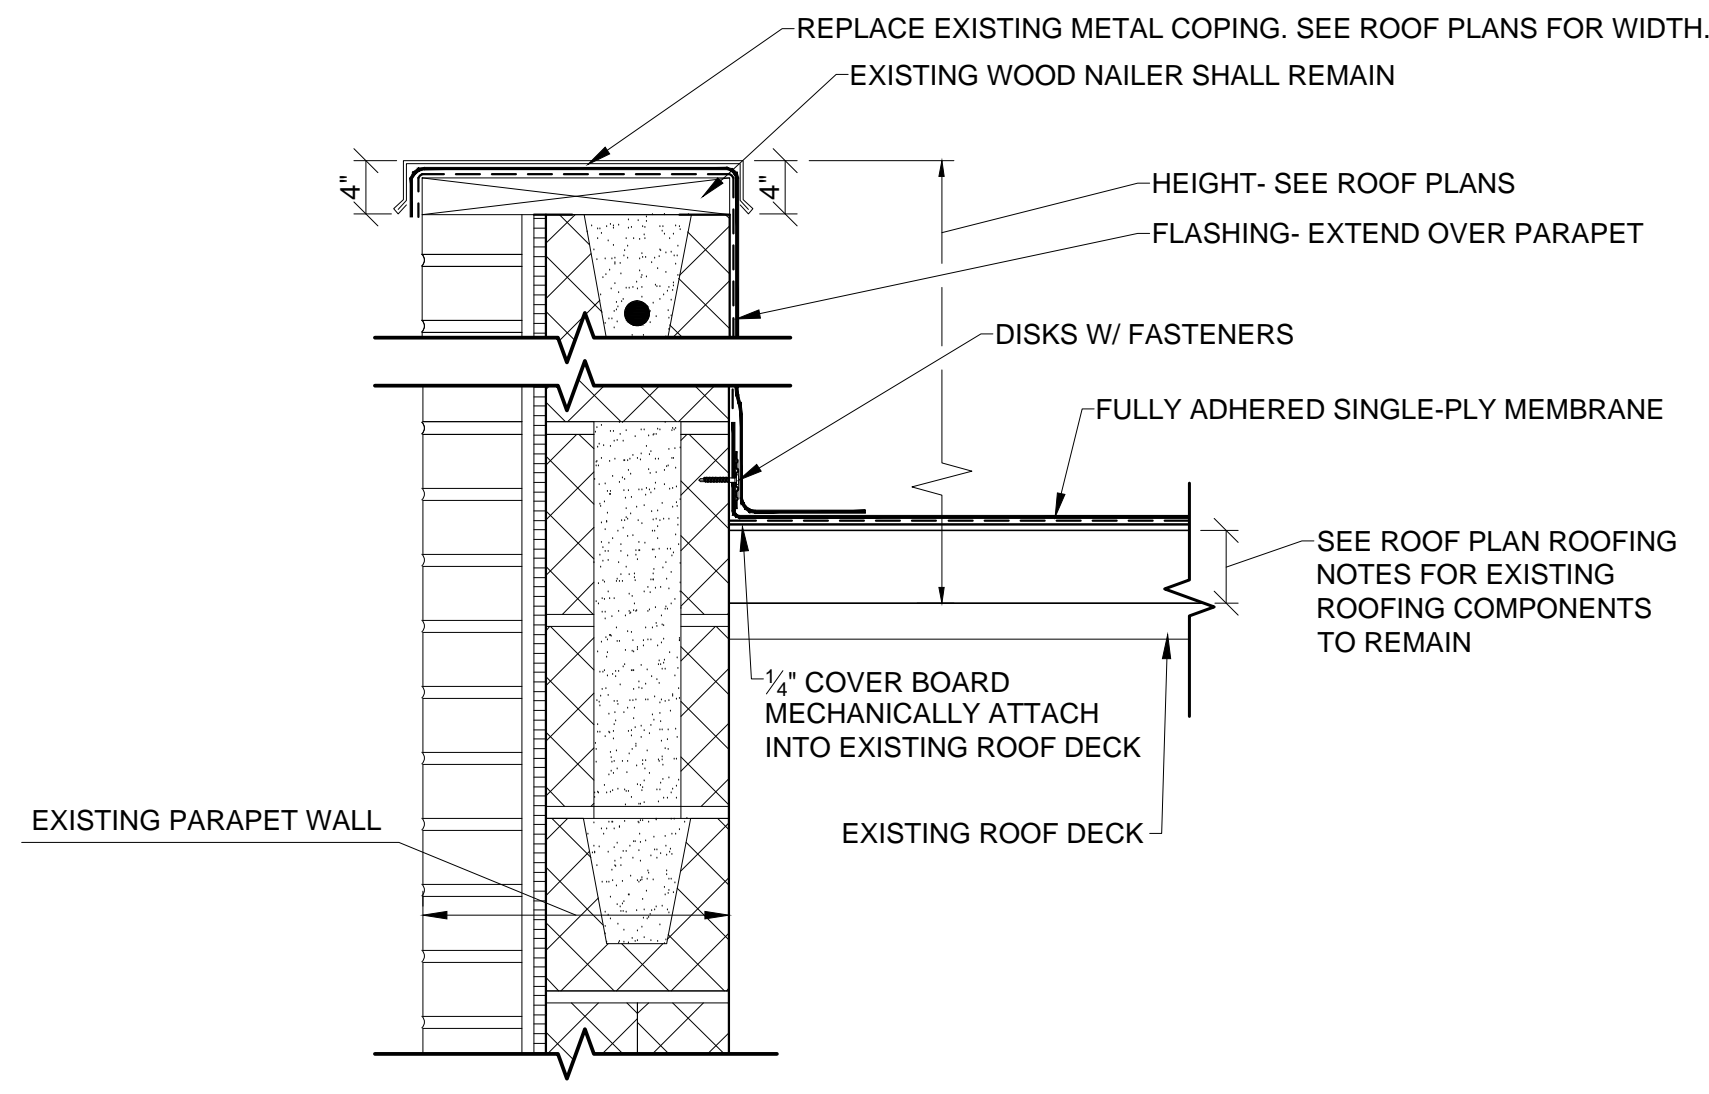


① **DETAIL**
 SCALE: 1/2" = 1'-0"

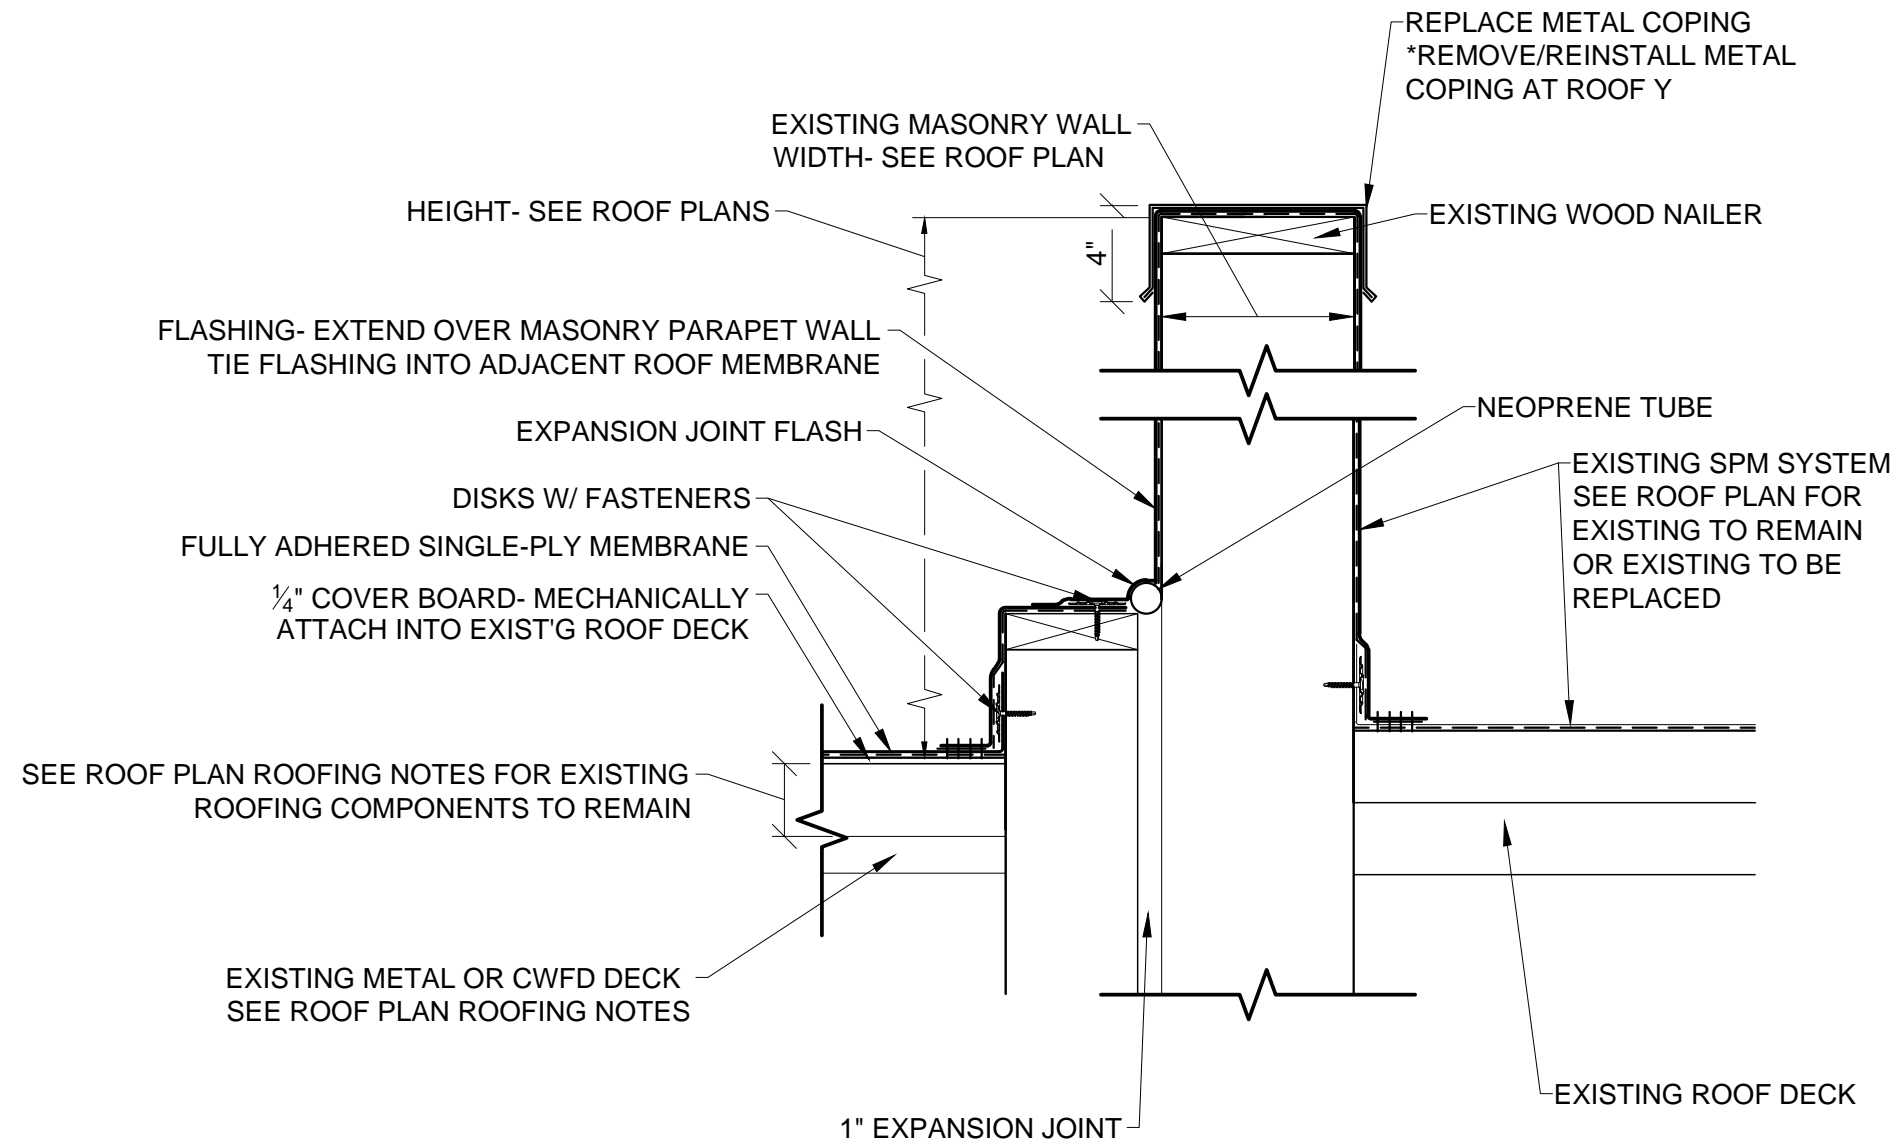

② **CURB WALL W/ EXPANSION JOINT**
 SCALE: 1/2" = 1'-0"

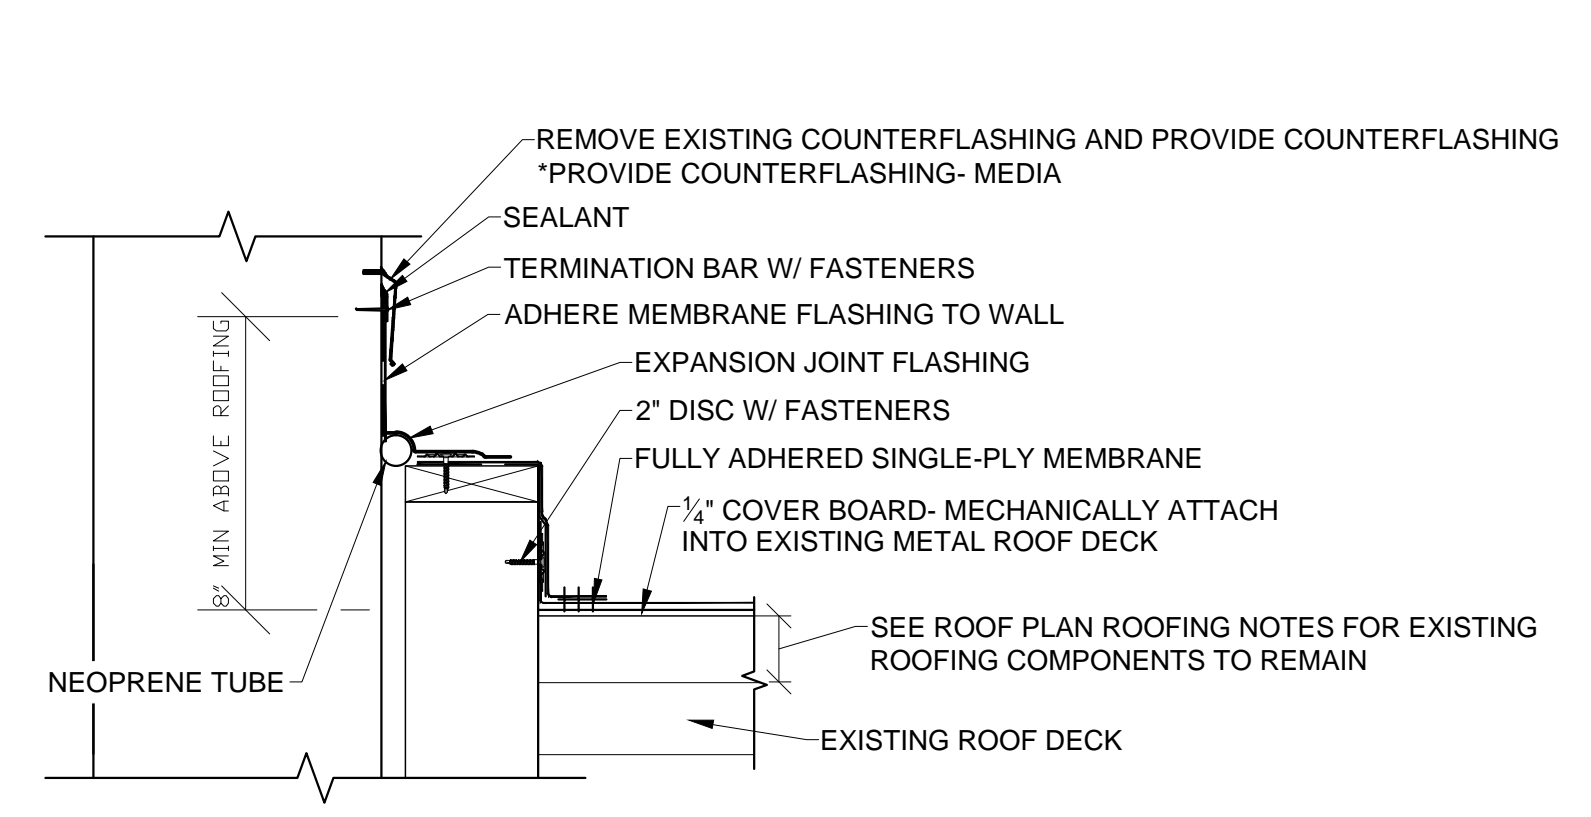


③ **BASE OF WALL DETAIL W/ EXPANSION JOINT**
 SCALE: 1/2" = 1'-0"

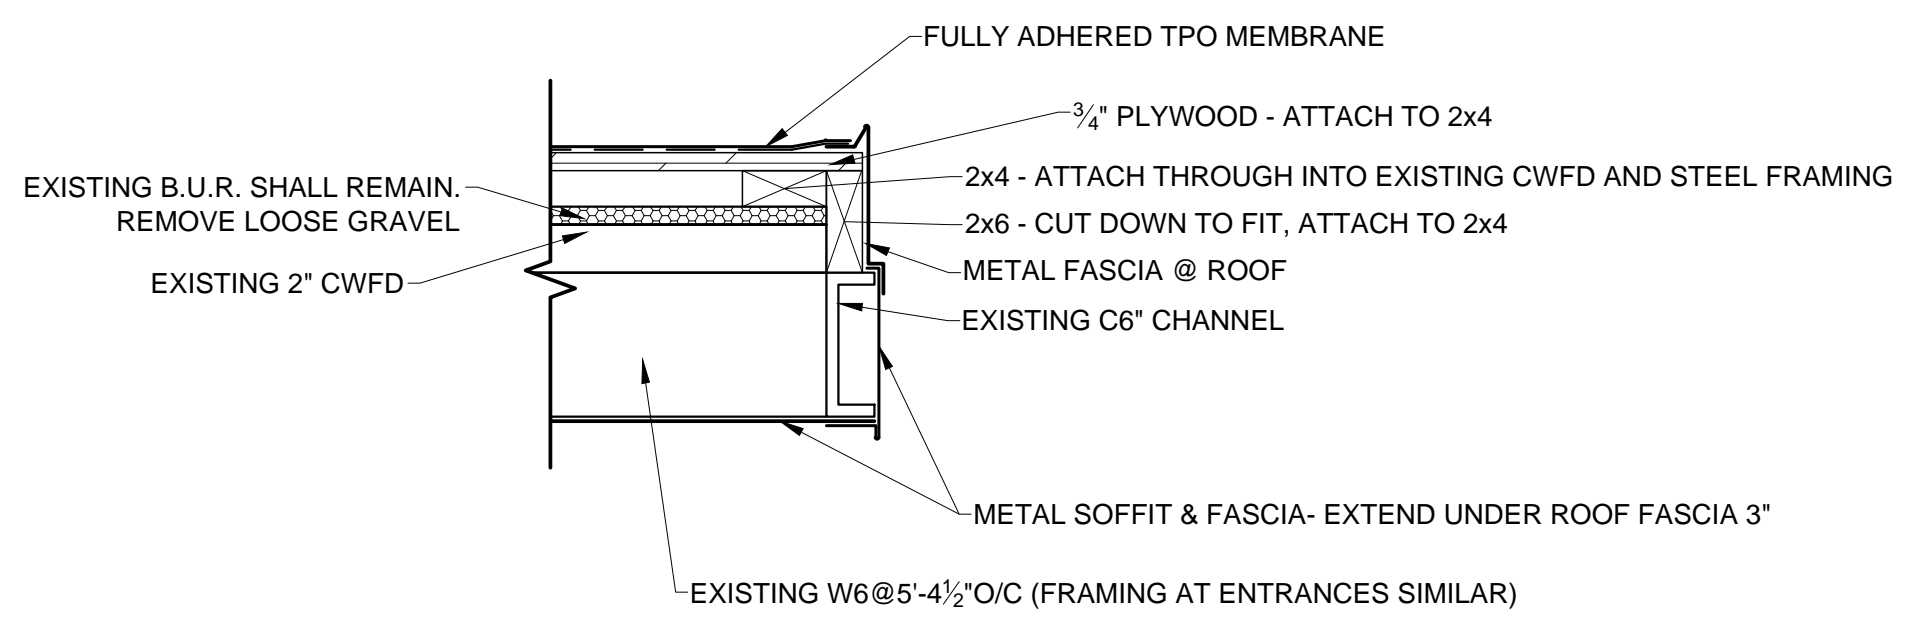


④ **DETAIL**
 SCALE: 1/2" = 1'-0"

NOTES:
 1. WOOD SHALL BE PRESSURE TREATED

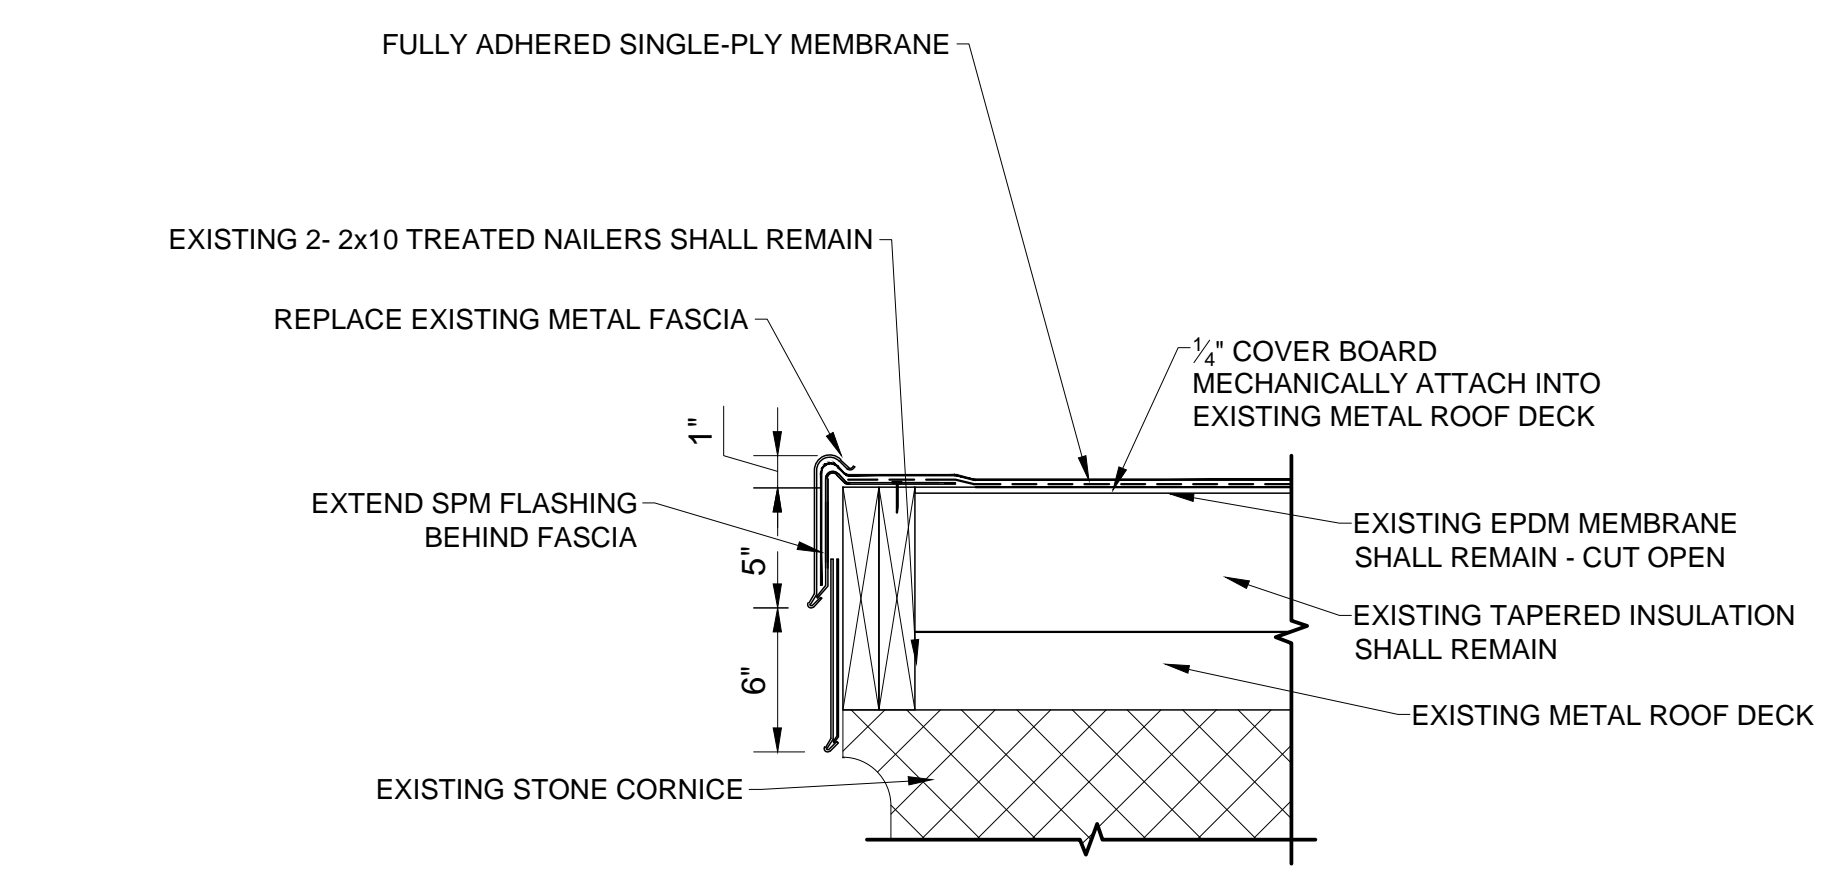

⑤ **ROOF EDGE TERMINATION**
 SCALE: 1/2" = 1'-0"

NOTE:
 REMOVE EXISTING ROOFING MATERIALS (NOT SHOWN) NOTED ON A204.

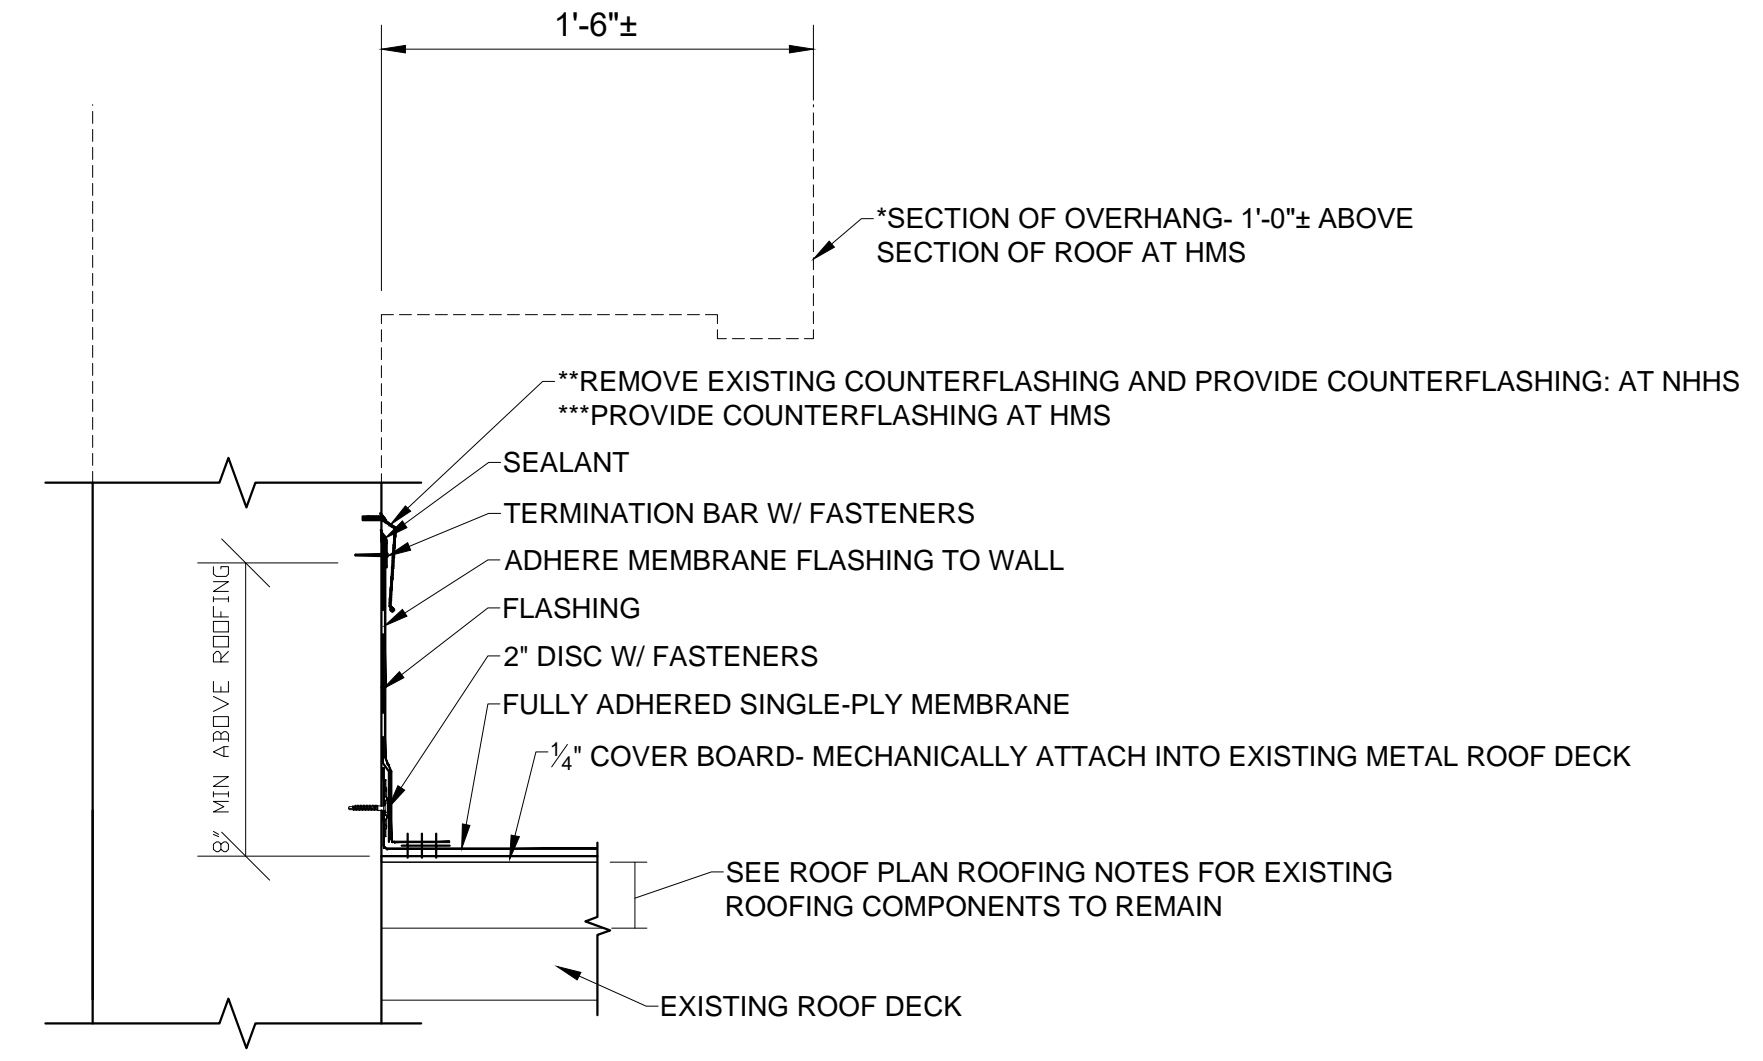

⑥ **BASE OF WALL DETAIL**
 SCALE: 1/2" = 1'-0"



HCPS ROOF REPLACEMENTS AT WHHS, NHHS, HMS & FRMS

Project Number: 23002
 Checked:
 Drawn: A. Rognas
 Date: 9/5/23
 Revisions:

DETAILS

A302

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