

**FLOOR PLAN GENERAL NOTES**


1. FILL IN ALL OPENINGS FROM REMOVAL OF MUDS, PIPING, ELECTRICAL, ETC.) IN WALLS, CEILINGS AND FLOORS WITH NEW MATERIALS AND FINISHES AND COVER ALL REPAIRS, CRACKS AND PENETRATIONS FROM CSO TO NEW PLASTER.
2. MUCK UP ROOM 108 SHALL BE USED AS A STANDARD FOR QUALITY CONTROL WITH REGARD TO WOOD FLOOR, MILLWORK, PLASTER & REFINISHING.
3. CLEAN ALL WINDOWS.
4. WALL TIES ARE SHOWN ON A3.1.
5. GENERAL CONTRACTOR TO PROVIDE 7'-6" AFF MINIMUM CLEAR FLOOR UNITS FOR ROOMS SHALL NOT BE ALLOWED BELOW 7'-0" AFF.
6. ROOF STEEL PLATES TO EACH SIDE OF THIS EXISTING WOOD BEAM TO CLEAR HEIGHT. SEE STRUCTURAL DRAWINGS, MAIN FLOOR 7-8' AFF ADA SLOPE.
7. EXISTING WOOD FLOORS TO BE SHIMMED & LEVELLED TO CONFORM TO MIN. ADA SLOPE.

**FLOOR PLAN KERNOTES**

- (A1) NEW CONCRETE SLAB WITH TOOLED JOINT AS SHOWN
- (A2) PROVIDE NEW WOOD CASING INSIDE FRAME
- (A3) VERIFY THAT RAMP DOES NOT ENDOURCH INTO EXISTING SIDEWALK.
- (A4) STAINLESS STEEL STAIR, LANDING & RAILINGS
- (A5) FINISH AROUND NEW OR EXISTING FINISH
- (A6) MATCH EXISTING HISTORIC WOOD WINDOWS (SEE SPECIFICATIONS)
- (A7) ISOLATE FLOOR SYSTEM LEVEL GRAV-SWAGE GRADE (SEE DETAIL)
- (A8) NEW WALL MOUNTED HANDRAIL.
- (A9) PATCH EXISTING MASONRY OPENING.
- (A10) NEW SLOPED SURFACE UP TO EXISTING FLOOR LEVEL, MAX SLOPE 1:12.
- (A11) EXISTING ANGLE'S BENCH TO BE RESTORED.
- (A12) NEW HANDRAILS AT ALL EXISTING STAIRS. SEE DETAILS ON SHEET A0.3 FOR CHECK FOR ROTTEN WOOD AND REPLACE IF ANY. PROVIDE NEW BRCK COATING NEW CONCRETE.
- (A13) NEW CONCRETE.
- (A14) NEW FLOOR ROOSTERS. PATCH MATCH EXISTING AT ROOM 108 CURRENTLY OUT MARBLE FLOOR TILES TO INSTALL FLOOR ROOSTERS. USE MARBLE OUTFITS TO REPLACE CRACKED OR MISSING TILES ELSEWHERE.
- (A15) REPLACE BROKEN GLASS. MATCH EXISTING.
- (A16) REPAIR FRAME AND REPLACE GLAZING WITH FIXED WINDOW.
- (A17) NOT USED
- (A18) NOT USED
- (A19) NEW WALL PLIQUE, MATCH EXISTING ON NORTH WALL OF PORTICO
- (A20) EXISTING WINDOW TO REMAIN.
- (A21) NEW DOOR.
- (A22) CLEAN AND PAINT DECORATIVE STEAM RADIATORS. THESE RADIATORS ARE OBSOLETE, ONLY (NOT FUNCTIONAL). REPLACE RADIATORS IN LOCATIONS AS DIRECTED BY ARCHITECT.
- (A23) WINDOW TO BE RESTORED TO OPERATIONAL CONDITIONS.
- (A24) NOT USED
- (A25) CLEAN AND PAINT REPAIRING STEAM RADIATORS. THESE RADIATORS ARE OBSOLETE, ONLY (NOT FUNCTIONAL). REPLACE RADIATORS IN LOCATIONS AS DIRECTED BY ARCHITECT. EXTERIOR PAINTING SHALL BE BY THE GC.
- (A26) INSTALL NEW MARBLE FLOORING TO MATCH EXISTING MARBLE.
- (A27) REPLACE EXISTING DAMAGED MARBLE FLOORING WITH SIMILAR REMOVED FROM NORTH STAIRS (RM 107) AND SOUTH STAIRS (RM 110). RESTORE UNDELETED MARBLE IN ALL AREAS THAT IS MORE THAN 1/4" AT VARIANCE WITH ADJOINING STAIRS. MARBLE TO BE MATCHED TO EXISTING MARBLE. MARBLE TO BE STORED/RETURNED TO OWNER AT OWNER'S DIRECTION.
- (A28) EXISTING HORSE TROUGH TO BE PROTECTED AND CLEANED
- (A29) WOOD SHELVES
- (A30) ROPE BARRIER
- (A31) EXISTING SKYLIGHT TO REMAIN
- (A32) WINDOWS TO BE RESTORED TO OPERATIONAL CONDITIONS.
- (A33) EXISTING CERAMIC TILE FLOORS - OFFICE 014 AND SOUTH STAIR 013 LANDING. THE EXISTING CERAMIC TILE CLEANED, PATCHED AND REPAIRED WITH THE MATERIALS RESORT AREA AS NEEDED.
- (A34) EXISTING MATERIAL TO BE LEFT EXPOSED.
- (A35) THE PLAN INDICATES THAT SOME EXISTING MATERIALS ARE TO BE LEFT EXPOSED. THESE AREAS HAVE SOME HISTORICAL SIGNIFICANCE AND WILL REMAIN UNCOVERED. STONE AND BRICK MASONRY SHALL BE CLEANED REPAIRED AND REFINISHED. ALL EXPOSED MILLWORK SHALL BE CLEANED REPAIRED AND FINISHED. ALL EXPOSED WOOD SHALL BE CLEANED REPAIRED AND FINISHED. WOOD SURFACES SHALL BE STAIN WASHED, PRIME AND REPAIRED. IRON BARS SHALL BE WIRE BRUSHED, CLEANED, PRIME AND REPAIRED.
- (A36) GENERAL CONTRACTOR TO REMOVE EXISTING ARCH WOOD WINDOWS ON NEW HISTORIC WINDOWS. INSTALL ALL REPAIRS AS REQUIRED. (SEE SPECIFICATIONS)
- (A37) INSTALL SKYLIGHT BOXES SALVAGED FROM OTHER AREA OF THE HISTORIC COURTHOUSE. ALL EXPOSED MILLWORK SHALL BE REFINISHED TO MATCH THE SKYLIGHT LENSE. INSTALL LIGHT FIXTURES INSIDE THE SKYLIGHT ABOVE MOUNT FIXTURE ON THE SIDE OF THE SKYLIGHT. FRAME ORIENTED SO THE PERSON FINAL POSITIONING AND MOUNTING OF THE LENSE. THE CENTER SHALL BE THE CENTER OF THE A/E.

**LEGEND**


- NEW CONSTRUCTION (WITH DOOR NUMBER)
- EXISTING CONSTRUCTION TO REMAIN
- WMB WALL MOUNTED BRACKET FOR FIRE EXTINGUISHER CABINET
- FEC FIRE EXTINGUISHER CABINET
- AI PARTITION TYPE DESIGNATION. SEE DETAILS SHEET A9.0
- E-1 FLOOR TO WALL EXPANSION JOINT
- E-2 FLOOR TO FLOOR EXPANSION JOINT
- E-3 WALL TO WALL EXPANSION JOINT
- FCU FIN FLOOR UNIT BY AREA. SEE A1.2 FOR CHAIR DETAIL & ELEVATIONS.
- FLOOR PATTERN COLOR A AND B
- VBC VERTICAL BRICK CONTROL JOINT

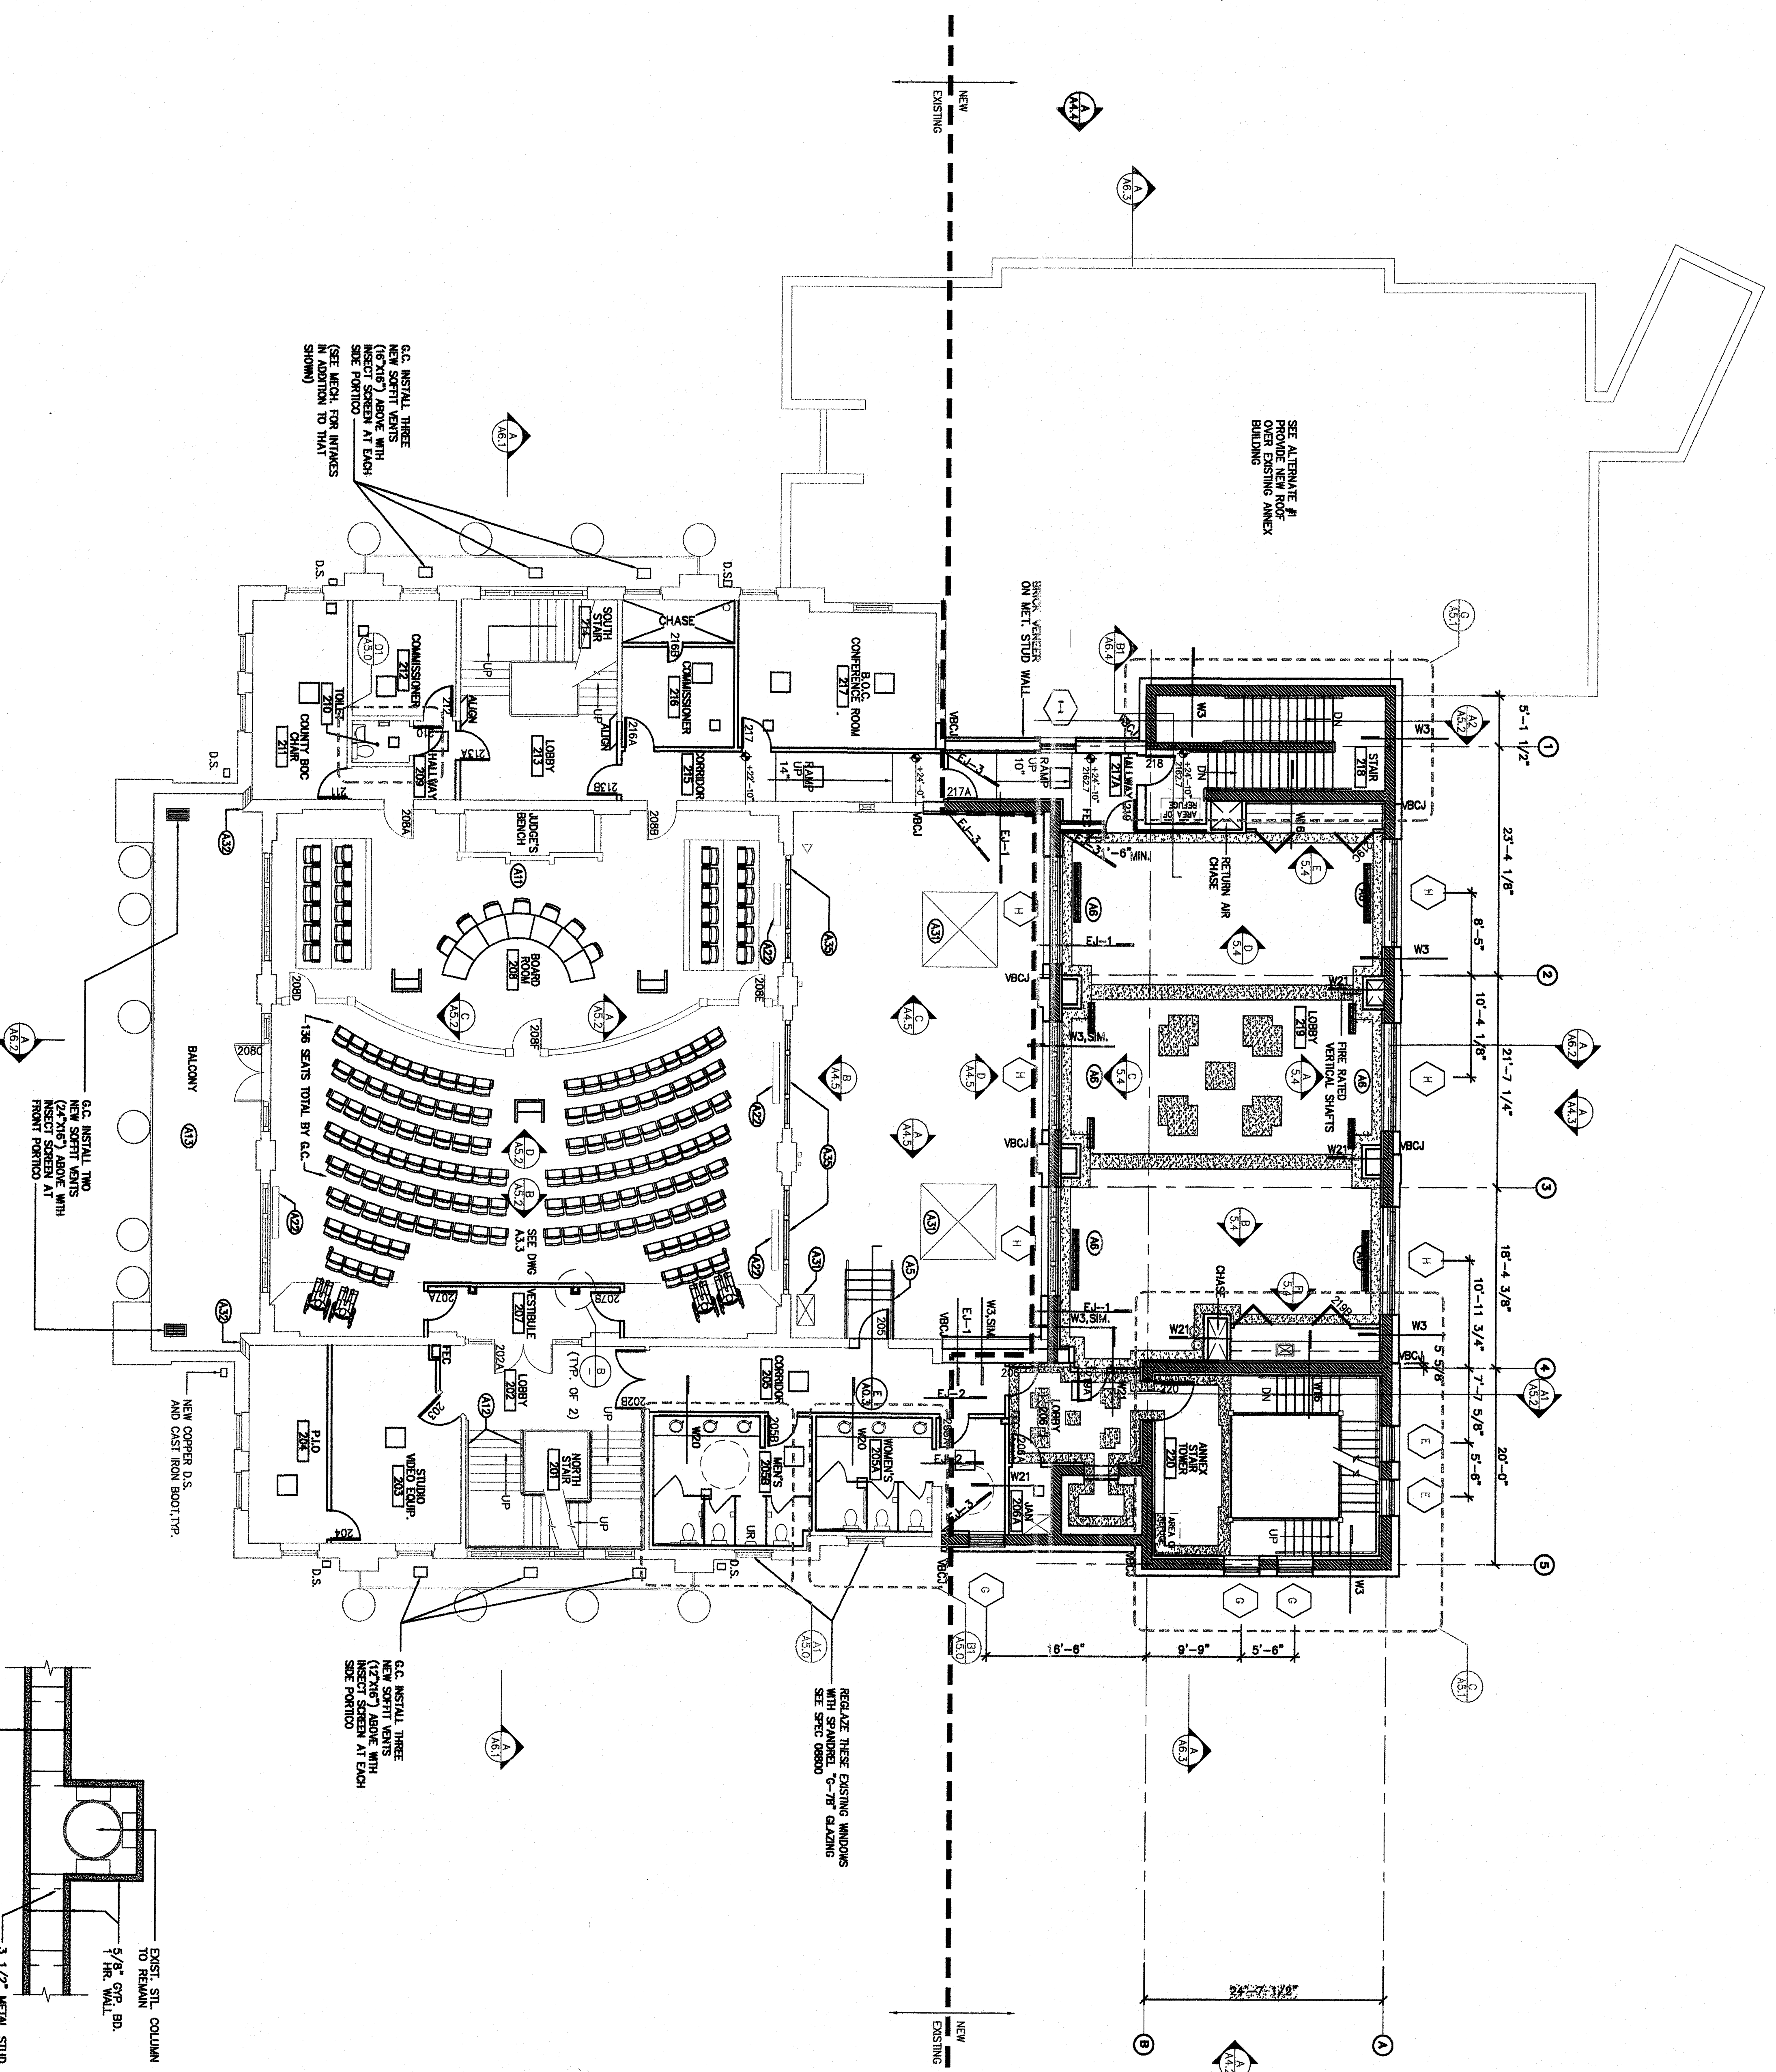

**A FLOOR PLAN - 2ND FLOOR**  
SCALE: 1/8" = 1'-0"



**B COLUMN DETAIL**  
SCALE: 1 1/2" = 1'-0"

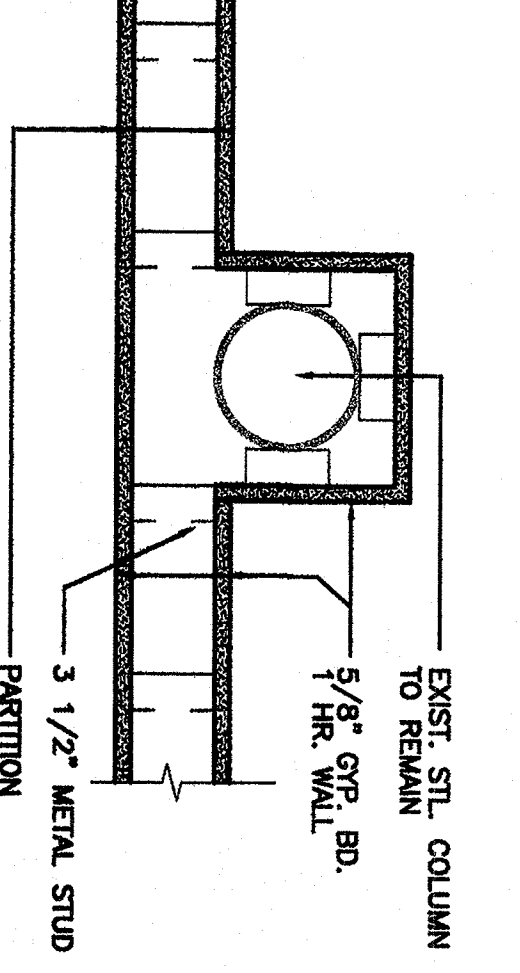

Architect of Record: **ANTOINE ARCHITECTS, LLC**  
146 PLYMOUTH PLACE, HARRISVILLE, LA, 70448

LOCAL GOVERNMENT CONSULTANT: **MOHSEN GHOREISHI**  
801 N. TRYON ST., 10TH FL., CHARLOTTE, NC, 28202

HENDERSONVILLE, NC  
HENDERSON COUNTY HISTORIC COURTHOUSE REHABILITATION & NEW ANNEX ADDITION

HENDERSONVILLE, NC  
SHEET TITLE: FLOOR PLAN - 2ND FLOOR

DATE: March 23, 2008  
PROJECT NO.: C2005H0105  
SEALS

DRAWN BY: [Signature]  
CHECKED BY: [Signature]

DATE: [Blank]  
REVISIONS: [Blank]

CPR NUMBER: [Blank]

INCLUDES SHEETS: [Blank]

SHEET NUMBER: **A2.2**