

AREA B _____ AREA A COSTUME STORAGE 017 STAGE 002S VESTIBULE 001A SPECIAL SYSTEMS FLOOR PLAN - LEVEL 0 - AREA B

GENERAL NOTES

A. OUTLET AND EQUIPMENT LOCATIONS ARE SHOWN FOR REFERENCE. COORDINATE WITH BRCC IT DEPT. AND ARCHITECT FOR FINAL LOCATIONS OF DEVICES AND VOICE/DATA OUTLETS.

B. CABLES CONTAINED IN CABLE TRAYS NEED NOT BE IN CONDUIT EXCEPT FIBER OPTIC CABLES, WHICH SHALL BE IN INNERDUCT. C. COORDINATE WITH OTHER TRADES PLANS PRIOR TO INSTALLING CABLE

TRAY TO ENSURE OF NO EQUIPMENT CONFLICTS. D. FIRESEAL ALL WALL AND FLOOR PENETRATIONS WITH UL LISTED FIRE

E. SEE DETAIL 9 ON ET501 FOR INTERCONNECTIVITY RACEWAYS BETWEEN FLOORBOXES, TV BOXES, PROJECTORS, AND CEILING MOUNTED DATA

HENDERSON COUNTY AND BLUE RIDGE COMMUNITY COLLEGE

BRCC - PATTON HALL INTERIOR RENOVATION **AND ADDITION** 180 W CAMPUS DR. FLAT ROCK, NC 28731




CLARKNEXSEN

301 College Street, Suite 300 Asheville, North Carolina 28801 828-232-0608 www.clarknexsen.com

KEY NOTES

- PROVIDE TELECOM 12" WIRE MESH CABLE TRAY ABOVE CEILING AS SHOWN. PROVIDE WALL MOUNTED TELECOM RACK PER SPECIFICATIONS. PROVIDE (4) 4" CONDUIT SLEEVE(S) ABOVE CEILING TO CABLE TRAY ABOVE CORRIDOR. ALL BENDS SHALL BE LARGE RADIUS SWEEPING BENDS. 4 PROVIDE (2) 2" CONDUIT SLEEVE WITH NYLON BUSHINGS ABOVE ACCESSIBLE
- CEILING. TYPICAL FOR ALL LOCATIONS SHOWN ON PLANS. ROUTE 1" CONDUIT FROM J-BOX TO TECHBOOTH 002A FOR SPEAKER INSTALLATION. COORDINATE EXACT LOCATION WITH OWNER PRIOR TO
- ROUTE 1" CONDUIT FROM J-BOX IN CEILING TO TECHBOOTH 002A FOR
- CEILING MOUNTED SPEAKER CLUSTER INSTALLATION. COORDINATE EXACT LOCATION WITH OWNER PRIOR TO ROUGH-IN. PROVIDE 2" CONDUIT SLEEVE WITH NYLON BUSHINGS ABOVE ACCESSIBLE CEILING FOR FUTURE SOUND CABLING INSTALLATION.TYPICAL FOR ALL
- LOCATIONS SHOWN ON PLANS. 8 POWER, DATA, AND COMPUTER/ HDMI CONNECTIONS TO TELEVISION. COORDINATE MOUNTING HEIGHT WITH ARCHITECT/ OWNER. PROVIDE FSR-PWB-250 BOX OR APPROVED EQUAL. PROVIDE (1) 1 1/4" CONDUIT TO ABOVE CABLE TRAY FOR DATA AND (1) 1 1/4" CONDUIT TO TECH BOOTH 002A FOR COMPUTER/ HDMI CONNECTIONS. COORDINATE EXACT STUB UP LOCATIONS IN TECH BOOTH WITH ARCHITECT/ OWNER. COORDINATE EXACT FSR BOX INSERTS WITH OWNER.



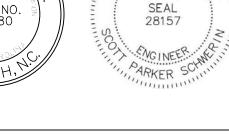



10/19/20

SUBMITTAL

CONSTRUCTION DOCUMENTS

1 11/20/20 ADDENDUM 1 KEY PLAN

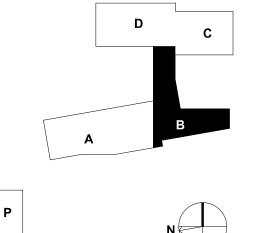


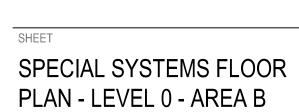

ET102

GRAPHIC SCALE(S)

DESIGN: MRB
DRAWN: SJB
REVIEW: SPS

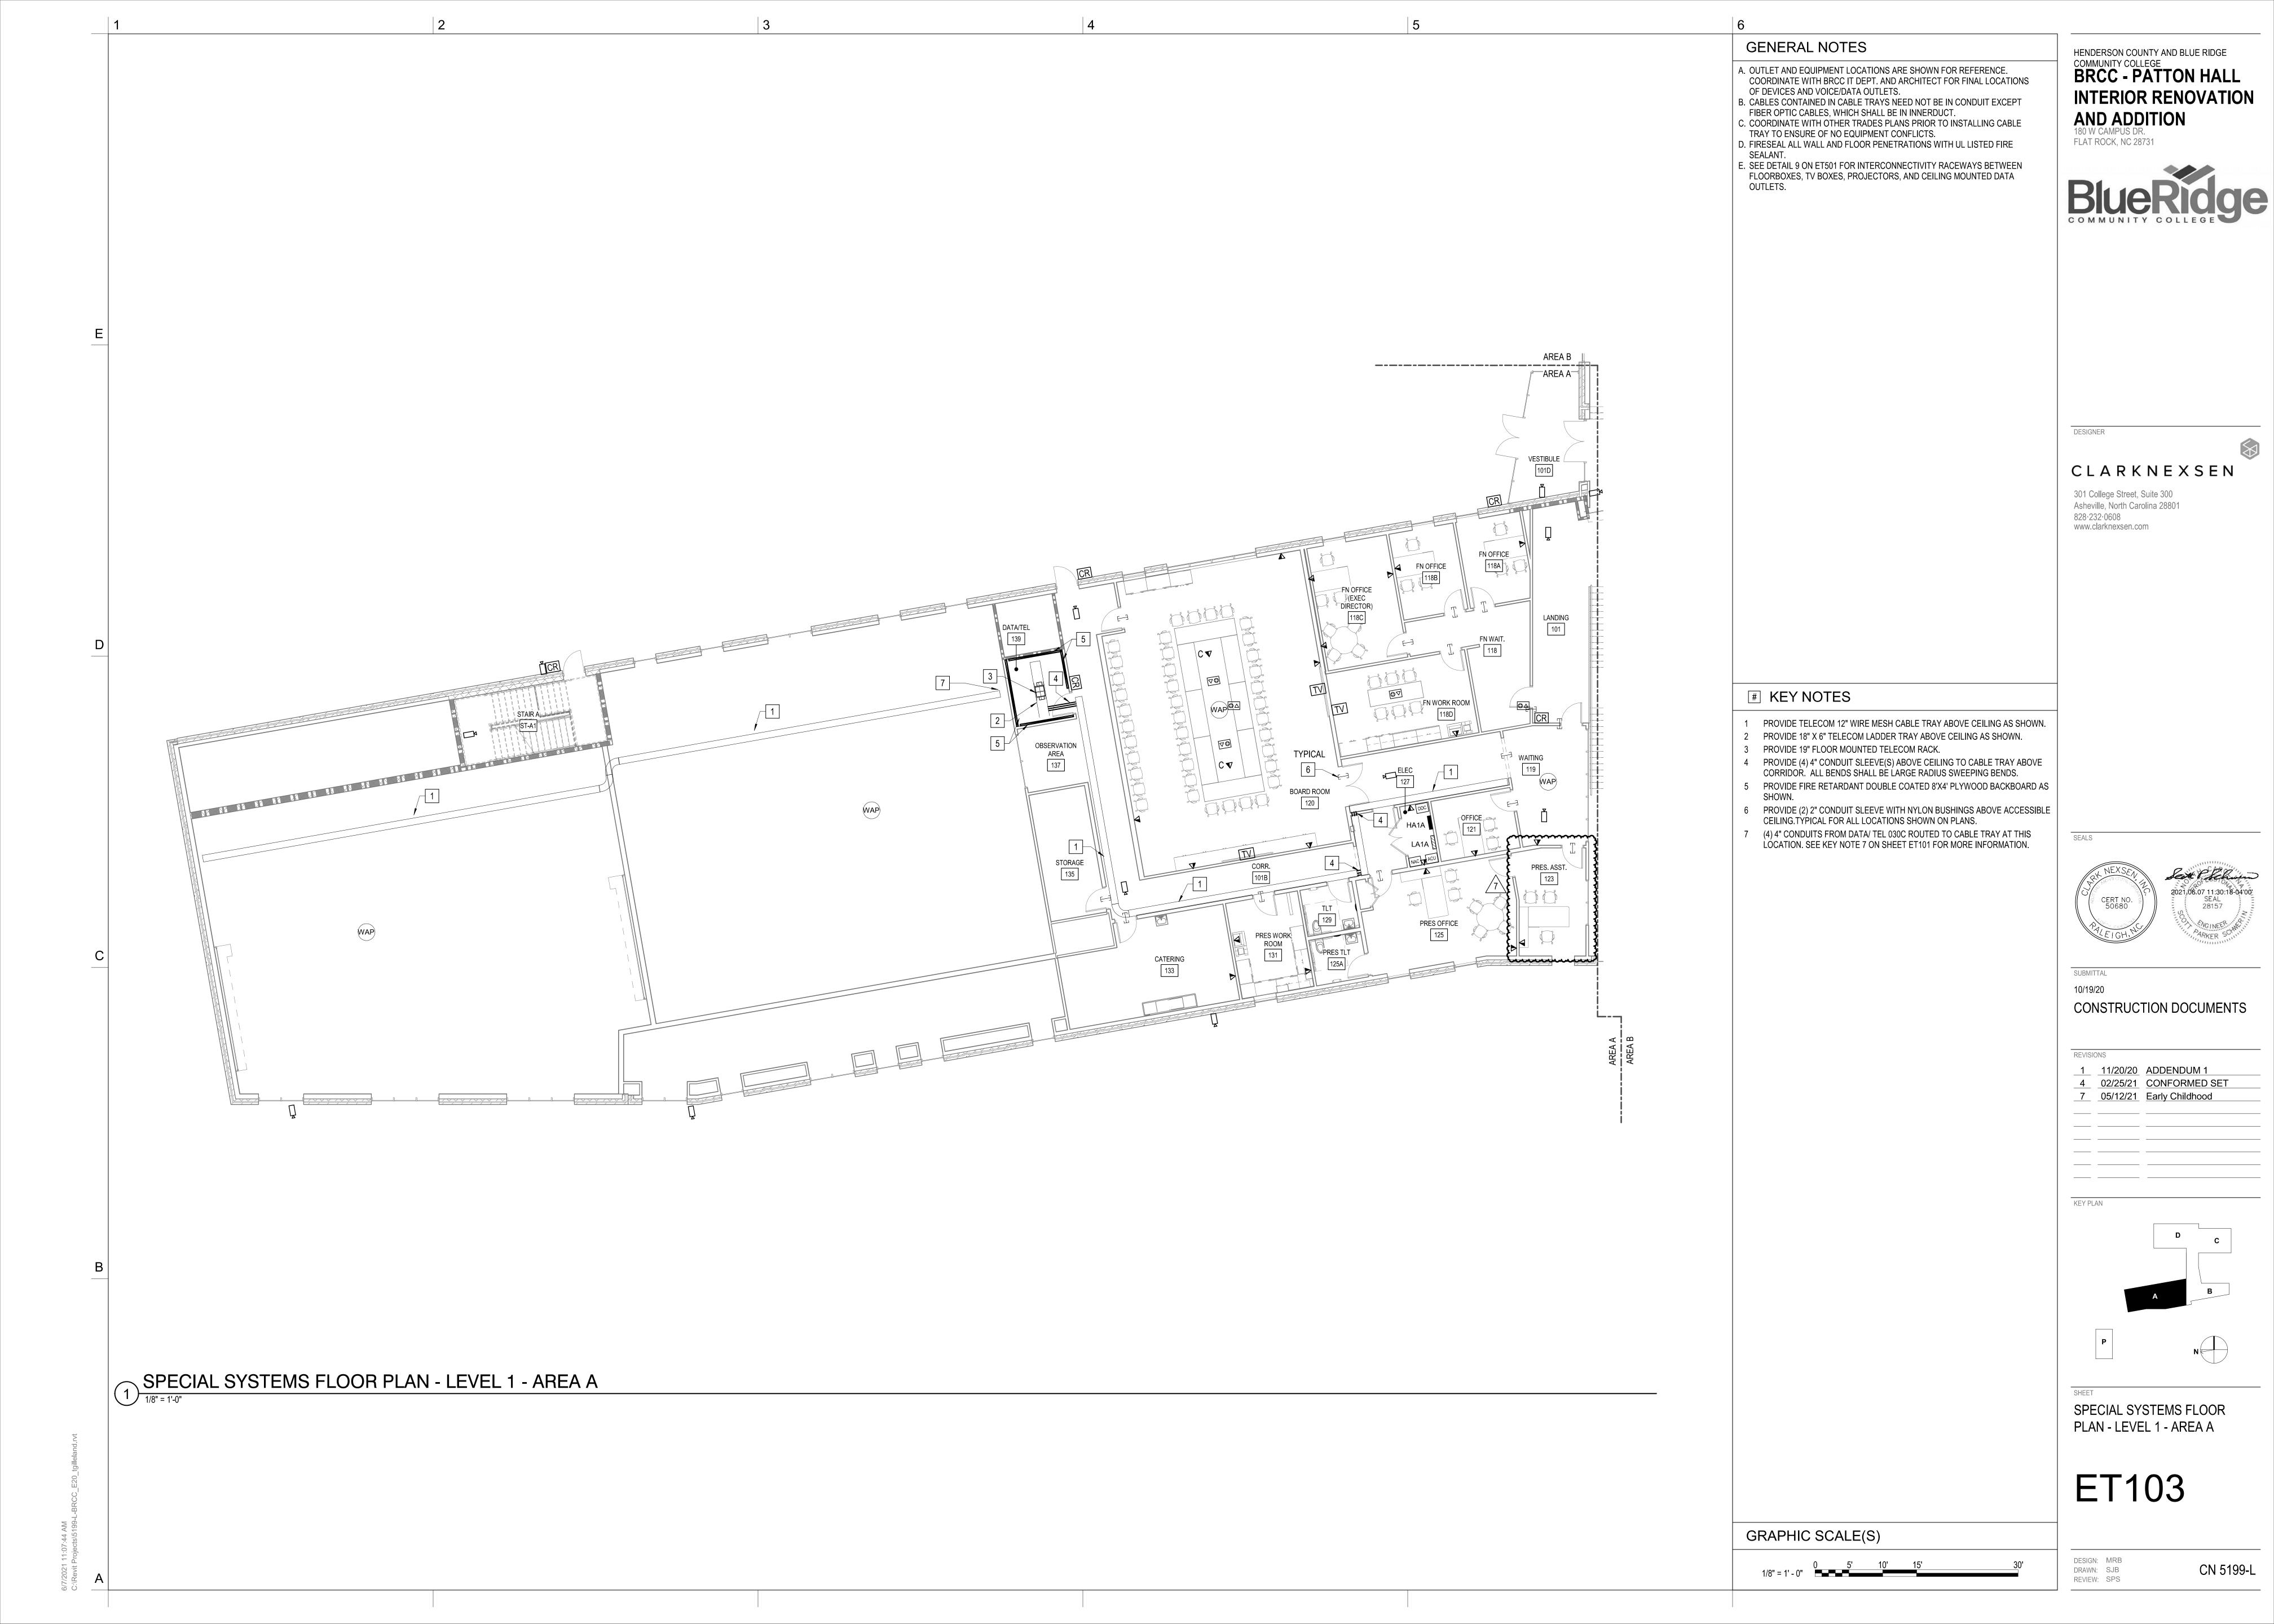

GENERAL NOTES

- A. OUTLET AND EQUIPMENT LOCATIONS ARE SHOWN FOR REFERENCE. COORDINATE WITH BRCC IT DEPT. AND ARCHITECT FOR FINAL LOCATIONS
- OF DEVICES AND VOICE/DATA OUTLETS. B. CABLES CONTAINED IN CABLE TRAYS NEED NOT BE IN CONDUIT EXCEPT FIBER OPTIC CABLES, WHICH SHALL BE IN INNERDUCT. C. COORDINATE WITH OTHER TRADES PLANS PRIOR TO INSTALLING CABLE
- TRAY TO ENSURE OF NO EQUIPMENT CONFLICTS. D. FIRESEAL ALL WALL AND FLOOR PENETRATIONS WITH UL LISTED FIRE E. SEE DETAIL 9 ON ET501 FOR INTERCONNECTIVITY RACEWAYS BETWEEN FLOORBOXES, TV BOXES, PROJECTORS, AND CEILING MOUNTED DATA

HENDERSON COUNTY AND BLUE RIDGE COMMUNITY COLLEGE BRCC - PATTON HALL

AND ADDITION

180 W CAMPUS DR. FLAT ROCK, NC 28731


INTERIOR RENOVATION

CLARKNEXSEN

301 College Street, Suite 300 Asheville, North Carolina 28801 828-232-0608 www.clarknexsen.com

KEY NOTES

- PROVIDE TELECOM 12" WIRE MESH CABLE TRAY ABOVE CEILING AS SHOWN.
- PROVIDE 18" X 6" TELECOM LADDER TRAY ABOVE CEILING AS SHOWN.
- PROVIDE 19" FLOOR MOUNTED TELECOM RACK.
- PROVIDE (4) 4" CONDUIT SLEEVE(S) ABOVE CEILING TO CABLE TRAY ABOVE CORRIDOR. ALL BENDS SHALL BÈ LARGE RADIUS SWEEPING BENDS. PROVIDE FIRE RETARDANT DOUBLE COATED 8'X4' PLYWOOD BACKBOARD AS
- PROVIDE (2) 2" CONDUIT SLEEVE WITH NYLON BUSHINGS ABOVE ACCESSIBLE CEILING.TYPICAL FOR ALL LOCATIONS SHOWN ON PLANS.

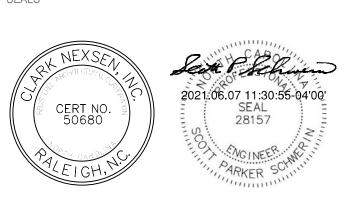


10/19/20

CONSTRUCTION DOCUMENTS

1 11/20/20 ADDENDUM 1 4 02/25/21 CONFORMED SET 7 05/12/21 Early Childhood

KEY PLAN

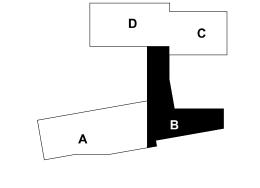


SPECIAL SYSTEMS FLOOR PLAN - LEVEL 1 - AREA B

ET104

GRAPHIC SCALE(S)

DESIGN: MRB
DRAWN: SJB
REVIEW: SPS

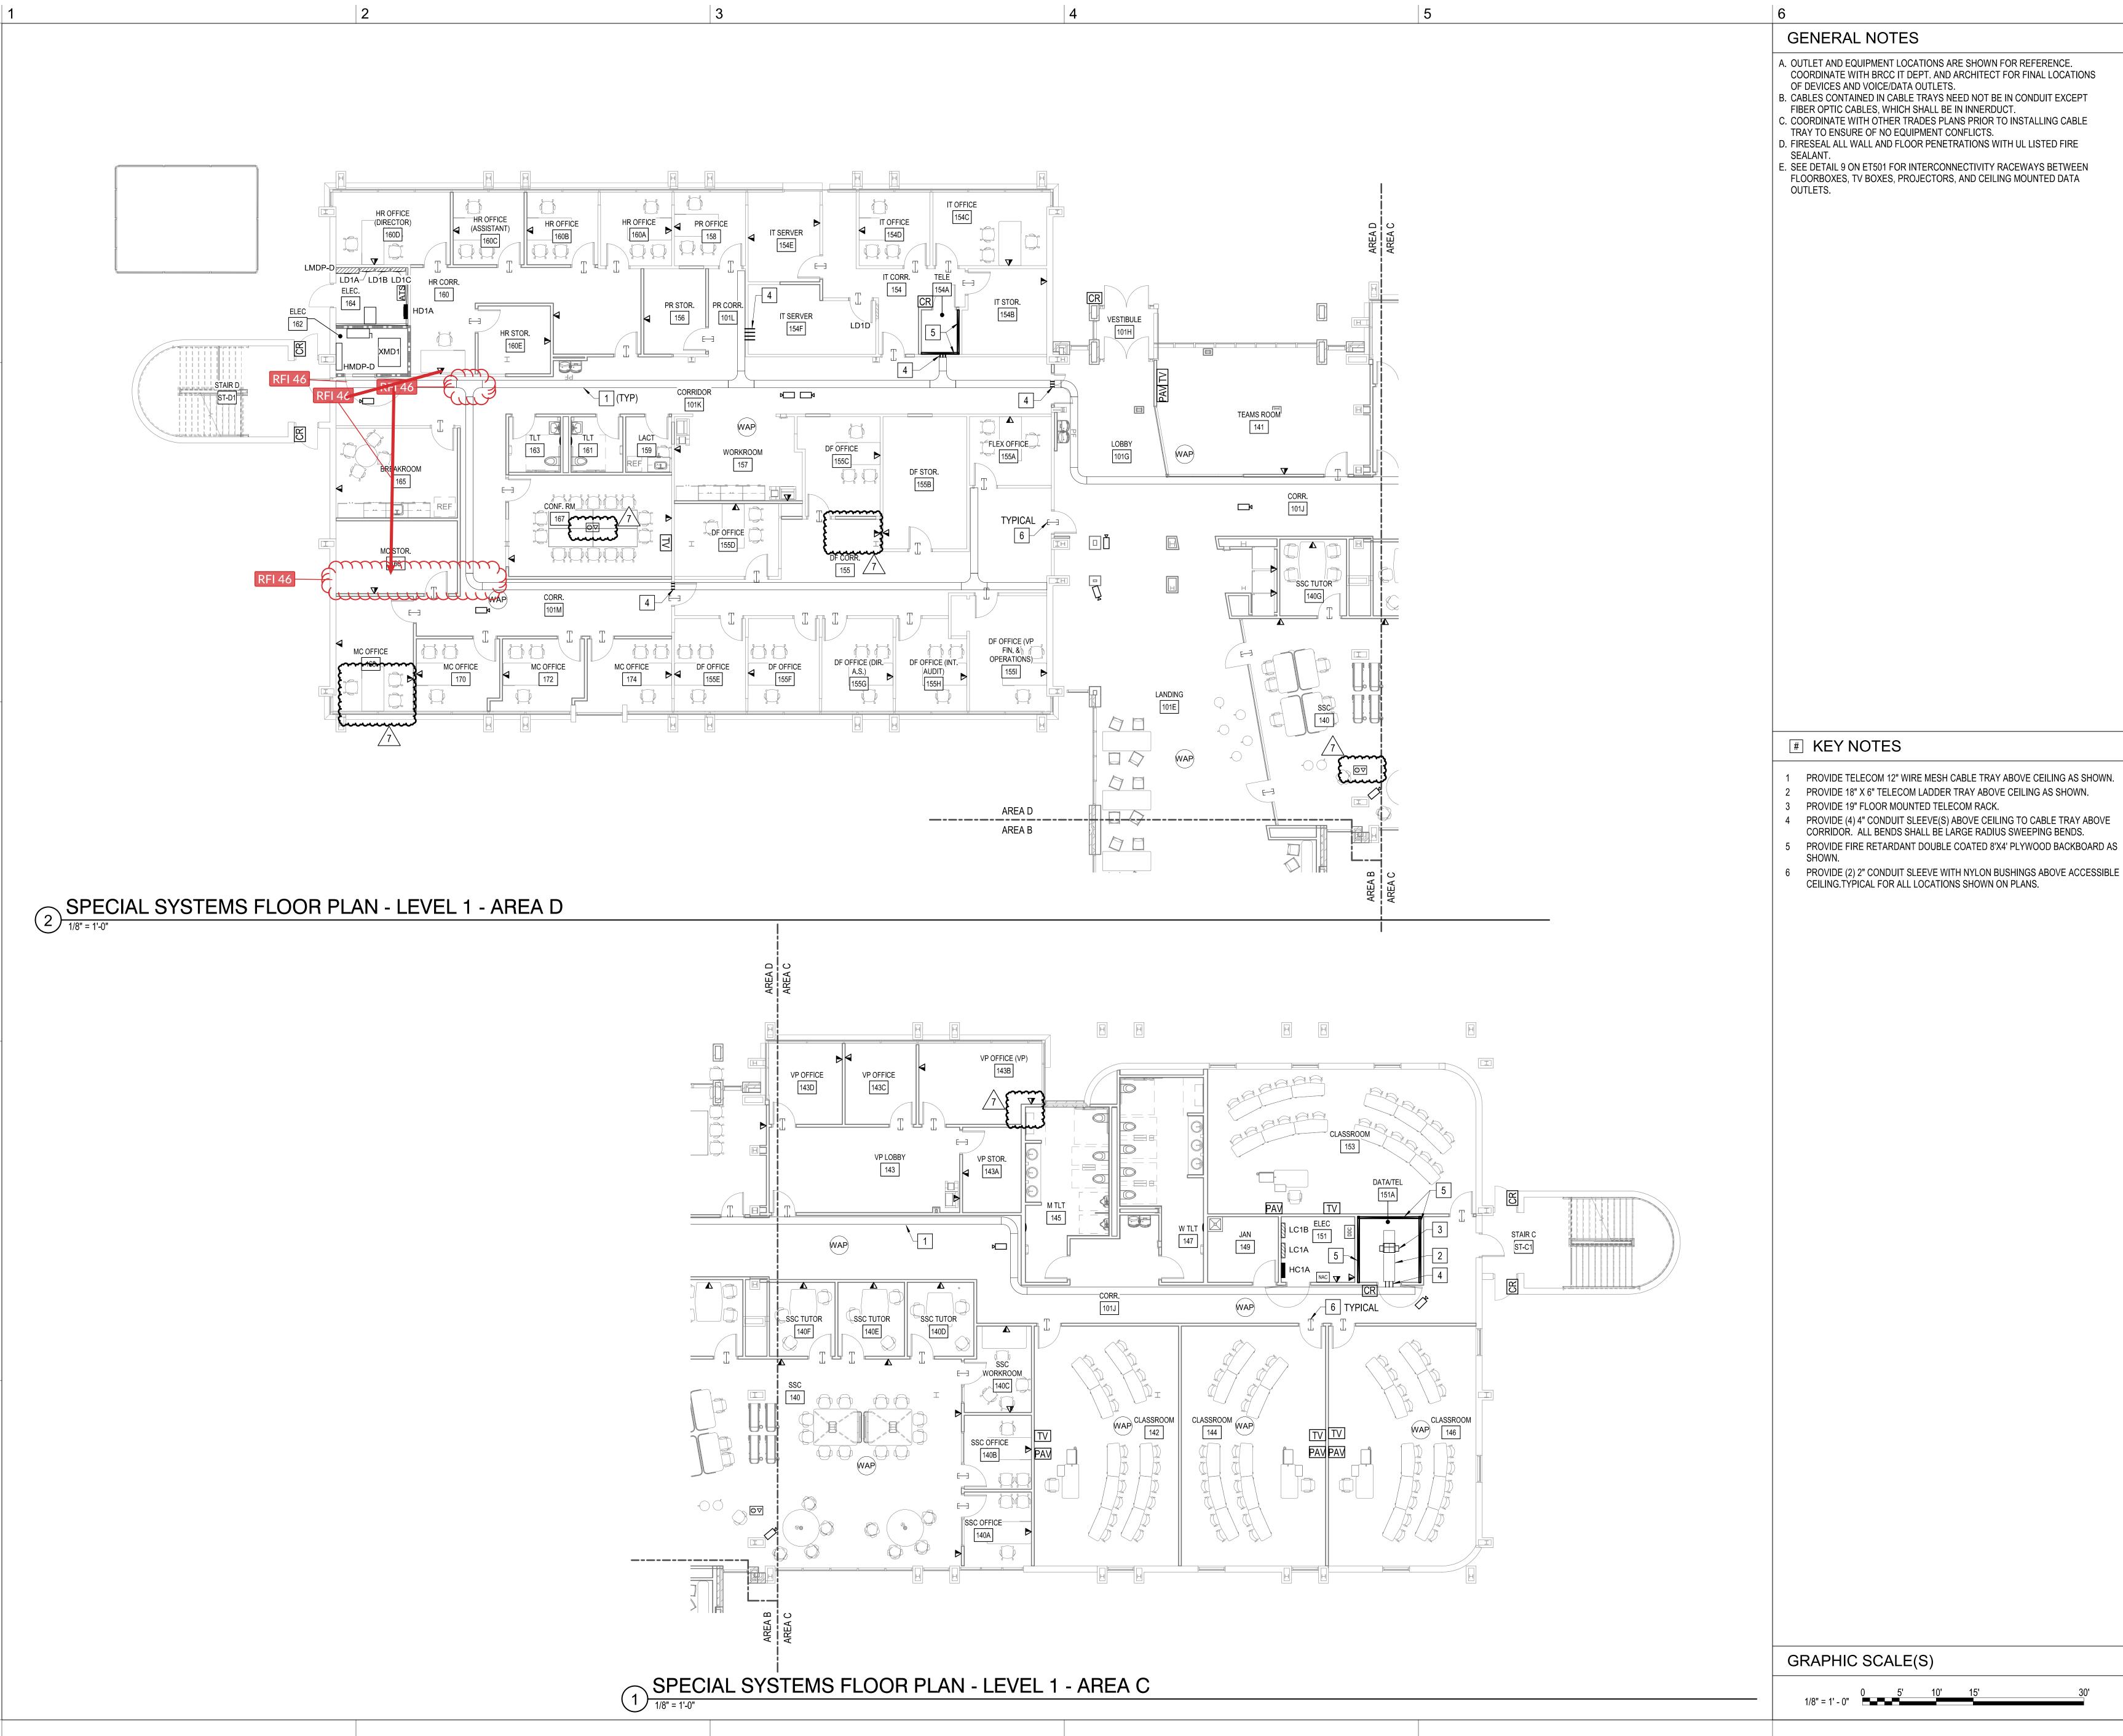

HENDERSON COUNTY AND BLUE RIDGE COMMUNITY COLLEGE

BRCC - PATTON HALL INTERIOR RENOVATION **AND ADDITION**

180 W CAMPUS DR. FLAT ROCK, NC 28731

CLARKNEXSEN

301 College Street, Suite 300 Asheville, North Carolina 28801 828-232-0608 www.clarknexsen.com

- PROVIDE (4) 4" CONDUIT SLEEVE(S) ABOVE CEILING TO CABLE TRAY ABOVE
- PROVIDE FIRE RETARDANT DOUBLE COATED 8'X4' PLYWOOD BACKBOARD AS

10/19/20

CONSTRUCTION DOCUMENTS


1 11/20/20 ADDENDUM 1 7 05/12/21 Early Childhood

SPECIAL SYSTEMS FLOOR

PLAN - LEVEL 1 - AREA C & D

ET105

DESIGN: MRB
DRAWN: SJB
REVIEW: SPS CN 5199-L

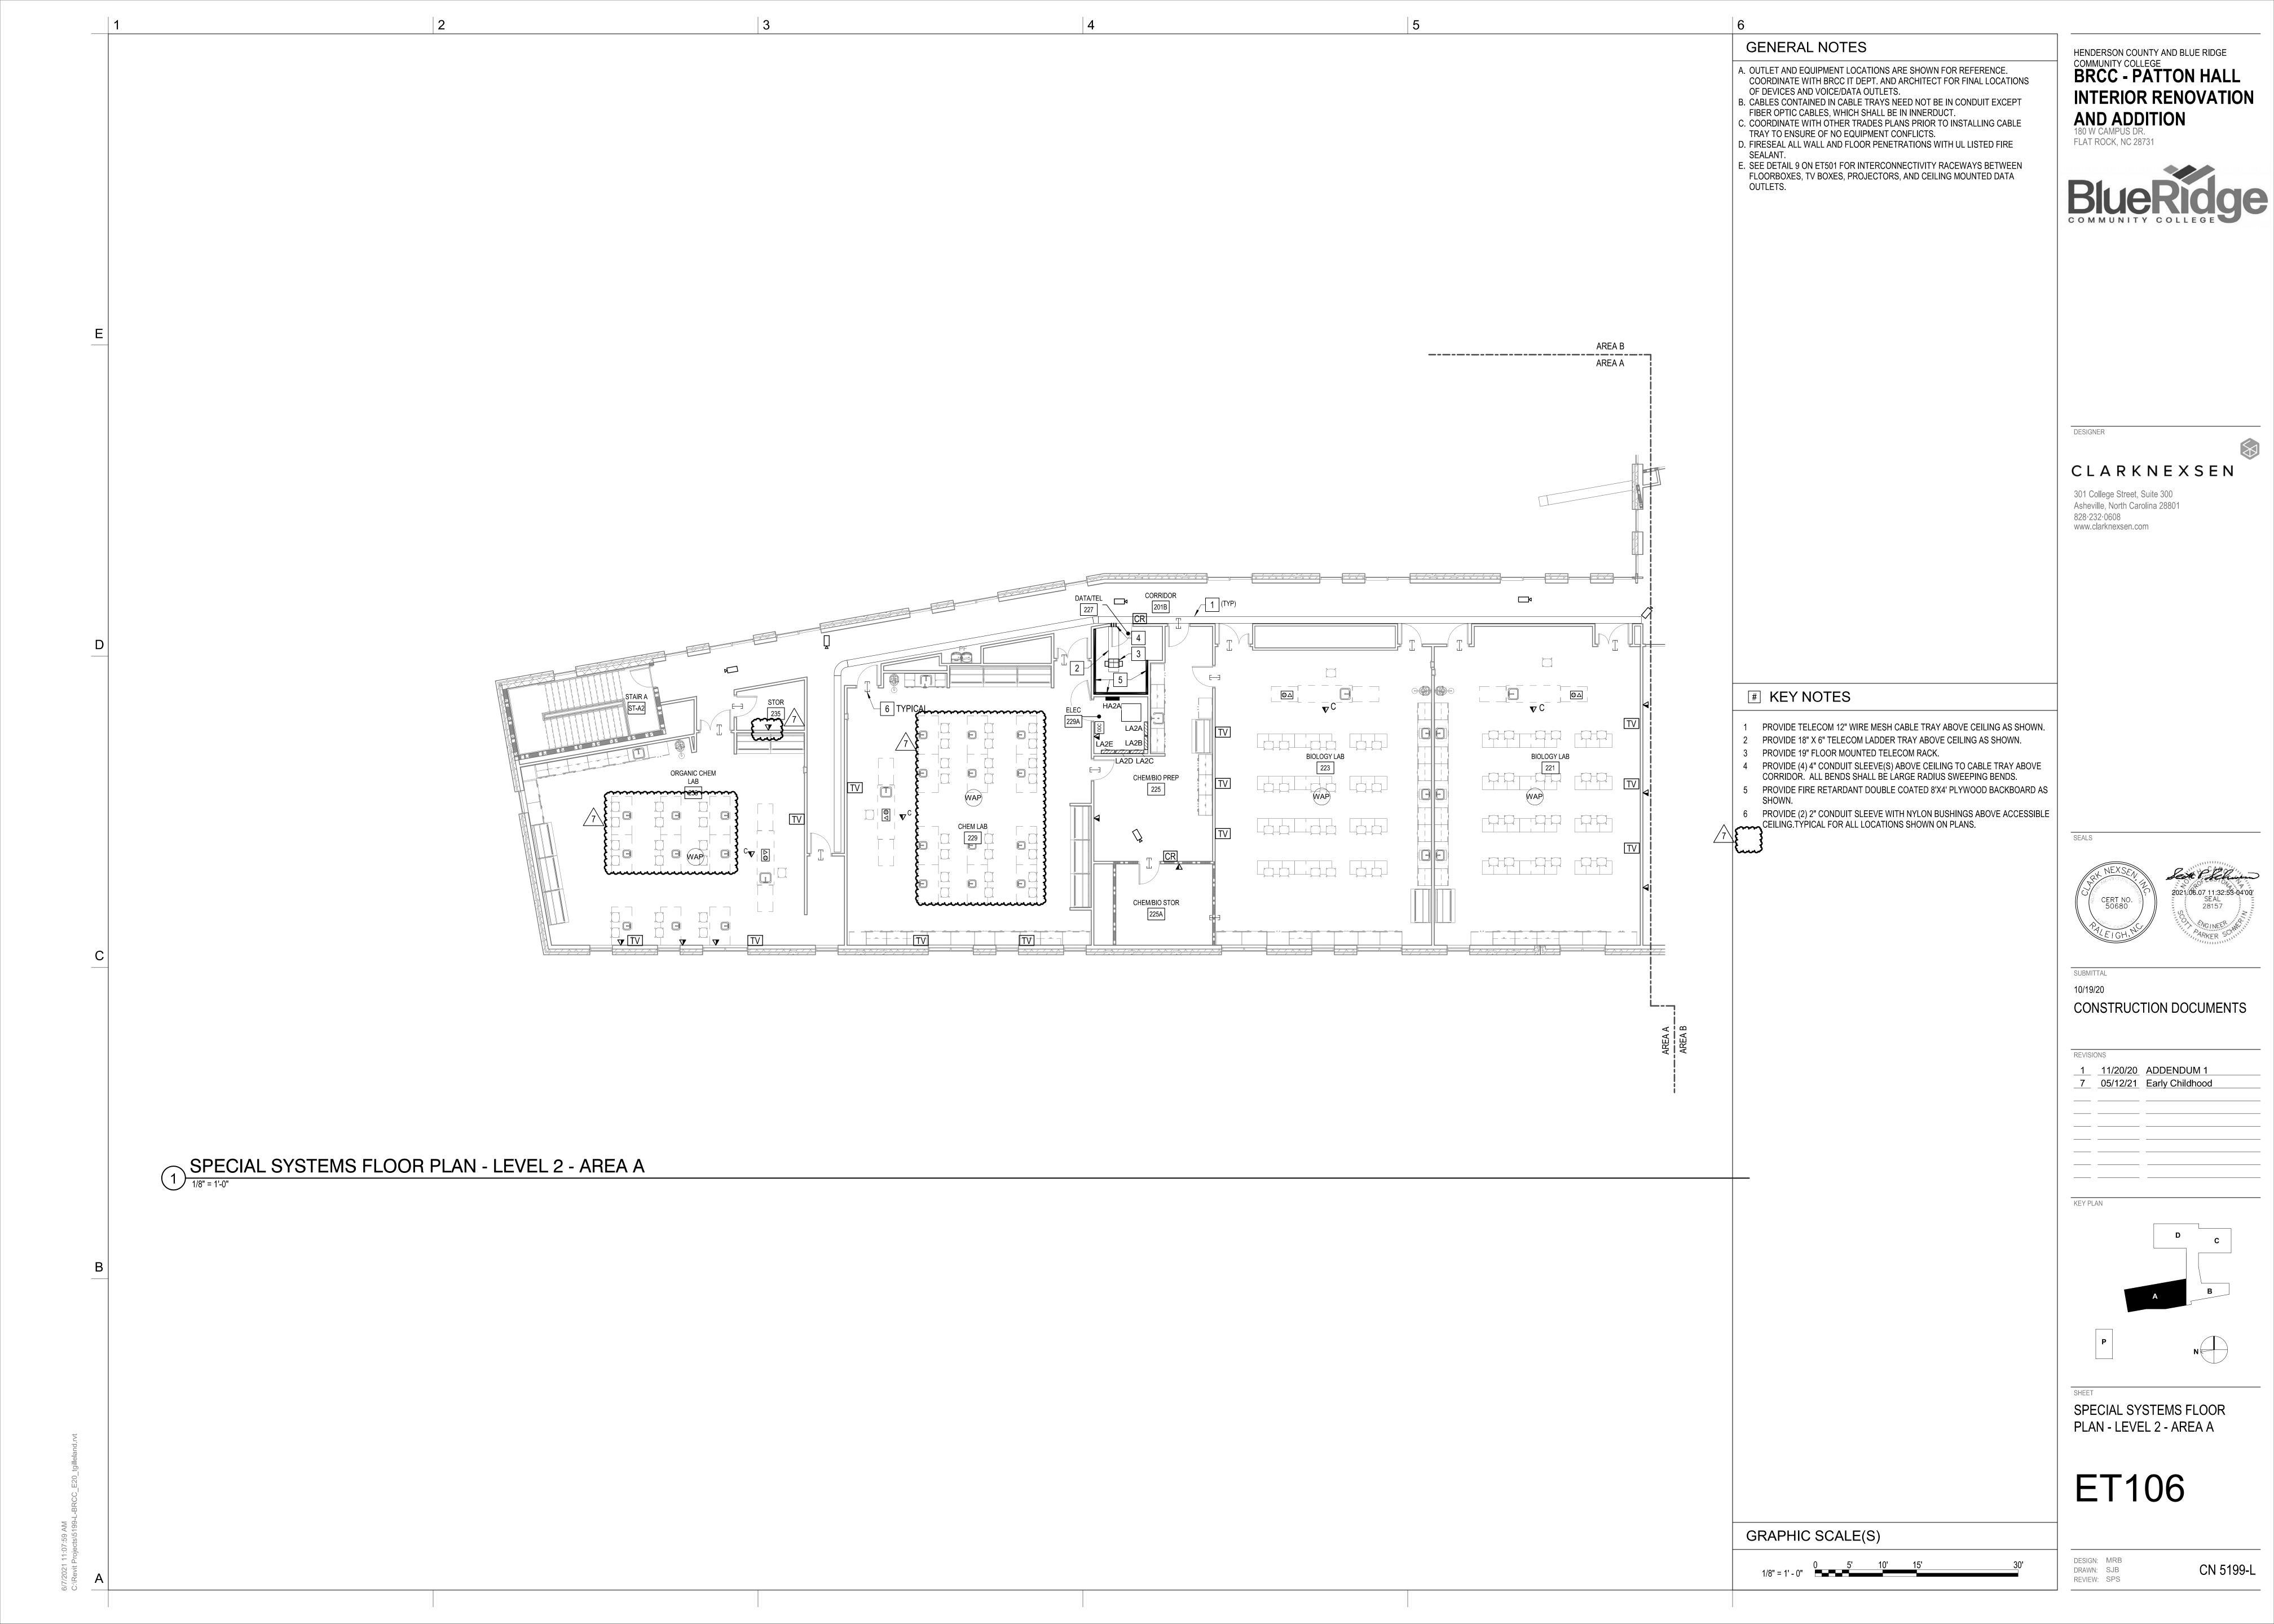

GENERAL NOTES

A. OUTLET AND EQUIPMENT LOCATIONS ARE SHOWN FOR REFERENCE.
COORDINATE WITH BRCC IT DEPT. AND ARCHITECT FOR FINAL LOCATIONS OF
DEVICES AND VOICE/DATA OUTLETS.
B. CABLES CONTAINED IN CABLE TRAYS NEED NOT BE IN CONDUIT EXCEPT

B. CABLES CONTAINED IN CABLE TRAYS NEED NOT BE IN CONDUIT EXCEPT FIBER OPTIC CABLES, WHICH SHALL BE IN INNERDUCT.

C. COORDINATE WITH OTHER TRADE PLANS PRIOR TO INSTALLING CABLE TRAY TO ENSURE OF NO EQUIPMENT CONFLICTS.

TO ENSURE OF NO EQUIPMENT CONFLICTS.

D. FIRESEAL ALL WALL AND FLOOR PENETRATIONS WITH UL LISTED FIRE

E. CONTRACTOR TO PROVIDE AN IN-BUILDING RADIO SIGNAL AMPLIFICATION SYSTEM (IBEC) TO PROVIDE COMPLETE COVEREAGE IN THE BUILDING FOR THE PUBLIC SAFETY AGENCIES AS REQUIRED BY THE LOCAL AHJ THAT MEETS THE CURRENT NFPA 72, IFC 510.2 AND ALL LOCAL CODES AND ORDINANCES. SEE SPECIFICATIONS FOR PERFORMANCE SPEC.

HENDERSON COUNTY AND BLUE RIDGE
COMMUNITY COLLEGE
BRCC - PATTON HALL
INTERIOR RENOVATION
AND ADDITION
180 W CAMPUS DR

FLAT ROCK, NC 28731

BlueRidge

CLARKNEXSEN

301 College Street, Suite 300 Asheville, North Carolina 28801 828·232·0608 www.clarknexsen.com

KEY NOTES

- 1 PROVIDE TELECOM 12" WIRE MESH CABLE TRAY ABOVE CEILING AS SHOWN.
- 2 PROVIDE 18" X 6" TELECOM LADDER TRAY ABOVE CEILING AS SHOWN.
- 3 PROVIDE 19" FLOOR MOUNTED TELECOM RACK.
- 4 PROVIDE (4) 4" CONDUIT SLEEVE(S) ABOVE CEILING TO CABLE TRAY ABOVE CORRIDOR. ALL BENDS SHALL BE LARGE RADIUS SWEEPING BENDS.
- 5 PROVIDE FIRE RETARDANT DOUBLE COATED 8'X4' PLYWOOD BACKBOARD AS
- 6 ROUTE (2) 2" CONDUITS FROM DATA ROOM TO UNDERSIDE OF ROOF DECKING
- FOR IBEC. SEE GENERAL NOTE E ABOVE FOR MORE INFORMATION.

 7 PROVIDE (2) 2" CONDUIT SLEEVE WITH NYLON BUSHINGS ABOVE ACCESSIBLE CEILING.TYPICAL FOR ALL LOCATIONS SHOWN ON PLANS.



10/19/20


CONSTRUCTION DOCUMENTS

EVISIONS

1 11/20/20 ADDENDUM 1 4 02/25/21 CONFORMED SET

7 05/12/21 Early Childhood

KEY PLAN

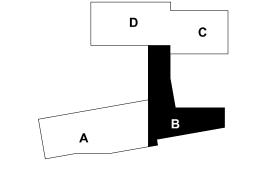




SPECIAL SYSTEMS FLOOR PLAN - LEVEL 2 - AREA B

ET107

GRAPHIC SCALE(S)

1/8" = 1' - 0"

DESIGN: MRB
DRAWN: SJB
REVIEW: SPS

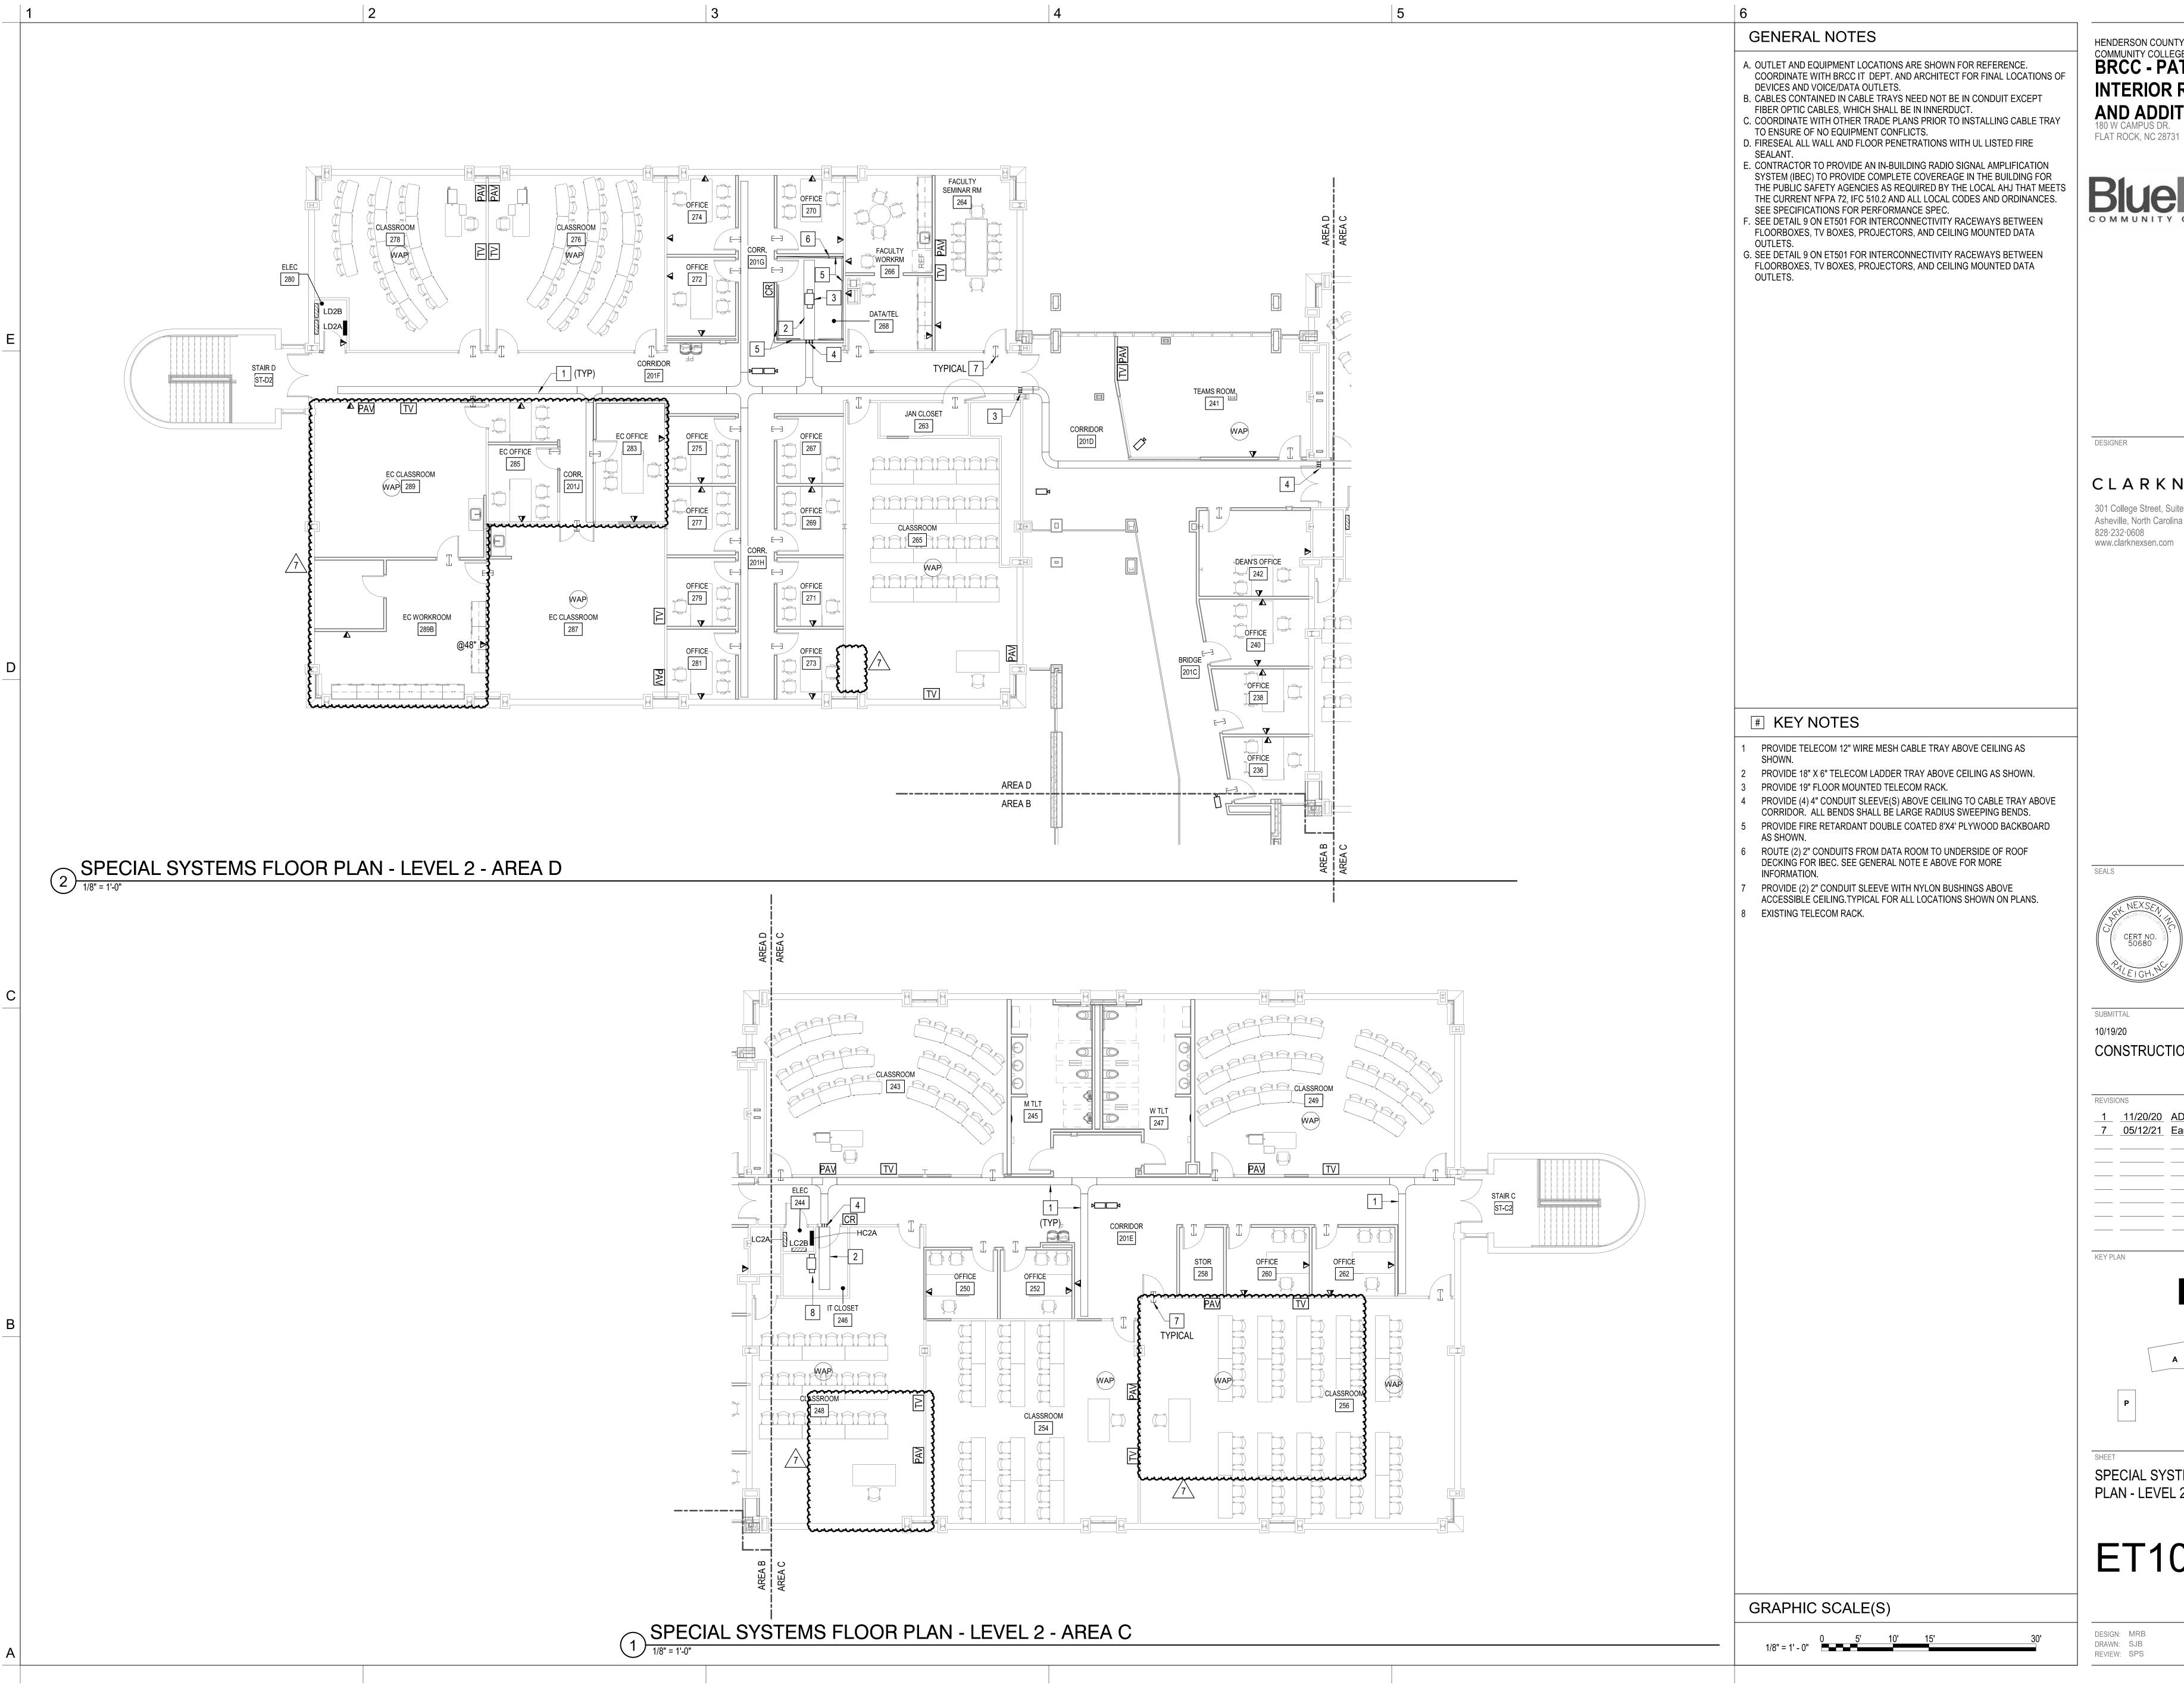

HENDERSON COUNTY AND BLUE RIDGE COMMUNITY COLLEGE

BRCC - PATTON HALL INTERIOR RENOVATION **AND ADDITION**

CLARKNEXSEN

301 College Street, Suite 300 Asheville, North Carolina 28801 www.clarknexsen.com




CONSTRUCTION DOCUMENTS

1 11/20/20 ADDENDUM 1

7 05/12/21 Early Childhood

SPECIAL SYSTEMS FLOOR PLAN - LEVEL 2 - AREA C & D

ET108

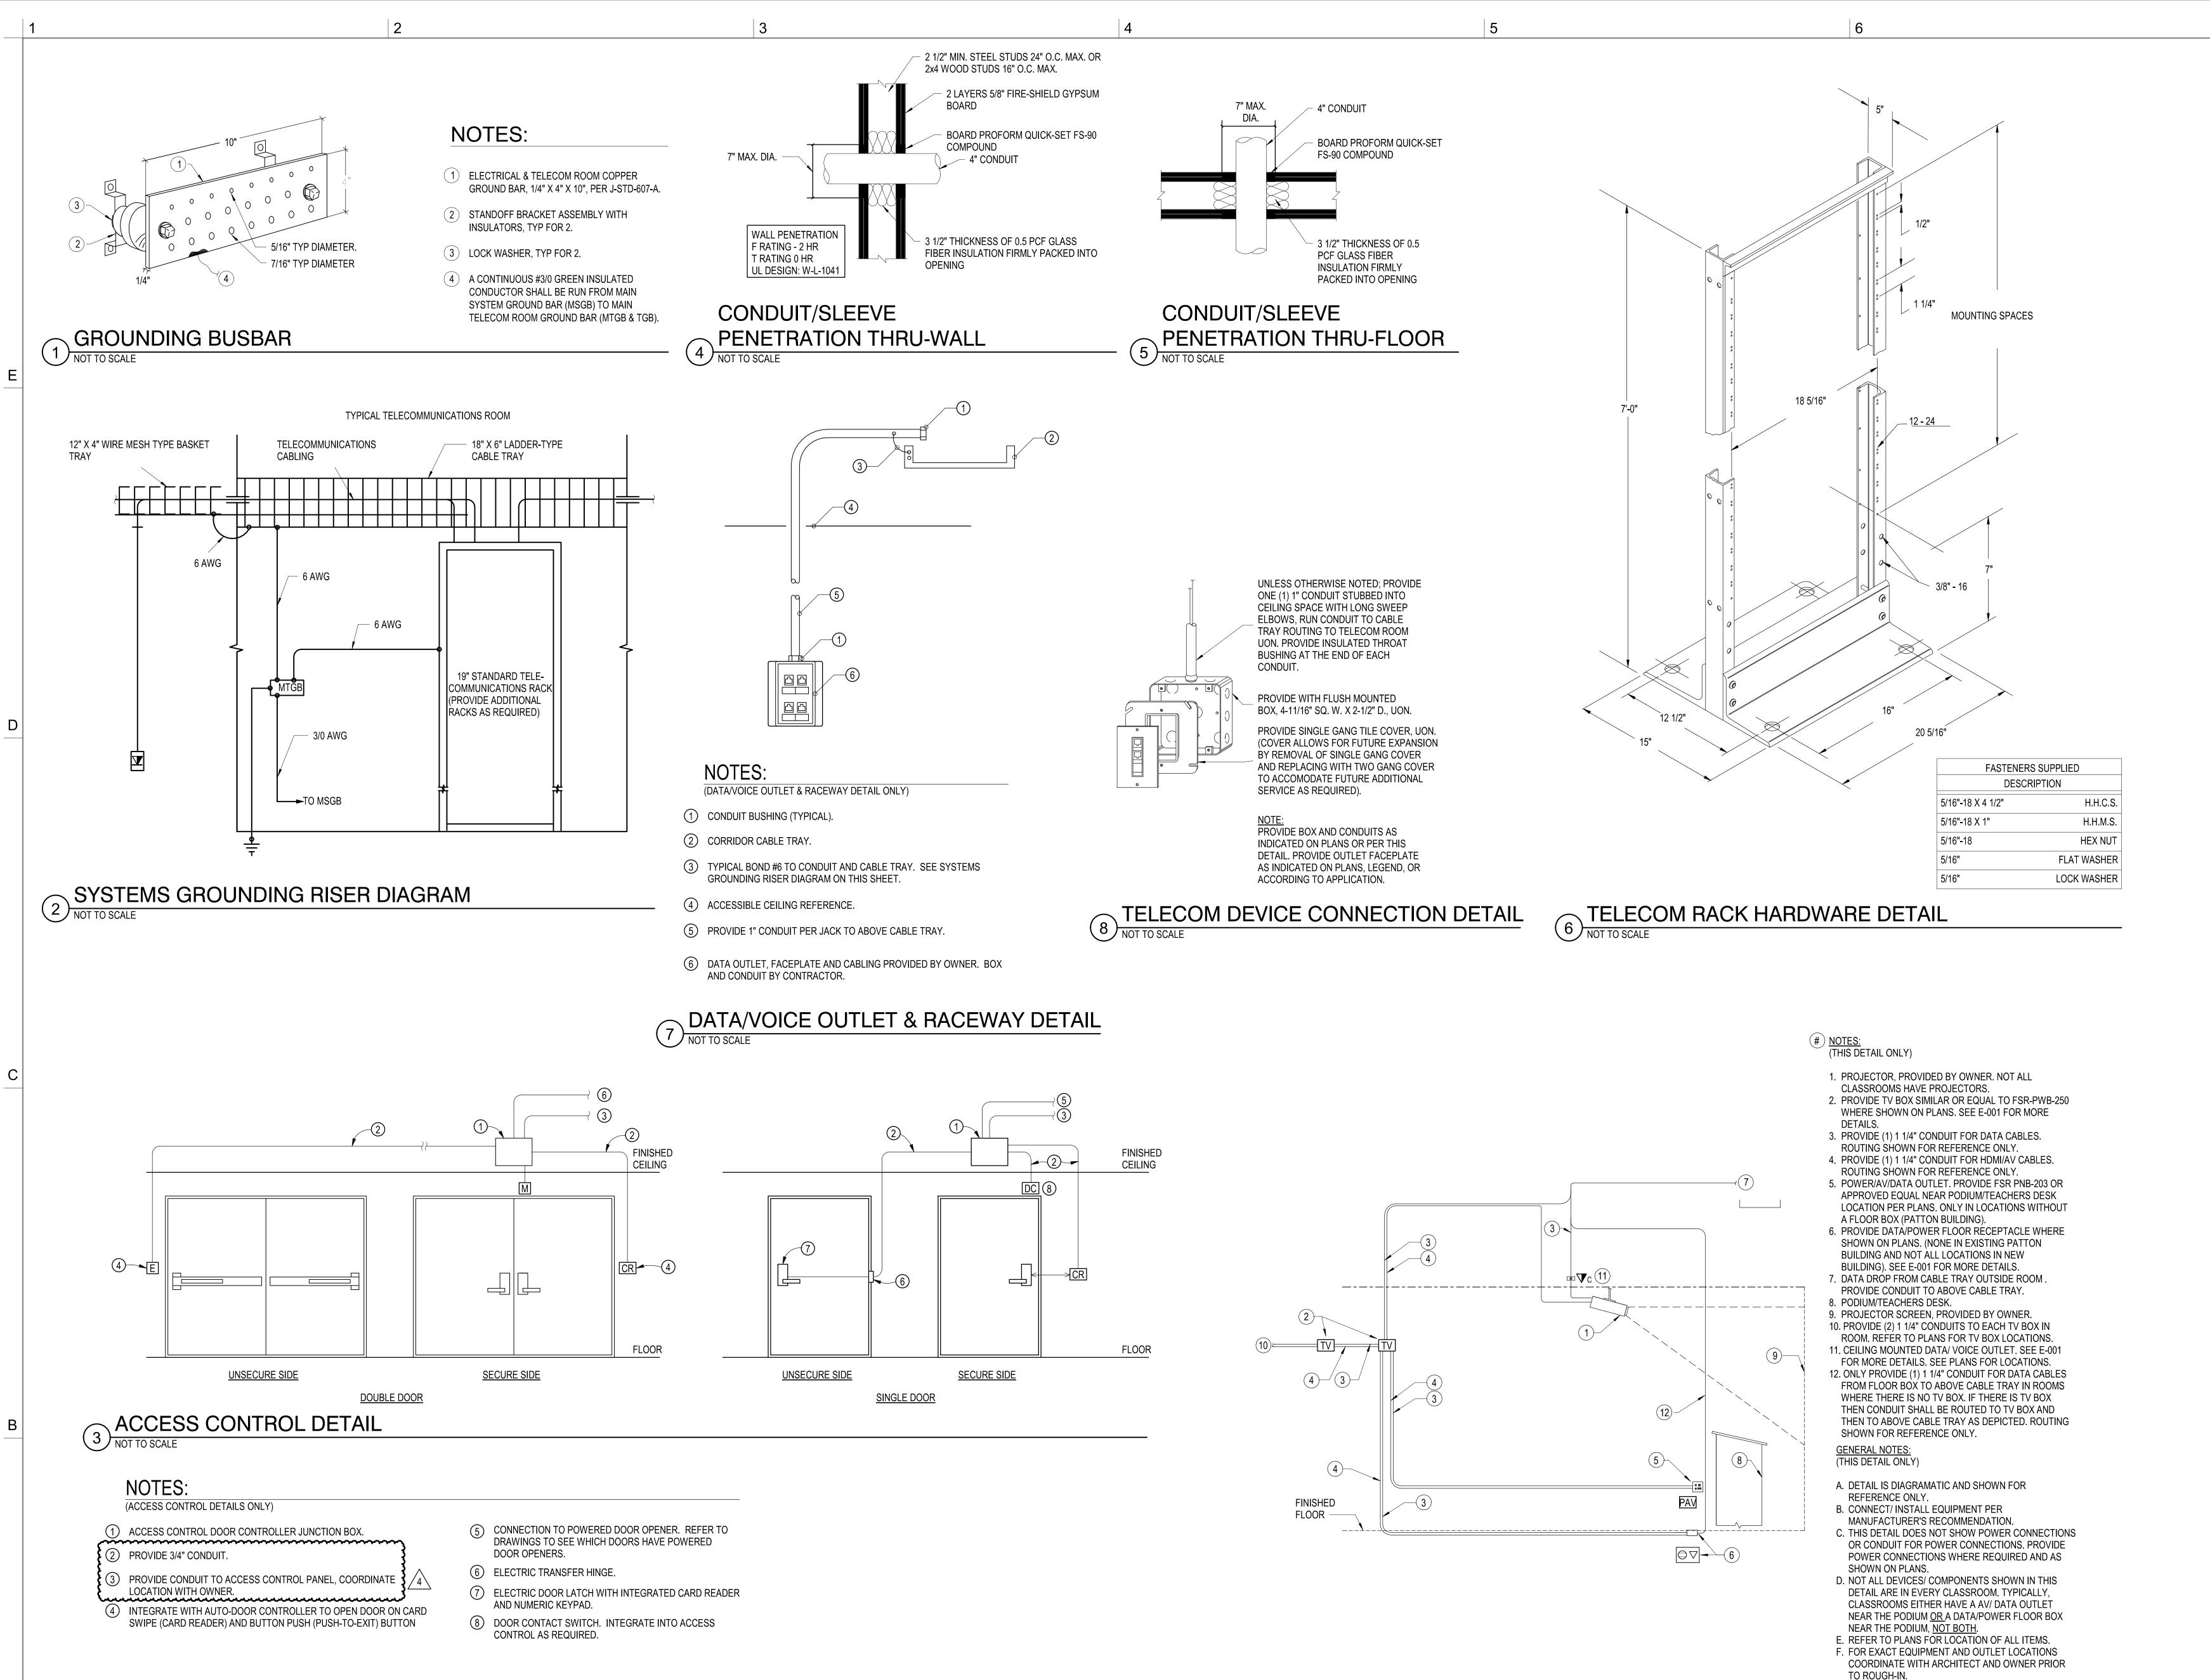

HENDERSON COUNTY AND BLUE RIDGE COMMUNITY COLLEGE **BRCC - PATTON HALL** INTERIOR RENOVATION **AND ADDITION** FLAT ROCK, NC 28731



CLARKNEXSEN

301 College Street, Suite 300 Asheville, North Carolina 28801 828-232-0608 www.clarknexsen.com

2021.02.25 10:03:27-05'00'

10/19/20

SUBMITTAL

CONSTRUCTION DOCUMENTS

1 11/20/20 ADDENDUM 1 2 11/24/20 ADDENDUM 2

4 02/25/21 CONFORMED SET

TELECOM DETAILS

ET501

DESIGN: MRB DRAWN: SJB REVIEW: SPS

G. BRANDS AND MODELS INDICATE BASIS OF DESIGN,

APPROVED EQUALS ALSO ACCEPTED.

TYPICAL CLASSROOM TECHNOLOGY DETAIL

GENERAL NOTES

A. ALL CABLES ROUTED UNDERGROUND BETWEEN BUILDINGS SHALL BE WATER-RESISTANT OF THE SAME TYPE LISTED IN THE TELECOM CABLES SCHEDULE.

KEY NOTES

- 1 PROVIDE (2) 4" CONDUIT WITH (2) 4" DETECTABLE THREE-CELL TEXTILE INNER-DUCTS FROM EXISTING DATA/TEL 154F IN EXISTING PATTON BUILDING TO NEW DATA/TEL 030C. COORDINATE WITH BRCC FOR EXACT STUB UP LOCATIONS. SEE SITE PLAN SHEET ES102 FOR MORE
- 2 PROVIDE (2) 4" CONDUIT WITH (2) 4" DETECTABLE THREE-CELL TEXTILE INNER-DUCTS FROM NEW TELE 154A IN EXISTING PATTON BUILDING TO NEW DATA/TEL 030C. COORDINATE WITH BRCC FOR EXACT STUB UP LOCATIONS. SEE SITE PLAN SHEET ES102 FOR MORE INFORMATION.
- 3 PROVIDE PROTECTION MODULE FOR 50-PAIR COPPER BACKBONE.
 4 PROVIDE TERMINATION WITH BUSHING.
- PROVIDE TERMINATION WITH BUSHING.
- 5 PROVIDE 50-PAIR PUNCH DOWN BLOCK IN CABINET.
 6 PROVIDE (1) 3" CONDUIT FOR COPPER BACKBONE CABLE.
- 7 PROVIDE FIRE-RETARDANT DOUBLE-COATED 8'X4' PLYWOOD BACKBOARD AS SHOWN ON SPECIAL SYSTEMS FLOOR PLANS.
- 8 PROVIDE 19" FLOOR MOUNTED TELECOM RACK AS SHOWN ON SPECIAL
- SYSTEMS FLOOR PLANS AND PER DETAILS 6 ON SHEET ET501.

 9 TYPICAL DATA OUTLET SHOWN FOR REFERENCE. PROVIDE TELECOM
- JUNCTION BOX FLUSH WITH SURFACE PER DETAIL 8 ON SHEET ET501.

 10 PROVIDE (2) 4" CONDUIT WITH (2) 4" DETECTABLE THREE-CELL TEXTILE
- INNER-DUCTS FROM NEW DATA/TEL 030C TO NEW TECH BOOTH 002A.
 COORDINATE WITH BRCC FOR EXACT STUB UP LOCATIONS.

 11 PROVIDE 24"W X 26"D X 48"H WALL MOUNTED TELECOM RACK AS SHOWN
- ON SPECIAL SYSTEMS FLOOR PLAN ET102.

 12 PROVIDE 18" X 6" LADDER-TYPE TELECOM CABLE TRAY AS SHOWN ON
- SPECIAL SYSTEMS FLOOR PLANS.

 13 PROVIDE 12" X 4" WIRE-MESH TYPE TELECOM CABLE-TRAY AS SHOWN ON
- SPECIAL SYSTEMS FLOOR PLANS.

 14 PROVIDE (1) 1" CONDUIT FROM TELECOM JUNCTION BOX TO ABOVE CABLE
- TRAY. SEE DETAIL 7 ON SHEET ET501.

 15 DATA CABLING SHOWN FOR REFERENCE ONLY. ALL CABLING BY OWNER
- UNLESS OTHERWISE NOTED.

 16 PROVIDE (2) 4" CONDUIT WITH (4) 1" INNERDUCTS FOR FIBER OPTIC
- CABLE(S). COORDINATE WITH (4) THINNERDOCTS FOR FIBER OF TO CABLE(S). COORDINATE WITH BRCC FOR EXACT STUB UP LOCATIONS.

 17 PROVIDE 4" FIRE STOP CONDUIT SLEEVES ABOVE CEILING (THROUGH WALLS) AS SHOWN ON SPECIAL SYSTEMS FLOOR PLANS. SEE DETAIL 4 ON
- 18 PROVIDE 4" FIRE STOP CONDUIT SLEEVES THROUGH FLOOR AS SHOWN.
- SEE DETAIL 5 ON SHEET ET501.

 19 EXISTING TELEPHONE BACKBOARD TO REMAIN.
- 20 EXISTING AT&T FIBER AND COPPER SERVICE ENTRANCE IN METAL FLOOR BOX TO REMAIN.
- 21 EXISTING DATA RACK(S) TO REMAIN.
- 22 EXISTING CABLE RUN TO REMAIN.

SHEET ET501.

TELECOM CABLES

ONE (1) VOICE 50-PAIR UTP 100-OHM CAT-5E 100MHZ (MIN) CMR.

HENDERSON COUNTY AND BLUE RIDGE
COMMUNITY COLLEGE
BRCC - PATTON HALL
INTERIOR RENOVATION
AND ADDITION


180 W CAMPUS DR. FLAT ROCK, NC 28731



CLARKNEXSEN

301 College Street, Suite 300 Asheville, North Carolina 28801 828·232·0608 www.clarknexsen.com

DESIGNER

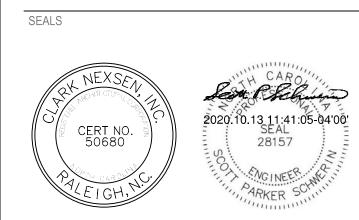


10/19/20

CONSTRUCTION DOCUMENTS

REVISIONS

D C

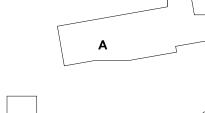




IT RISER DIAGRAM WINGS A &

ET701

DESIGN: MRB
DRAWN: SJB
REVIEW: SPS

CN 5199-L

/2020 9:21:33 Alvi vit Projects\5199-L-BRCC_E20_stefan.bajai

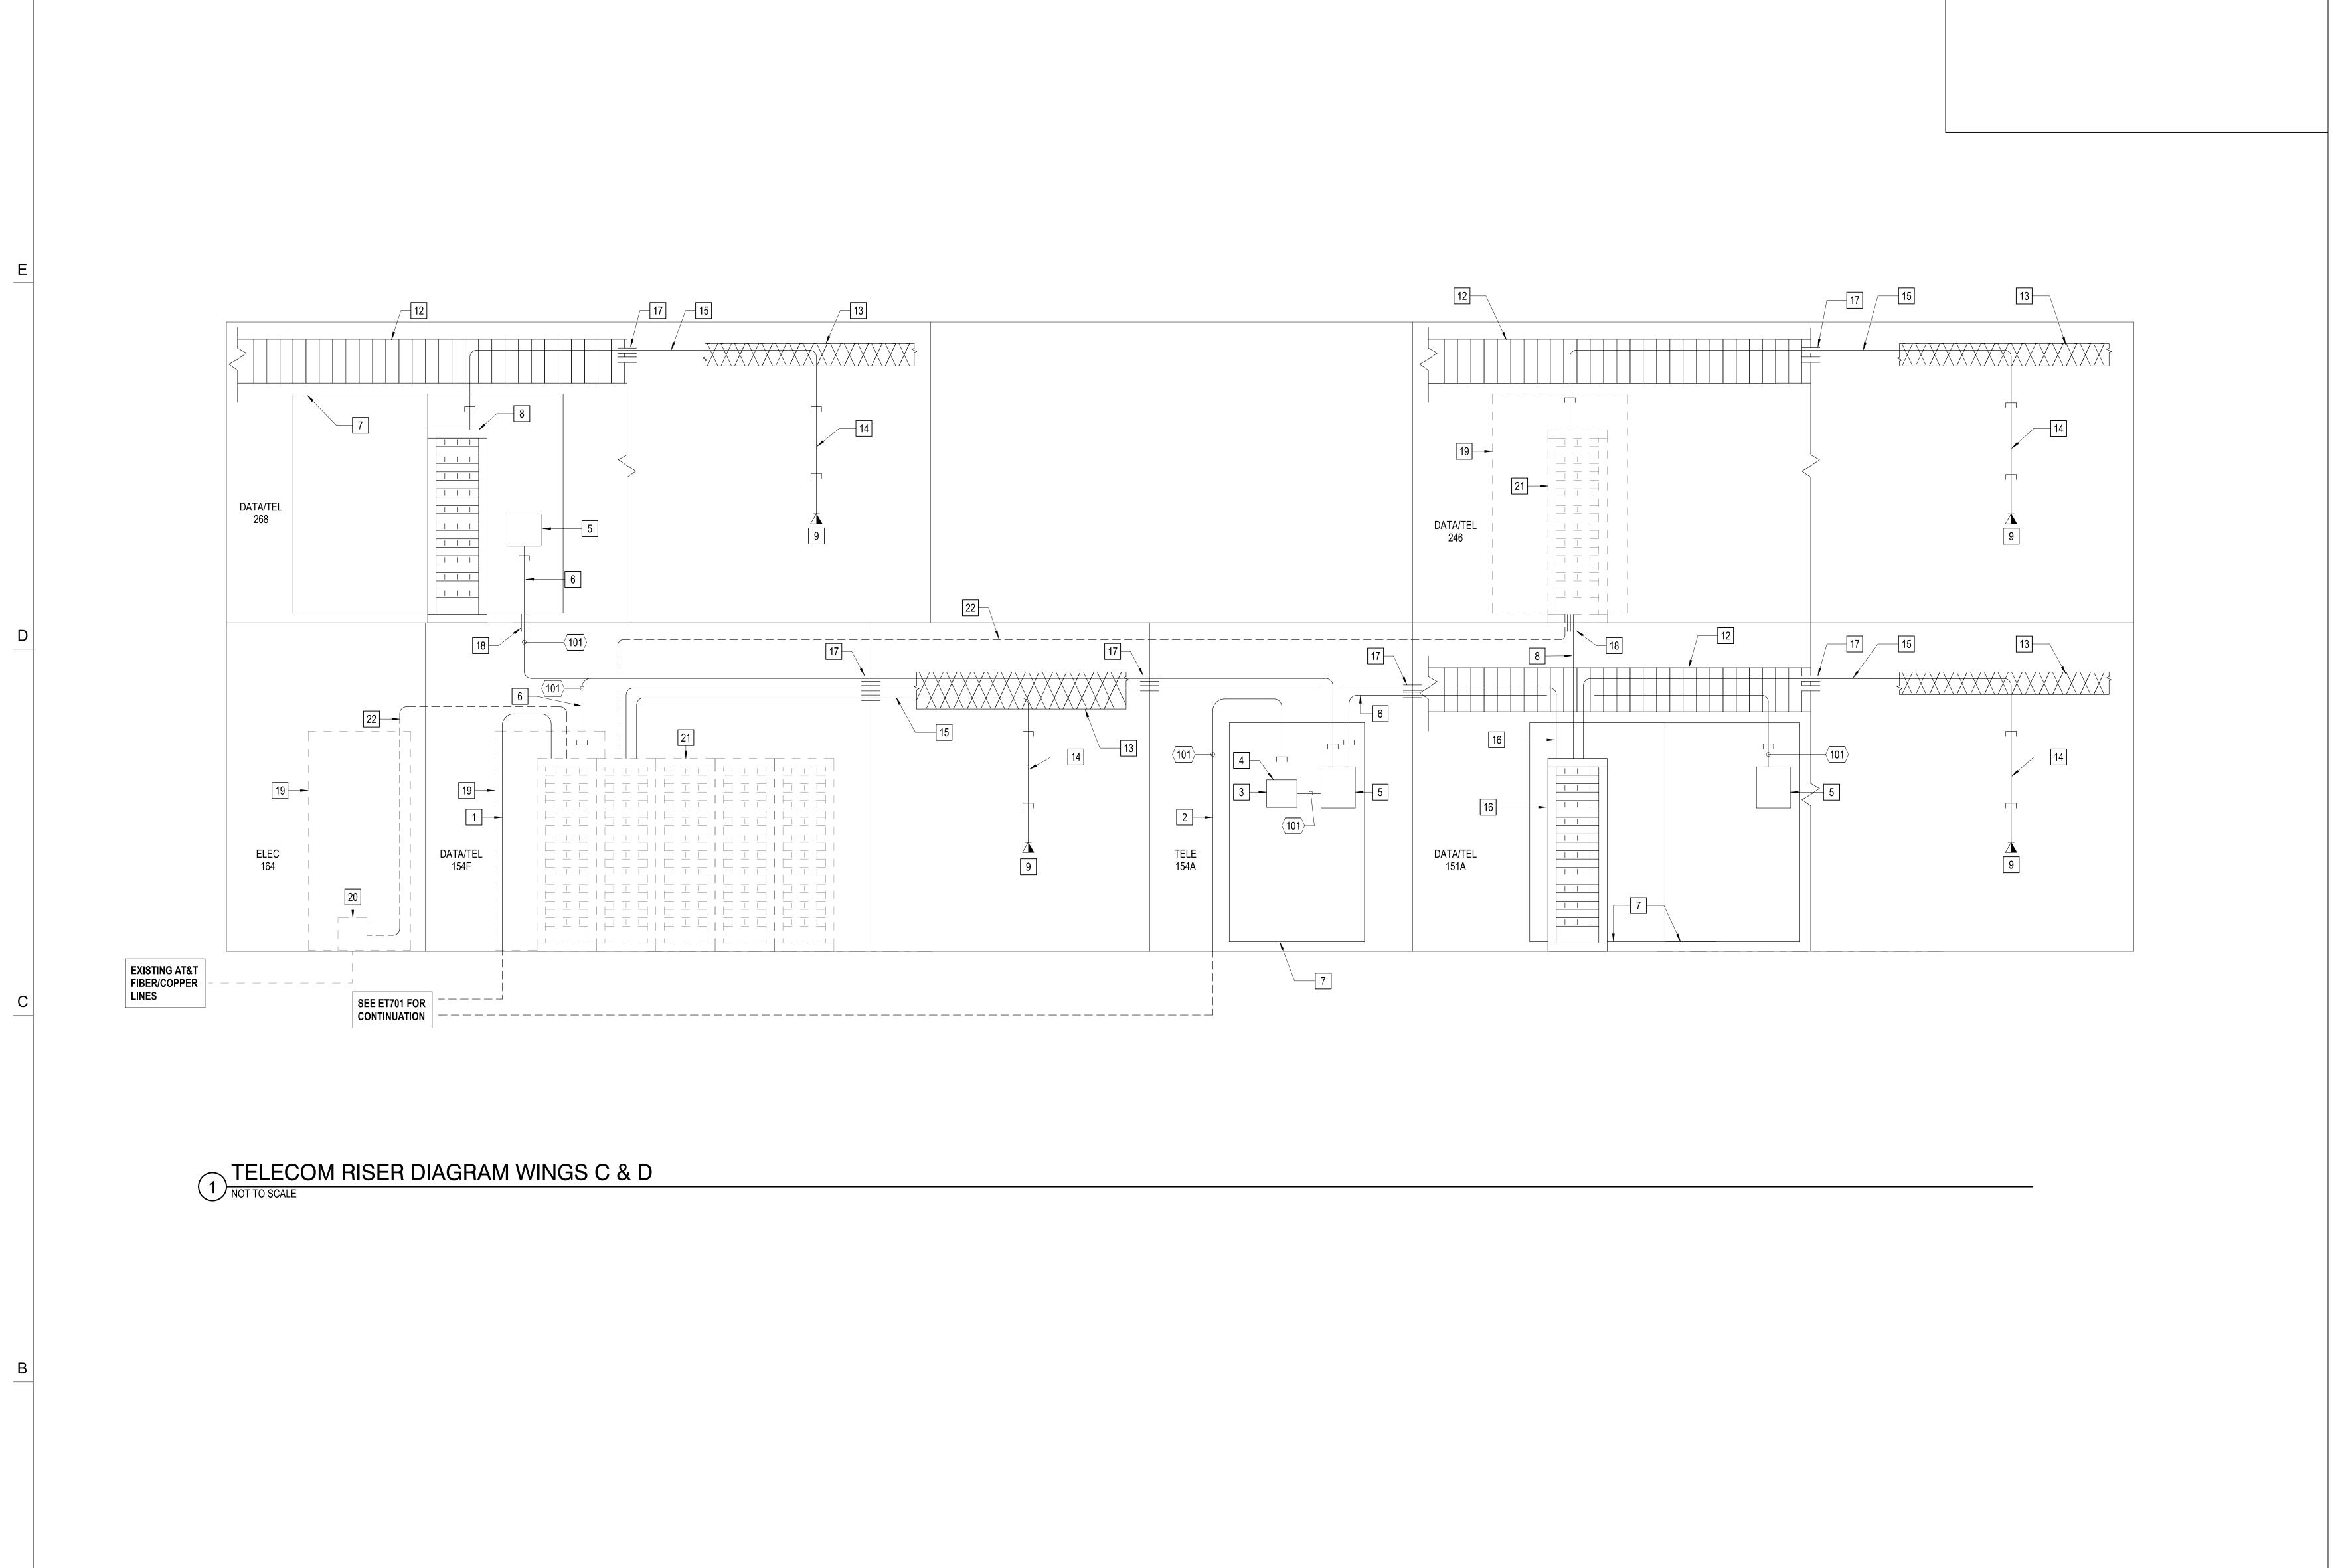

HENDERSON COUNTY AND BLUE RIDGE
COMMUNITY COLLEGE
BRCC - PATTON HALL
INTERIOR RENOVATION
AND ADDITION
180 W CAMPUS DR.
FLAT ROCK, NC 28731

GENERAL NOTES

A. SEE SHEET ET701 FOR KEY NOTES, GENERAL NOTES AND TELECOM CABLES SCHEDULES.

BlueRidge

CLARKNEXSEN

301 College Street, Suite 300
Asheville, North Carolina 28801
828·232·0608
www.clarknexsen.com

EALS



10/19/20

CONSTRUCTION DOCUMENTS

REVISIONS

D C

Р

IT RISER DIAGRAM WINGS C & D

ET702

DESIGN: Designer
DRAWN: Author
REVIEW: Checker